

JOISTS/BEAMS PARALLEL TO WALL

JOISTS/BEAMS PERPENDICULAR TO WALL


- NOTES:
1. THIS DETAIL APPLIES WHERE THE DISTANCE BETWEEN INTERSECTING WALLS EXCEEDS 8'-0" FOR 8" CMU OR LARGER AND 6'-0" FOR 6" CMU.
 2. SPACE BRACES @ 10'-0" o.c. FOR 8" CMU AND 8'-0" o.c. FOR 6" CMU.
 3. FOR 8" CMU
 - 4.

**TYP. O
DETAIL**
2
A301

Temp wall panels to be provided, installed and removed by metal framing/drywall subcontractor. Temp walls to be used during exterior wall demo and re-build.

Construction: Metal stud frame, plywood skin (both sides), with Tyvek for weatherproofing on exterior side and peel and stick waterproofing at bottom for weather barrier. Brace top back to exterior wall.


U WALL

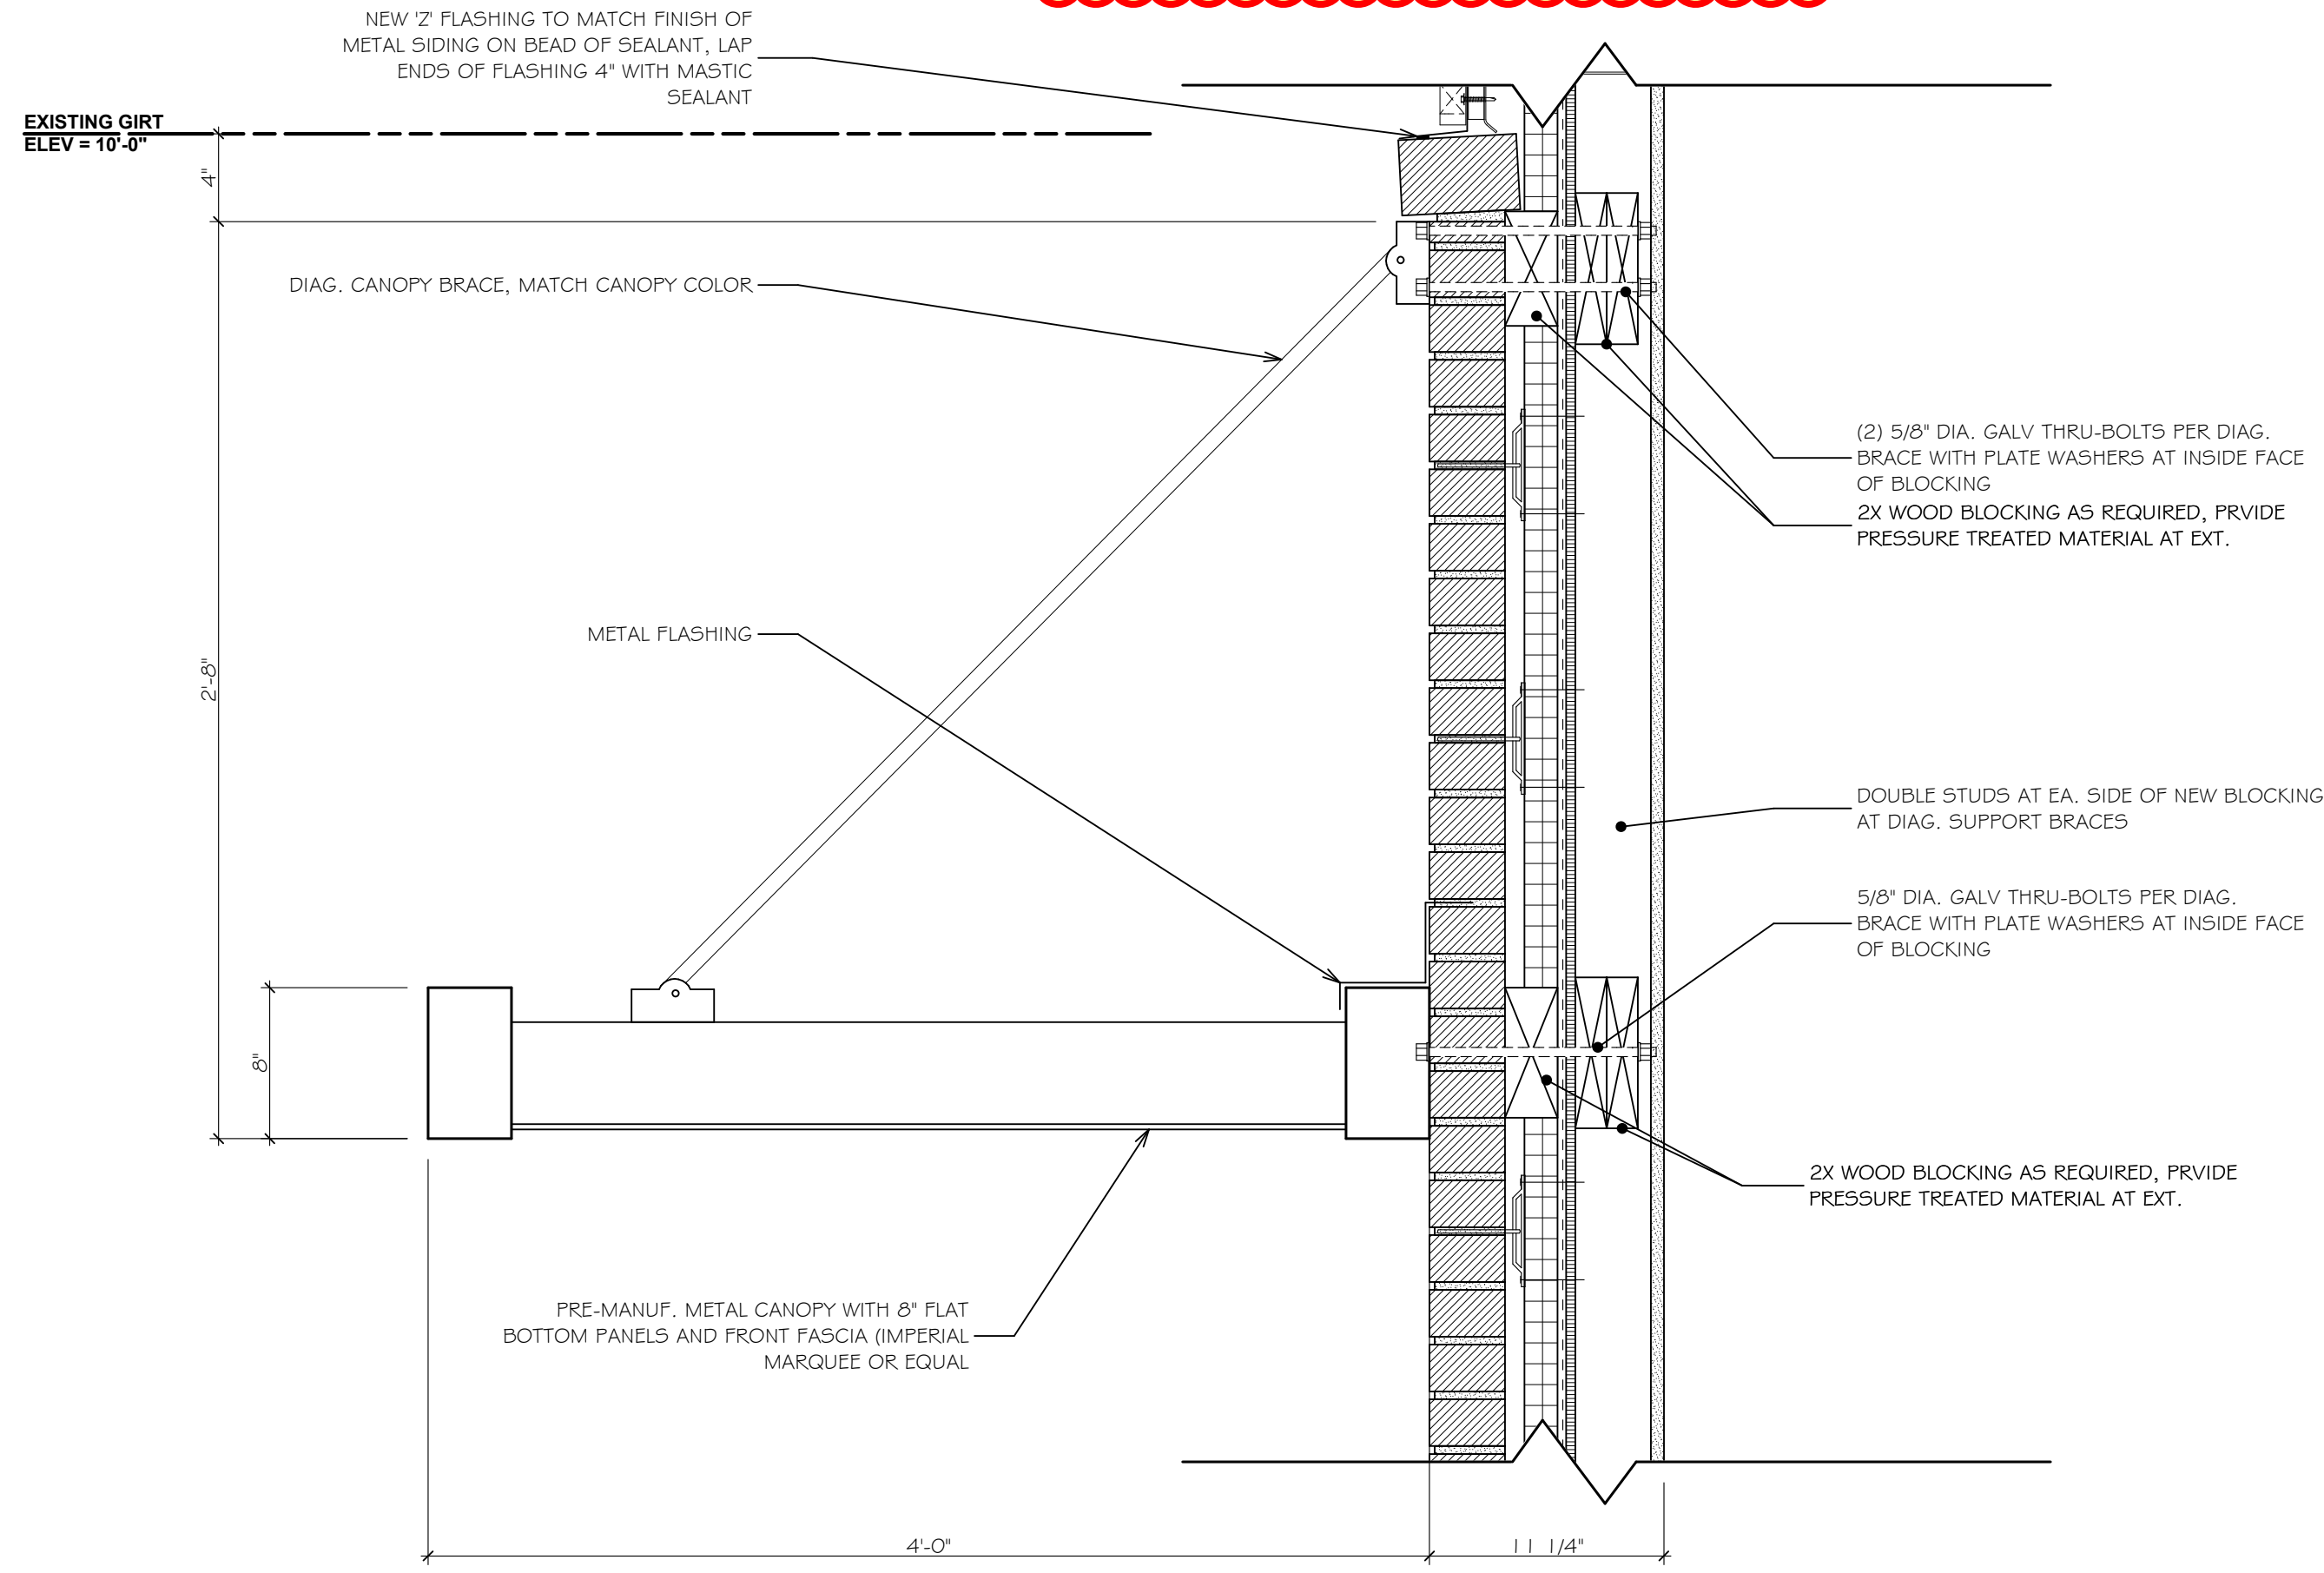

NOTE: DESIGN BASED ON GENERAL AWNINGS 'IMPERIAL MARQUEE' PRODUCT.


ALUM. CANOPY DETAIL
1
A301

SCALE: 1 1/2" = 1'-0"

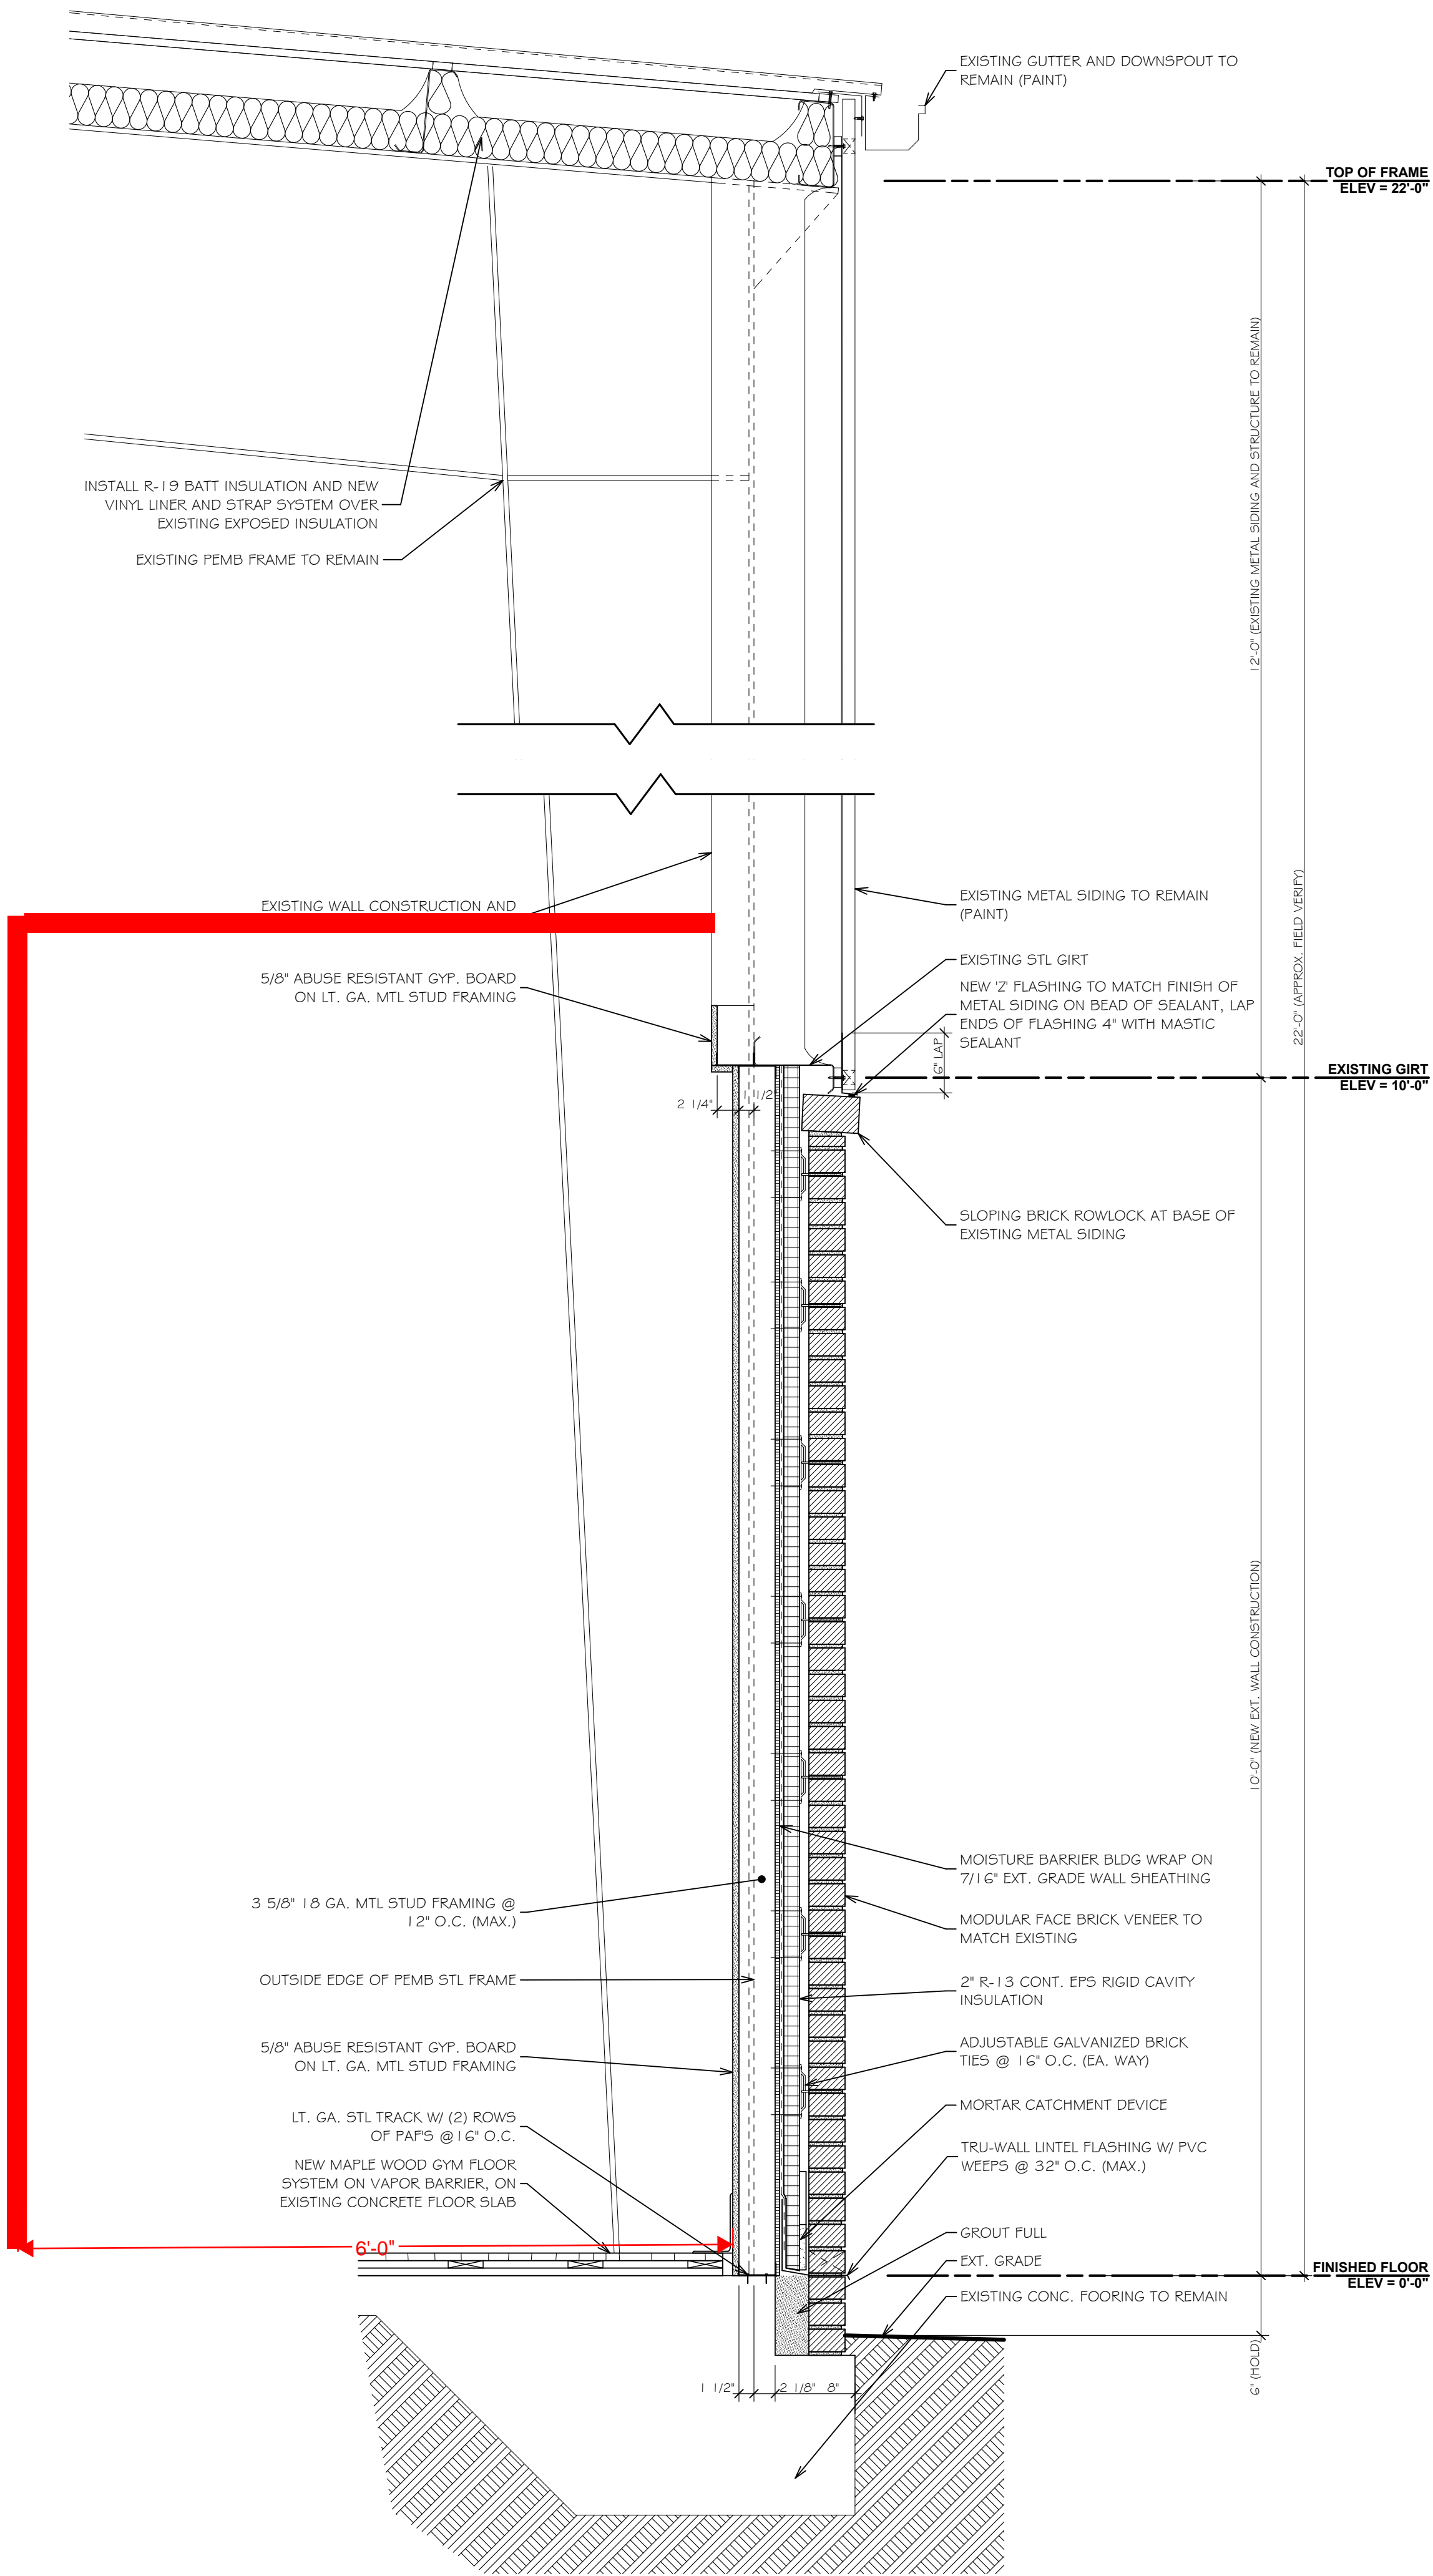

TYP. WALL SECTION
A
A301

SCALE: 1" = 1'-0"

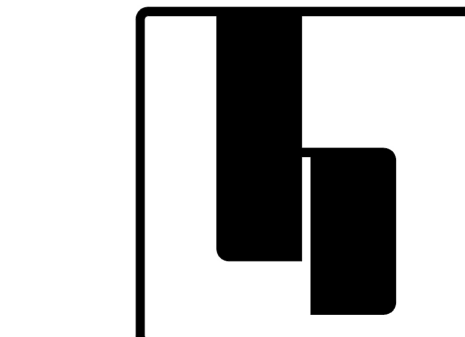

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■ ARCHITECTURE ■ PLANNING

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CONSULTANTS

RENOVATIONS TO

**GRACE
BAPTIST
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WILMINGTON
NORTH CAROLINA

HOSTELLER ARCHITECTURE
STATE REGISTRATION



ARCHITECT OF RECORD
SHAWN E. HOSTELLER
11926



CONSTRUCTION DOCUMENTS : 02.08.19

REVISIONS		
MARK	DATE	DESCRIPTION
△		
△		
△		
△		
DRAWN BY:		PROJ. MGR:
SHEET CONTENT		

WALL SECTIONS, DETAILS

JOB NO.
18013

SHEET
A301