INSURANCE, ETC., REQUIRED FOR EXECUTION OF THIS WORK. ELECTRICAL CONTRACTOR SHALL PROVIDE THE MATERIALS, PERFORM THE WORK AND TEST AND PAY ALL FEES NECESSARY TO MAKE THE ELECTRICAL SYSTEM OPERABLE AND READY FOR USE BY THE OWNER. GUARANTEE: EQUIPMENT, MATERIALS AND INSTALLATION SHALL BE GUARANTEED TO BE FREE OF DEFECTS FOR A PERIOD OF ONE (1) YEAR AFTER FINAL ACCEPTANCE OF WORK OR IN ACCORDANCE WITH THE MANUFACTURER'S STANDARD GUARANTEE, IF LONGER.

IT IS UNDERSTOOD AND AGREED THAT THESE PLANS AND SPECIFICATIONS SHALL BE FULFILLED IN THEIR TRUE SPIRIT AND INTENT SO THAT ANY MINOR MATERIALS OR DEVICES ESSENTIAL TO PROPER AND CONVENIENT OPERATION, REQUIRED OR IMPLIED. SHALL BE SUPPLIED AND INSTALLED BY THE CONTRACTOR WITHOUT EXTRA CHARGE. EVEN THOUGH NOT SPECIFICALLY CALLED OUT.

INSTALLATION SHALL COMPLY WITH OSHA STANDARDS. THE ELECTRICAL CONTRACTOR SHALL BE RESPONSIBLE FOR HIS OWN CLEAN UP AND REMOVAL OF SCRAP FROM THE JOB SITE. THE ELECTRICAL CONTRACTOR SHALL MAINTAIN A CLEAN AND SAFE WORK AREA. THE

ENGINEER IS NOT RESPONSIBLE FOR JOB SITE SAFETY. IN CASE OF CONFLICT BETWEEN THE PLANS AND SPECIFICATIONS OR CONFLICT BETWEEN INFORMATION PRESENTED ON THE PLANS OR IN THE SPECIFICATIONS, THEN THE MOST RESTRICTIVE SHALL TAKE

PRECEDENT DIVISION I SHALL BECOME APART OF THESE SPECIFICATIONS BY REFERENCE.

ALL ELECTRICAL COMPONENTS SHALL BE INSTALLED, SUPPORTED, AND RESTRAINED IN ACCORDANCE WITH THE NORTH CAROLINA BUILDING CODE REQUIREMENTS FOR SEISMIC DESIGN. IT SHALL BE THE RESPONSIBILITY OF THE CONTRACTOR TO RETAIN A PROFESSIONAL ENGINEER COMPETENT IN THIS FIELD FOR THIS DESIGN. FOR ONE POSSIBLE SOURCE FOR THIS SERVICE CONTACT SEISMIC CONTROL AND ISOLATIONS, INC. PHONE: 910 799-5204. ALL REQUIRED INSPECTIONS FOR THESE DESIGNS SHALL BE PERFORMED BY APPROVED INSPECTORS AND AGENCIES PROVIDED BY OWNER AND OWNER'S AGENT.

WORK SHALL INCLUDE BUT IS NOT LIMITED TO:

PROVIDE 120/208V-3-4W SERVICE TO THE BUILDING. PROVIDE AND INSTALL FIXTURES AS SHOWN ON THE PLANS.

PROVIDE AND INSTALL WIRING DEVICES, PANELS, AND CONDUIT. PROVIDE AND INSTALL TELEPHONE PANEL, CONDUIT TO TELEPHONE COMPANY POINT OF DELIVERY,

TELEPHONE BOXES. PROVIDE CONNECTIONS TO MECHANICAL, AND PLUMBING EQUIPMENT. PROVIDE REQUIRED DEMOLITION.

1603 MATERIALS

CONDUCTORS ALL WIRE SHALL BE COPPER. WIRE #8 AND LARGER SHALL BE STRANDED.

USE WIRE WITH THHN/THWN INSULATION FOR ALL WIRE. POWER CONDUCTORS SHALL BE #12 AWG MINIMUM. PILOT AND CONTROL CIRCUITS MAY BE #14 AWG.

UNDERGROUND CONDUIT SHALL BE PVC. CHANGE TO RIGID GALVANIZED BELOW CONCRETE FLOOR AND STUB UP THROUGH FLOOR WITH RIGID GALVANIZED. ARMOR CLAD CABLE SHALL BE ALLOWED IN CONCEALED AREAS. OTHER ABOVE GRADE CONDUIT SHALL BE EMT WITH STEEL COMPRESSION FITTINGS. IF EXPOSED TO

MECHANICAL DAMAGE CONDUIT SHALL BE RIGID GALVANIZED. CONNECTIONS TO EQUIPMENT AND FIXTURES SHALL BE MADE WITH SEAL TIGHT FLEX CONDUIT FOR EXTERIOR CONNECTIONS AND GREENFIELD FOR INTERIOR CONNECTION. WIRING DEVICES SHALL BE ONE MAKE, UNDERWRITERS APPROVED, MANUFACTURED BY PASS & SEYMOUR,

HUBBELL OR EQUAL. DEVICE COVERS SHALL BE WEATHERPROOF FOR EXTERIOR COVERS. WIRING DEVICES SHALL BE STANDARD GRADE. COLOR SHALL BE DETERMINED BY THE ARCHITECT. DISTRIBUTION EQUIPMENT SHALL BE THE LATEST PRODUCTS, MANUFACTURER SHALL BE G.E., SQUARE D, WESTINGHOUSE, OR ITE. INTERIOR EQUIPMENT SHALL BE NEMA 1 AND EXTERIOR EQUIPMENT SHALL BE NEMA

3R MINIMUM. COORDINATE WITH POWER COMPANY TO OBTAIN BREAKER KAIC RATINGS. DRAWINGS SHALL INDICATE MINIMUM RATING. ALL BREAKERS SHALL BE BOLT ON TYPE. MAIN PANEL SHALL BE SERVICE ENTRY RATED AND

LABELED. BREAKERS SHALL BE SERIES AND CURRENT LIMITING RATED. PROVIDE MOTOR RATED SWITCHES FOR SWITCHES SERVING MOTORS AS REQUIRED. FUSES SHALL BE CURRENT LIMITING TIME DELAY FUSES "CLASS RK5".

ALL EQUIPMENT AND FIXTURES SHALL BE UL APPROVED. PROVIDE LAMPS FOR ALL FIXTURES. LAMPS SHALL BE G.E., OR SYLVANIA.

UNLESS OTHERWISE NOTED, SET ALL RECEPTACLES SET ALL RECEPTACLES AT 16" AFF TO CENTER OF OUTLET BOX, AND SET ALL SWITCHES AT 48" AFF TO TOP OF OUTLET BOX. ALL OTHER HEIGHTS ARE TO CENTER OF BOX UNLESS NOTED OTHERWISE. HOLES SHALL BE DRILLED OR CUT. DO NOT BREAK HOLES.

THE ELECTRICAL CONTRACTOR SHALL DO ALL CUTTING, PATCHING AND PAINTING NECESSARY TO INSTALL ALL EQUIPMENT AS REQUIRED UNDER THIS CONTRACT, AND SHALL ESTABLISH ALL FINISHES WHEN CUTTING AND PATCHING OCCUR TO THEIR ORIGINAL CONDITION. QUALIFIED WORKERS SHALL DO ALL CUTTING AND PATCHING WORK (I.E. DRY WALL CUTTING AND PATCHING SHALL BE DONE BY QUALIFIED DRY WALL

PATCHING SHALL BE DONE BY THE ELECTRICAL CONTRACTOR. ALL PATCHING SHALL BE DONE BY A CRAFTSMAN SKILLED IN THE WORK BEING PERFORMED.

E. WIRE SHALL BE COLOR CODED AS FOLLOWS:

120/208 BLACK PHASE A PHASE B RED PHASE C BLUE NEUTRAL WHITE

GREEN

GROUND

CONTRACTOR SHALL CONFIRM THE LOCATION OF ALL EQUIPMENT AND POWER REQUIREMENTS FOR ALL

EQUIPMENT BEFORE RUNNING SERVICE. CONDUIT AND WIRING IN FINISHED AREAS SHALL BE CONCEALED. ANY EXPOSED CONDUIT SHALL BE RUN IN A NEAT FASHION AND SHALL BE RUN PERPENDICULAR AND PARALLEL TO THE BUILDING LINES. TELEPHONE AND COMPUTER OUTLETS SHALL BE DUPLEX RECEPTACLE BOXES WITH 3/4" EMT STUBBED INTO

THE CEILING WITH PULL STRINGS INSTALLED. CONTRACTOR SHALL PRESERVE ALL FIRE RATED WALLS AND CEILINGS. VERIFY RATING WAS OFF THE ARCHITECTURAL PLAN. THIS SHALL INCLUDE USING CAULKING THAT IS UL APPROVED FOR THE APPLICATIONS, OFFSETTING BOXES AS REQUIRED AND PROVIDING RATED CAPS OR COVERS FOR LIGHTS, AS

DIRECTORY CARDS, NAME PLATES & EQUIPMENT LABELS PROVIDE A TYPED DIRECTORY CARD IN EACH PANELBOARD INDICATING ELECTRICAL DEVICES OR EQUIPMENT

SERVED BY EACH CIRCUIT BREAKER. FURNISH BLANK COVERPLATE. PROVIDE NAMEPLATES FOR PANELS AND DISCONNECTS. NAMEPLATES SHALL BE LAMINATED PLASTIC. EACH NAMEPLATE SHALL IDENTIFY THE PANEL AND THE VOLTAGE. NAMEPLATES SHALL BE MELAMINE PLASTIC, O. 125 INCH THICK, BLACK WITH WHITE CENTER CORE. SURFACE SHALL BE MATTE FINISH. CORNERS SHALL BE SQUARE. ACCURATELY ALIGN LETTERING AND ENGRAVE INTO CORE. MINIMUM SIZE OF NAMEPLATES SHALL BE 1X2.5 INCHES. LETTERING SHALL BE A MINIMUM OF 0.25 INCHES HIGH, NORMAL BLOCK STYLE.

TEST & ADJUSTMENTS TEST AND ADJUST THE ELECTRICAL SYSTEM AND RELATED WORK PROVIDED UNDER THIS DIVISION OF THE SPECIFICATIONS.

TEST ALL CIRCUITS WITH A "MEGGER" TEST TO DETERMINE THAT THE SYSTEM IS FREE OF SHORT CIRCUITS AND THAT PHASE CONDUCTORS ARE NOT GROUNDED. CHECK ALL ELECTRICAL EQUIPMENT FOR PROPER

THE SERVICE EQUIPMENT, CONDUIT SYSTEM SUPPORT CABINETS, EQUIPMENT AND NEUTRAL CONDUCTOR SHALL BE GROUNDED IN ACCORDANCE WITH ARTICLE 250 OF THE LATEST EDITION OF THE NATIONAL ELECTRIC CODE. GROUNDING CONDUCTORS SHALL BE SO ROUTED AS TO PERMIT, AS FAR AS PRACTICAL, THE SHORTEST AND MOST DIRECT PATH TO THE GROUND ELECTRODE SYSTEM. ALL GROUND CONNECTIONS SHALL HAVE A CLEAN CONTACT SURFACE.

B. RUN A SEPARATE EQUIPMENT GROUND IN ALL FEEDS.

ALL MATERIALS SHALL BE NEW UNLESS OTHERWISE SHOWN OR SPECIFIED AND SHALL BE OF THE VERY BEST

QUALITY AS SPECIFIED. REQUESTS TO SUBSTITUTE OTHER MATERIALS OR PRODUCTS FOR THOSE SPECIFIED SHALL BE SENT IN WRITING TO THE OWNER. REQUESTS SHALL BE ACCOMPANIED BY ENGINEERING DATA. SPECIFICATION SHEETS, ETC., AS NECESSARY TO FULLY IDENTIFY AND APPRAISE THE PRODUCTS.

APPROVAL OF EQUIPMENT WILL NOT RELIEVE THE CONTRACTOR OF NONCOMPLIANCE WITH THE SPECIFICATIONS EVEN IF SUCH APPROVAL IS MADE IN WRITING, UNLESS THE ENGINEER IS CALLED TO THE NONCONFORMING FEATURES BY LETTER ACCOMPANYING THE SUBMITTAL DATA.

ALL BIDDERS ON THIS WORK SHALL VISIT THE SITE AND THOROUGHLY FAMILIARIZE THEMSELVES WITH EXISTING CONDITIONS BEFORE SUBMITTING THEIR BIDS. NO ALLOWANCE WILL BE MADE FOR LACK OF KNOWLEDGE OF EXISTING CONDITION.

SHOP DRAWINGS AS SOON AS POSSIBLE (AND NOT MORE THAN 30 DAYS) AFTER THE CONTRACT IS SIGNED, THE CONTRACTOR SHALL SUBMIT FIVE (5) COPIES OF THE SHOP DRAWINGS COVERING LIGHTING FIXTURES, PANELS, CIRCUIT, BREAKERS, AND WIRING DEVICES, AND ANY SPECIAL EQUIPMENT WHICH HE INTENDS TO USE. SHOP DRAWINGS SHALL BE SUBMITTED TO THE OWNER FOR HIS APPROVAL.

•	ELEC.	TRICAL LEGEND
	SYMBOL	DESCRIPTION
	0	CEILING OUTLET WITH LED FIXTURE
	정	WALL OUTLET WITH INCANDESCENT, FLUORESCENT OR LED FIXTURE
	0	CEILING OUTLET WITH INCANDESCENT, FLUORESCENT OR LED FIXTURE
	S	SWITCH, SINGLE POLE, 120VAC, MOUNTED AT 48" AFF TO TOP OF OUTLET BOX
	S2	TWO POLE SWITCH, 250VAC, MOUNTED AT 48" AFF TO TOP OF OUTLET BOX
	Sos	OCCUPANCY SENSOR WITH ON/OFF SWITCH, MOUNTED AT 48" AFF TO CENTER OF OUTLET BOX, LUTRON OR EQUAL
	SWP	SWITCH, SINGLE POLE, 120VAC, IN WEATHER PROOF ENCLOSURE, MOUNTED AT 48" AFF TO TOP OF OUTLET BOX
1	Si	SWITCH, THREE WAY, 120VAC, MOUNTED AT 48" AFF TO TOP OF OUTLET BOX
	Dos	DIMMER WITH OCCUPANCY SENSOR AND ON/OFF SWITCH, MOUNTED AT 48" AFF TO CENTER OF OUTLET BOX, LUTRON OR EQUAL
	<u>®</u>	OCCUPANCY SENSOR, LOW VOLTAGE, CEILING MOUNT, LUTRON OR EQUAL
	\$	DUPLEX CONVENIENCE RECEPTACLE, 120VAC, MOUNTED AT 18" AFF TO CENTER OF OUTLET BOX
,	#	QUAD CONVENIENCE RECEPTACLE, 120VAC, MOUNTED AT 16" AFF UNO
	ΤV	TV CONNECTION. VERIFY REQUIREMENTS W/ OWNER
	A	TELEPHONE OUTLET, MOUNTED AT 18" AFF TO CENTER OF OUTLET BOX
	A	DATA/PHONE OUTLET MOUNTED AT 18"AFF TO CENTER OF OUTLET BOX
	(J)	JUNCTION BOX
		ELECTRICAL PANEL, SURFACE
	, 	ELECTRICAL PANEL, FLUSH
	-\(\sigma\)	DISCONNECT SWITCH, FUSIBLE
	Ø	FAN BY MECHANICAL CONTRACTOR
		TELEPHONE PANEL, 4×8×¾ PLYWOOD WITH #6 INSUL. GROUND IN ¾" CONDUIT TO ELEC. SYSTEM GROUND

ELECTRI	CAL ABBREVIATIONS
 AFF	ABOVE FINISHED FLOOR
GFI	GROUND FAULT INTERRUPTING
GFIA	GROUND FAULT INTERRUPTER WITH AUDIBLE ALARM
3R	WEATHERPROOF ENCLOSURE
UNO	UNLESS NOTED OTHERWISE
RGS	RIGID GALVANIZED STEEL
WP	WEATHERPROOF
 AHU	AIR HANDLING UNIT
HP	HEAT PUMP
TBD	TO BE DETERMINED

NO	res:	
1.	FOR 20A - 1ø - 120 VOL	T SERVICE WIRE
7.	SIZE SHALL BE AS FOLLOW	
	DIST TO 1st CONNECTION	WIRE SIZE
	60' TO LESS	#12
	60' TO 100'	#10
	OVER 100'	 #8

IGHTING	FIXTURE SCHE	DULI	=			·							
	DESCRIPTION	LAMP											
SYMB0L		NO	WATT	TYPE	COLOR TEMP	LUMENS	VOLT	MFG.	MODEL	MOUNTING	REMARKS		
Α	4' LINEAR LED	-	45	LED	3500K	5500	120	PHILIPS DAY-BRITE	FSS455L835-UNV-DIM	CEILING SURFACE	MOUNT ON OVER WALL OVER DOOR IN MECHANICAL ROOMS.		
В	2' LINEAR LED	-	26	LED	3500K	3000	120	PHILIPS DAY-BRITE	FSS230L835-UNV-DIM		_		
C/ C-EM	SURFACE MOUNT DOWNLIGHT	_	23	LED	3500K	2200	120	SIGNIFY LIGHTOLIER	S10R835K22W	CEILING SURFACE	SEE NOTE 3 FOR 'C-EM' FIXTURES.		
D	BATHROOM VANITY	3	10	A19 LED	3500K	•••	120	TBD	TBD	OVER MIRROR	PROVIDE \$100/EA ALLOWANCE.		
E-EM	STAIRWELL LINEAR LED	_	36	LED	3500K	4534	120	LUMAX LIGHTING	COSLED43L35K46-9FAR-EM1-30	WALL AND CEILING	PROVIDE BATTERY BACKUP, OCC. SENS & AUTOMATIC DIM. SEE NOTES 4 & 5		
F	ELEVATOR PIT VAPOR TIGHT	_	38	LED	4000K	4300	120	PHILIPS DAY-BRITE	DWAE43L840-4-UNV	WALL OR CEILING	VERIFY LOCATION W/ ELEVATOR SUPPLIER.		
G-EM	EXTERIOR EMERGENCY EGRESS DOOR	_	17	LED	4000K	1530	120	ISOLITE	OWL-EM-BZ	OVER DOOR	VERIFY FINISH. PROVIDE BATTERY BACKUP.		
8	EXIT	_	-	LED	_	- -	120	ISOLITE	RL-EM-R-WH-UN-SD	WALL OR CEILING	PROVIDE BATTERY BACKUP.		
₩	EXIT/EMERGENCY COMBINATION	2	1	LED	-	_	120	ISOLITE	RLC-LED-R-U-WH-SD	WALL OVER DOOR	PROVIDE BATTERY BACKUP.		
4	EMERGENCY	2	3	LED	_	-	120	ISOLITE	BUG-3-WH-SD	WALL @ 7'-6" AFF	PROVIDE BATTERY BACKUP.		

LIGHTING FIXTURE NOTES:

CONTRACTOR SHALL PROVIDE ALL LAMPS.

TOP AND BOTTOM OF STAIRS AND AT EACH LANDING.

- 2. ALL BALLAST FOR FLUORESCENT FIXTURES SHALL BE ELECTRONIC UNLESS NOTED OTHERWISE.
- 3. FIXTURE SHALL BE WIRED TO OPERATE AS A PHOTOCELL/CLOCK CONTROLLED LIGHT UNDER NORMAL POWER AND AN EMERGENCY LIGHT IN THE EVENT OF A POWER LOSS. PROVIDE REMOTE BATTERY IF INTEGRAL BATTERY NOT AVAILABLE, BODINE OR EQUAL.
- 4. MOUNT FIXTURE AT +7'-6"AFF WHEN WALL MOUNTED. FIXTURE DIMS TO 30% WHEN SPACE IS UNOCCUPIED.
- 5. VERIFY FIXTURE SELECTION WITH OWNER. ANY SUBSTITUTIONS SHALL HAVE 90 MINUTE BATTERY BACKUP OR CONTRACTOR SHALL PROVIDE WALL MOUNTED EMERGENCY FIXTURE AT

EQUIPMENT C	ONNECTION SCHED	ULE									
CAMBOI	DESCRIPTION	l In	17111	МВ	VOLT	DUACE	DVD		FEEDER	CONNECTION	REMARKS
SYMBOL	DESCRIPTION	HP	KW	AMP	VOLT	PHASE	BKR	COND	WIRE		
ELEV.	ELEVATOR	_	_	123	208	3	175/3	2"	3-2/0, 1#6G	FUSED DISC NEMA 1	VERIFY CONNECTION W/ SUPPLIER.
DU-1, 2/ DAHU-1, 2	DUCTLESS SPLIT SYSTEM	_	_	9	208	1	15/2	1⁄2"	2#12, 1#12G	FUSED DISC NEMA 3R	SEE NOTE 2.
EH-1, 2	ELECTRIC WALL MOUNTED HEATER	·	4. 0	19	208	1	30/2	½ "	2#10, 1#10G	DIRECT	

- 1. CONTRACTOR SHALL VERIFY ALL CONNECTIONS BEFORE RUNNING SERVICE OR ORDERING EQUIPMENT.
- 2. PROVIDE ALL REQUIRED CONDUIT WITH PULL STRING BETWEEN DHP/DC AND DAHU. COORDINATE WITH MECHANICAL CONTRACTOR FOR EXACT REQUIREMENTS. VERIFY BREAKER SIZE WITH SUPPLIER. PROVIDE ALL CODE REQUIRED DISCONNECTS AT UNITS.

CONDUIT (EMT.) STEEL STUD. 1 OR 2 HOUR FIRE -RATED GYPSUM STEEL STUD. WALLBOARD ASSEMBLY. SIDE VIEW -CONDUIT (EMT). FRONT VIEW MOLDABLE METALLIC OUTLET BOX/ BARRIER MOLDABLE PUTTY 1 OR 2 HOUR FIRE RATED GYPSUM WALLBOARD

A PUTTY PACK DETAIL FOR E001 1 OR 2/HR FIRE WALL NTS

ELECTRICAL SYSTEM AND EQUIPMENT METHOD OF COMPLIANCE

PRESCRIPTIVE X

MOTOR TYPE # OF POLES

PERFORMANCE

PROVIDE A STANDARD RISER DIAGRAM WHICH INDICATES DESIGNATED POINTS FOR CHECK METERING. - SEE PLANS PROVIDE A STANDARD PANEL SCHEDULE DESCRIPTION WHICH IDENTIFIES DIFFERENT ENDUSE LOADS. - SEE PLANS

ENERGY COST BUDGET

LIGHTING SCHEDULE

LAMP TYPE REQUIRED IN FIXTURE

NUMBER OF LAMPS IN FIXTURE

BALLAST TYPE USED IN THE FIXTURE > SEE PLANS NUMBER OF BALLASTS IN FIXTURE


TOTAL WATTAGE PER FIXTURE TOTAL INTERIOR WATTAGE SPECIFIED VS ALLOWED SPECIFIED=2,495 WATTS, ALLOWED=17,043 WATTS *
TOTAL EXTERIOR WATTAGE SPECIFIED VS ALLOWED SPECIFIED WATTAGE IS LESS THAN BASE SITE ALLOWANCE

EQUIPMENT SCHEDULES WITH MOTORS (NOT USED FOR MECHANICAL SYSTEMS) MOTOR HORSEPOWER NUMBER OF PHASES MINIMUM EFFICIENCY > N/A

TO THE BEST OF MY KNOWLEDGE AND BELIEF, THE DESIGN OF THIS BUILDING COMPLIES WITH THE THERMAL ENVELOPE REQUIREMENTS OF THE LATEST NORTH CAROLINA STATE ENERGY CODE.

*COMPLIES WITH C406. 1 AND C406. 3 OF THE NC ENERGY CODE 2018.

DAVID SIMS & ASSOCIATES , P.C Consulting Engineers Arboretum Centre 108 Giles Avenue - Suite 100 Wilmington, N.C. 28403 (910) 791-8016 (OFFICE) (910) 395-5734 (FAX) NC License: C-1150

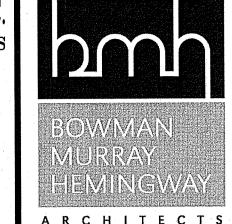

ARCHITECTS

514 Market Street Wilmington, NC 28401 Tel - (910) 762-2621 Fax - (910) 762-8506



011 0

N


SPECIFICA-TION SCHEDULES (SCHEDULES)


	JOB NUMBER	
-	DRAWN BY	- 1


CHECKED BY


07/09/2019 **REVISIONS**

SHEET NUMBER

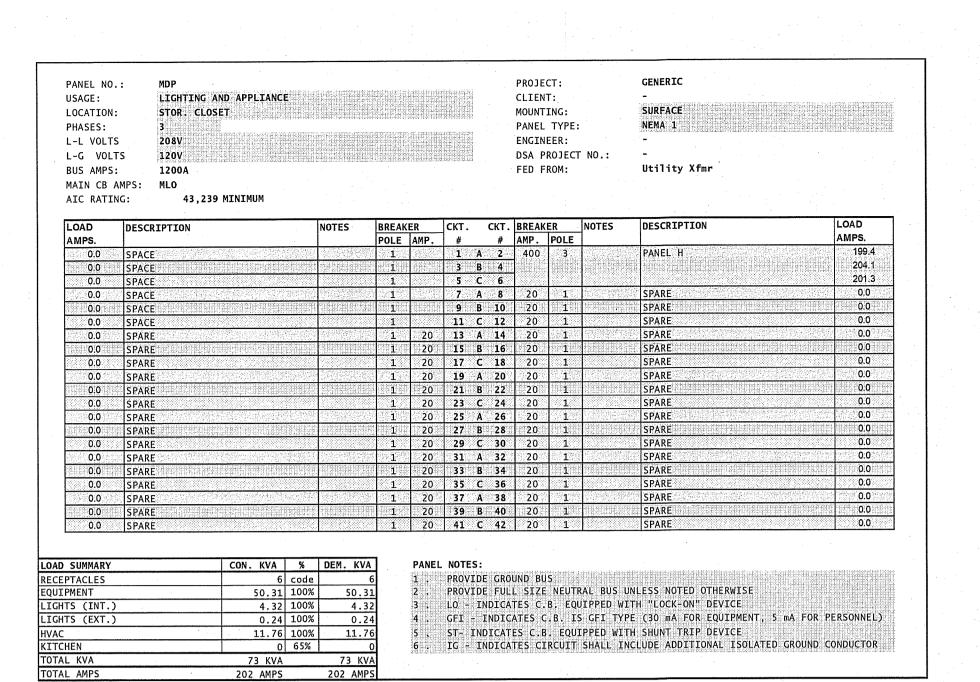

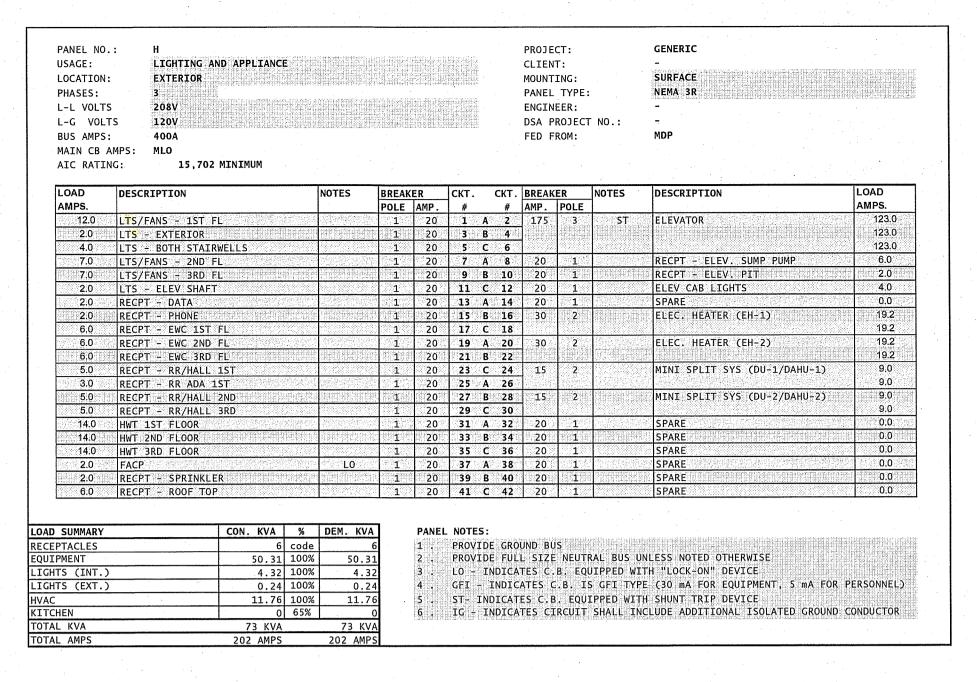

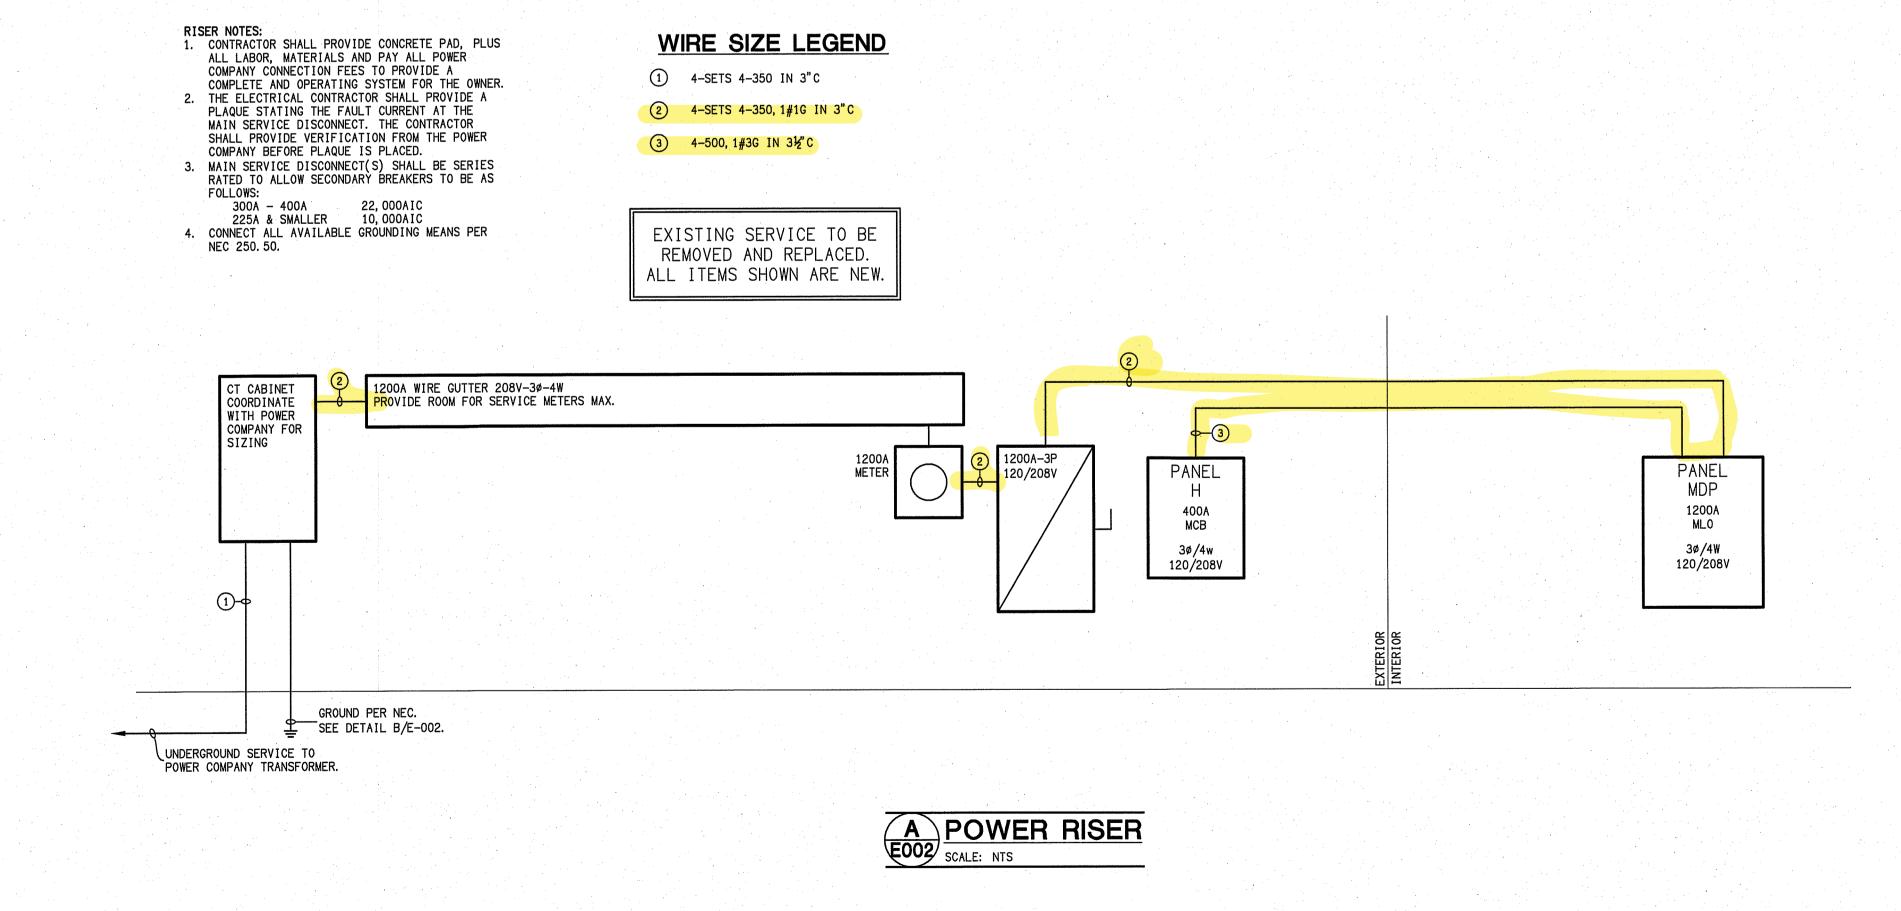

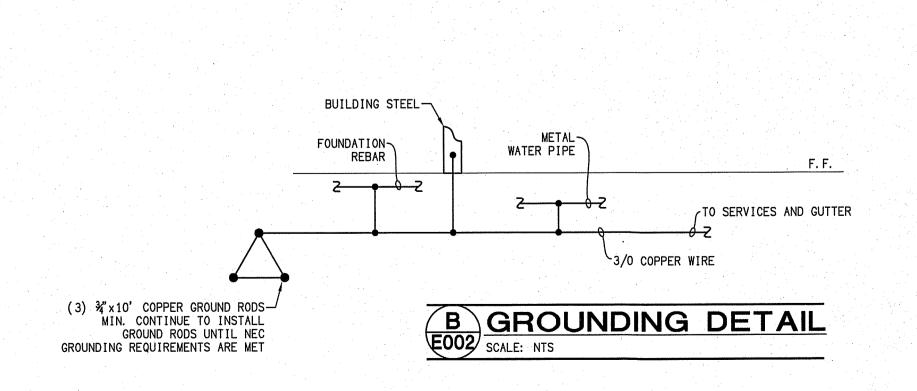

DAVID SIMS & ASSOCIATES, P.C.

Consulting Engineers

Arboretum Centre


108 Giles Avenue - Suite 100


Wilmington, N.C. 28403

(910) 791-8016 (OFFICE)

(910) 395-5734 (FAX)

NC License: C-1150

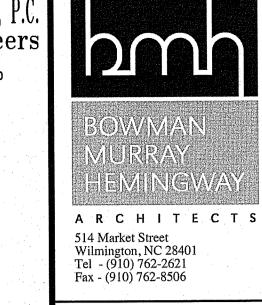

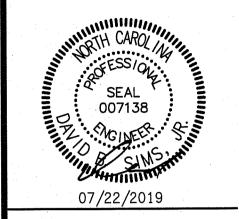


Renovations to:
226 North Front S

DATE O7/09/2019

SHEET NUMBER

REVISIONS

E-002

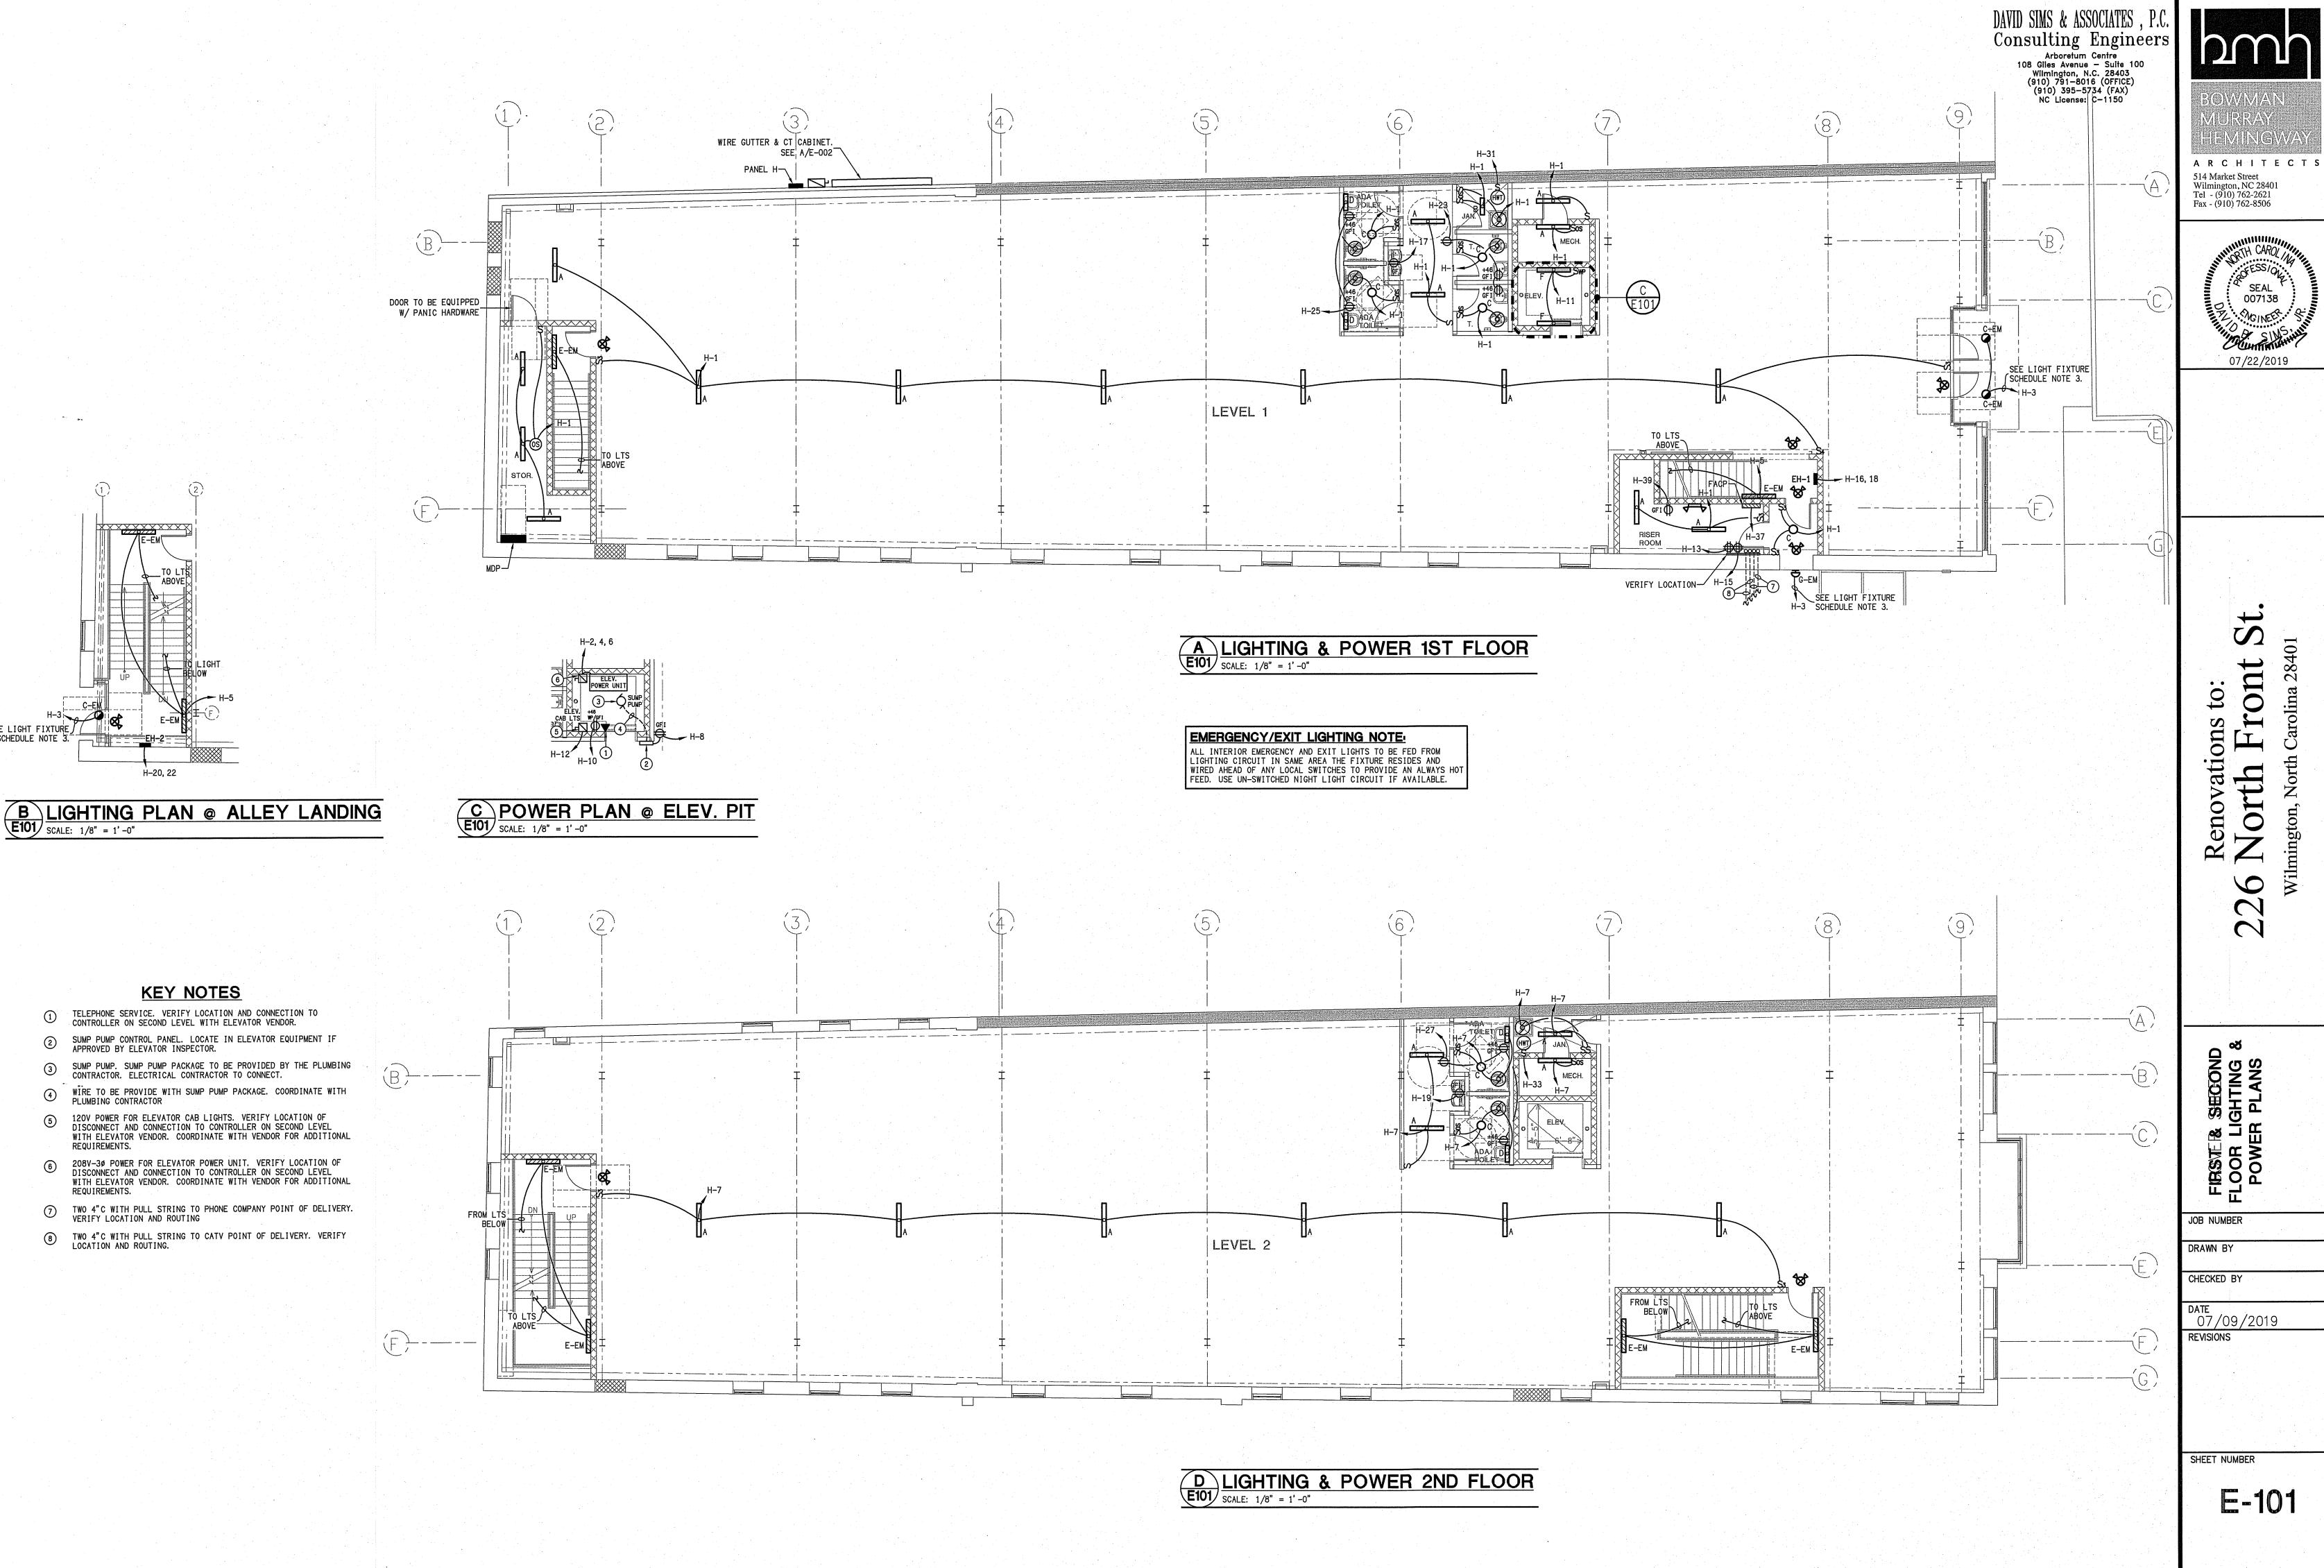

SEE LIGHT FIXTURE

H-20, 22

KEY NOTES

CONTRACTOR. ELECTRICAL CONTRACTOR TO CONNECT.

PLUMBING CONTRACTOR

REQUIREMENTS.

E-101

07/22/2019

N

DAVID SIMS & ASSOCIATES, P.C.


Consulting Engineers


Arboretum Centre

108 Giles Avenue - Suite 100

Wilmington, N.C. 28403
(910) 791-8016 (OFFICE)
(910) 395-5734 (FAX)

NC License: C-1150

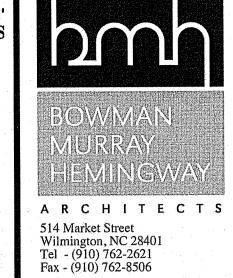

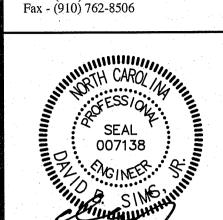



Renovations to:
North Front 226


JOB NUMBER DRAWN BY

CHECKED BY

DATE 07/09/2019 REVISIONS

SHEET NUMBER

E-102

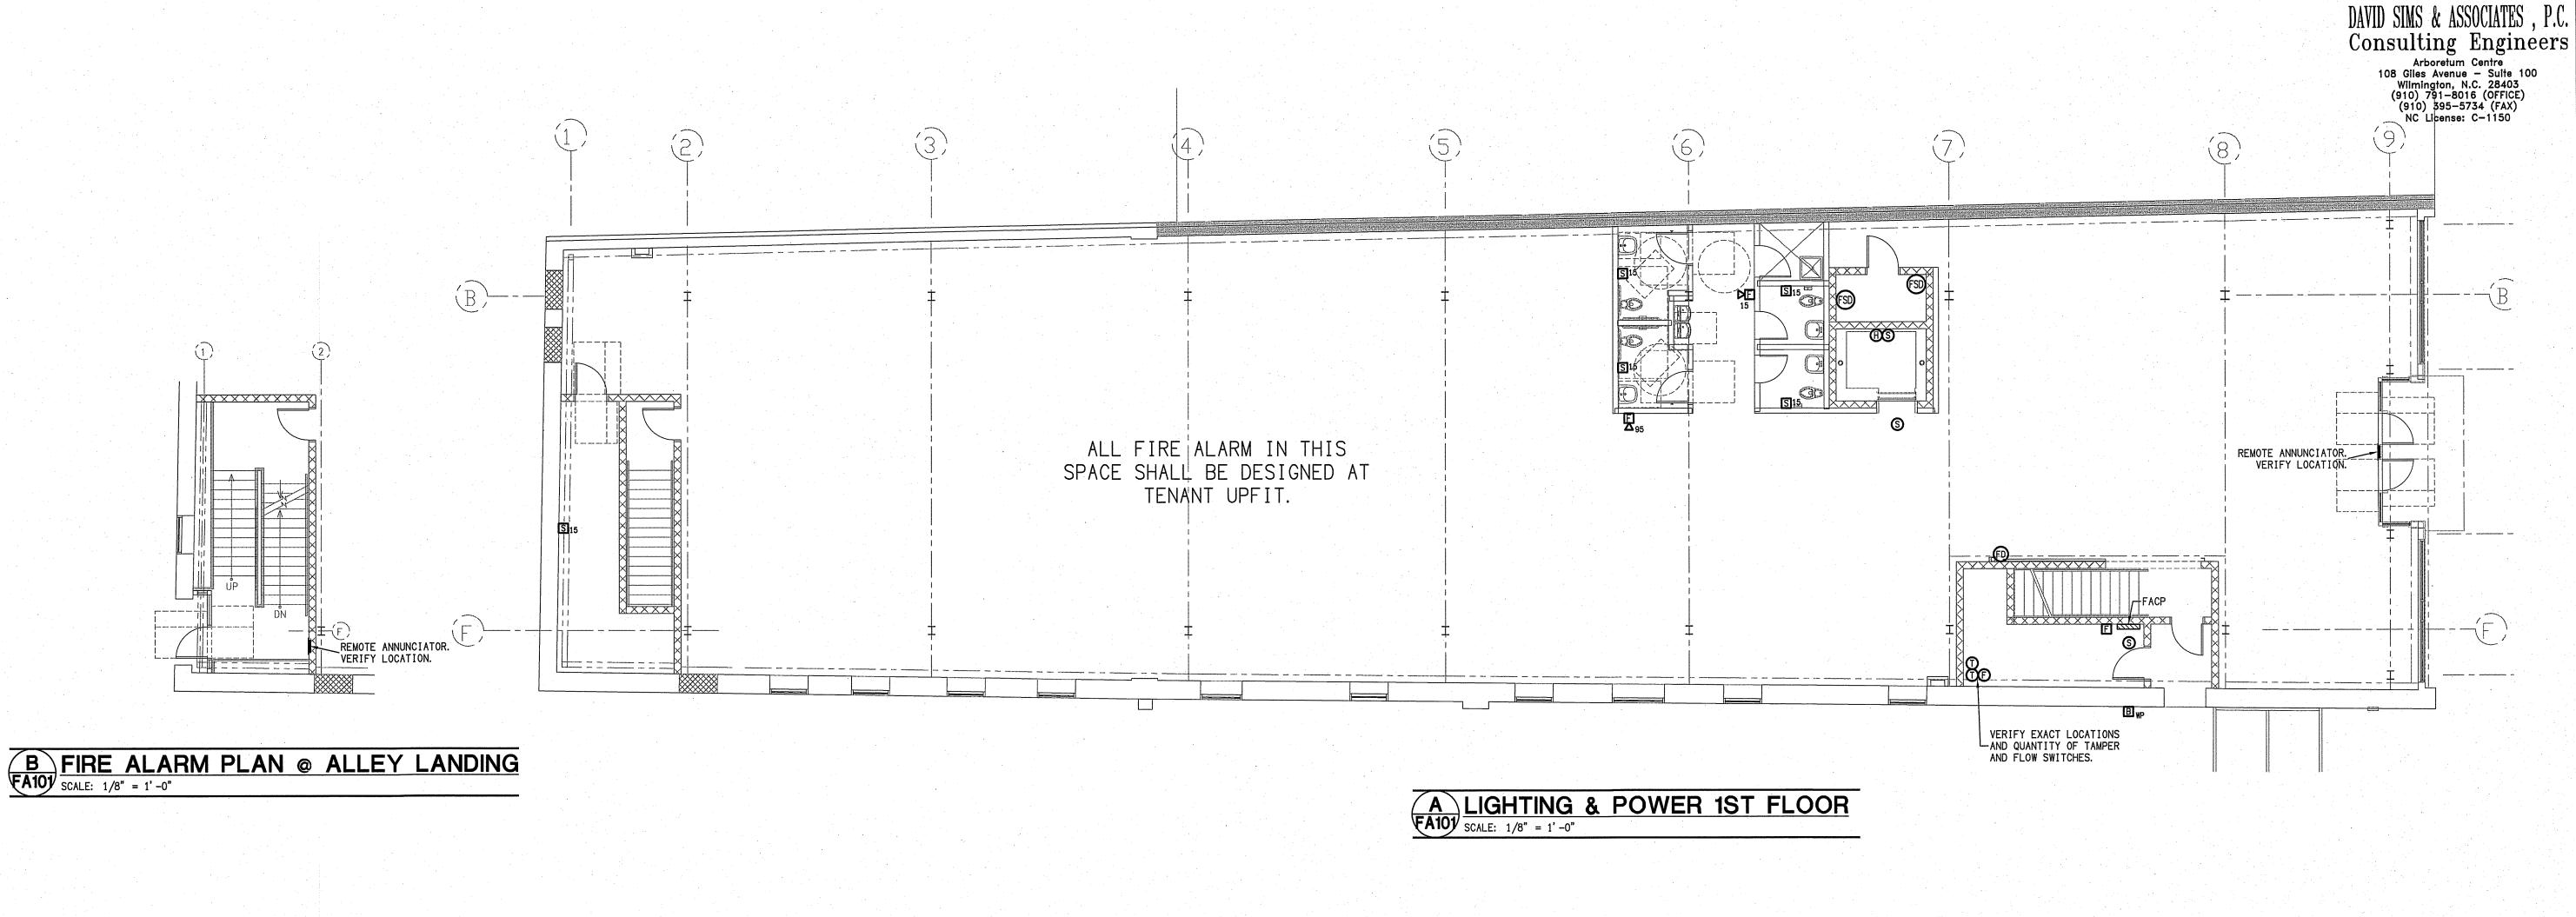

FIRE ALARM SPECIFICATIONS

1611 FIRE ALARM SYSTEM
A. GENERAL

THE FIRE ALARM SYSTEM SHALL INCLUDE EMPTY RACEWAY SYSTEMS WITH PULLWIRE, ETC., OR USE OF UL FIRE RATED CABLE TO MEET THE NATIONAL ELECTRICAL CODE, THE STATE CODES AND THE LOCAL BUILDING CODES AND NFPA 72 AND ADA REQUIREMENTS.

SYSTEM SHALL BE ADDRESSABLE.

PROVIDE A COMPLETE NEW FIRE ALARM SYSTEM AS SHOWN ON THE PLANS.

B. FIRE ALARM SYSTEM

1. THE CONTRACTOR SHALL FURNISH AND INSTALL ALL CONDUIT, WIRING, OUTLETS AND EQUIPMENT AS SHOWN ON THE DRAWINGS AND/OR HEREIN SPECIFIED. ALL SYSTEM COMPONENTS SPECIFIED HEREIN, AS WELL AS THEIR INSTALLATION, SHALL COMPLY WITH APPLICABLE STANDARD OF THE NATIONAL ELECTRICAL CODE, NATIONAL FIRE PROTECTION ASSOCIATION—72, N.C. STATE BUILDING CODE, LOCAL CODES, AND THE JURISDICTION HAVING AUTHORITY. ALL EQUIPMENT SHALL BE UNDERWRITERS' LABORATORIES LISTED FOR FIRE ALARM SYSTEM USE AND SHALL BE UL

LISTED COMPATIBLE.

2. THE SYSTEM SHALL BE INSTALLED IN ACCORDANCE WITH THE MANUFACTURER'S RECOMMENDATIONS AND SHALL BE INSTALLED AND CONNECTED UNDER THE DIRECTION AND SUPERVISION OF A MANUFACTURER'S REPRESENTATIVE UPON COMPLETION OF INSTALLATION, THE MANUFACTURER'S REPRESENTATIVE SHALL PERFORM ALL OPERATIONAL TESTS AND ADJUSTMENTS AND CERTIFY IN WRITING THAT THE SYSTEM IS PROPERLY INSTALLED AND FUNCTIONS AS SPECIFIED (SEE ALSO TESTING BELOW).

3. ALL WIRING SHALL BE IN A COMPLETELY SEPARATE CONDUIT SYSTEM OR UL LISTED FIRE RATED CABLE AND COLOR CODED TO ALLOW EASE OF IDENTIFICATION OF THE DIFFERENT CIRCUITRY REQUIRED FOR THE SYSTEM.

4. THE MANUFACTURER'S AUTHORIZED REPRESENTATIVE SHALL PROVIDE SUPERVISION OF SYSTEM, AND SUBMIT A WRITTEN REPORT TO THE CONTRACTOR ATTESTING TO THE PROPER OPERATION OF THE COMPLETED SYSTEM.

THE CONTRACTOR SHALL PROVIDE THE FOLLOWING WARRANTY FOR THE FIRE ALARM SYSTEM: ALL
EQUIPMENT SHALL BE WARRANTED BY THE MANUFACTURER FOR A PERIOD OF ONE YEAR FOLLOWING
ACCEPTANCE. THE WARRANTY SHALL INCLUDE PARTS, LABOR, AND FIELD SERVICE.
 EQUIPMENT SHALL CONSIST OF THE FOLLOWING:

A) HEAT DETECTOR SHALL BE RATE OF TEMPERATURE RISE TYPE DETECTOR. HIGH TEMPERATURE UNITS SHALL BE USED IN AREA WITH GAS/OIL HEATER OR BOILERS.

B) WIRING:

CONDUIT - ALL EXPOSED WIRING SHALL BE RUN IN 3/4" EMT CONDUIT AS A MINIMUM.
 USE STEEL COMPRESSION FITTINGS, PAINT ALL JUNCTION BOXES RED.
 WIRING -

ALL WIRE SHALL BE COPPER.
MINIMUM SIGNAL WIRE SHALL BE 18 GA.
MINIMUM ALARM WIRE SHALL BE 14 GA.

CAROLINA DEPARTMENT OF REVENUE.

WIRE SHALL BE THNN/THWN RUN IN CONDUIT.

3) ALL DATA COMMUNICATION CABLES EXTENDING FROM ONE BUILDING TO ANOTHER SHALL BE PROTECTED WITH LIGHTING SURGE PROTECTORS.

4) UL APPROVED FIRE ALARM CABLE SHALL BE ALLOWED IN CONCEALED AREAS.
7. AMERICAN DISABILITY ACT

A) INSTALLATION SHALL COMPLY WITH ALL ADA REQUIREMENTS. WHENEVER POSSIBLE ALL STROBE HORNS AND STROBES SHALL BE SET AT 84" AFF.

8. TESTS

A) UPON COMPLETION OF THE INSTALLATION, THE CONTRACTOR AND THE MANUFACTURER'S AUTHORIZED REPRESENTATIVE TOGETHER SHALL TEST EVERY ALARM INITIATING DEVICE FOR PROPER RESPONSE AND ZONE INDICATION, EVERY ALARM SIGNALING APPLIANCE FOR EFFECTIVENESS, AND ALL AUXILIARY FUNCTIONS SUCH AS CONTROL OF HVAC SYSTEMS, AND EXHAUST FANS.

B) THE OWNER AND THE ARCHITECT WILL BE GIVEN AT LEAST 7 DAYS PRIOR NOTICE AND BE GIVEN THE OPPORTUNITY TO WITNESS THESE TESTS.

C) AN ITEMIZED TEST REPORT SHALL THEN BE SUBMITTED TO THE ARCHITECT AND THE OWNER, DETAILING AND CERTIFYING ALL RESULTS, INCLUDING THE MEASURE SENSITIVITY OF EACH SMOKE DETECTOR. THE DATA FOR EACH SMOKE DETECTOR SHALL INCLUDE THE

MANUFACTURER'S SERIAL NUMBER (IF ANY) PLUS SPECIFIC DEVICE NUMBER.

9. SYSTEM DOCUMENTATION, TRAINING AND MAINTENANCE

A) THE CONTRACTOR SHALL PROVIDE THE ARCHITECT WITH THREE COPIES OF THE FOLLOWING,

TO BE FORWARDED TO THE OWNER.

AS-BUILT WIRING AND CONDUIT LAYOUT DIAGRAMS, COLOR CODE AND/OR LABEL NUMBERS, AND SHOWING CONNECTIONS IN THE SYSTEM.

 SCHEMATIC WIRING DIAGRAMS OF ALL CONTROL PANELS, MODULES, ANNUNCIATORS, COMMUNICATIONS PANELS, ETC.

3) TECHNICAL LITERATURE ON ALL MAJOR PARTS OF THE SYSTEM, INCLUDING DETECTOR HEADS, MANUAL STATIONS, SIGNALING DEVICES, ALARM PANELS, AND POWER SUPPLIES.

B) THE MANUFACTURER'S AUTHORIZED REPRESENTATIVE SHALL INSTRUCT THE OWNER'S

DESIGNATED EMPLOYEES IN PROPER OPERATION OF THE SYSTEM AND IN ALL REQUIRED PERIODIC MAINTENANCE. THIS INSTRUCTION SHALL INCLUDE TWO COPIES OF A WRITTEN,

BOUND SUMMARY FOR FUTURE REFERENCE.

C) BASIC OPERATING INSTRUCTIONS SHALL BE FRAMED AND MOUNTED AT THE FAC PANEL.

D) SYSTEMS SHALL FULLY COMPLY WITH ALL REQUIREMENTS OF "REQUIREMENTS FOR FIRE DETECTION AND ALARM SYSTEMS", LATEST EDITION, AS PUBLISHED BY THE NORTH

ALL FIRE ALARM IN THIS SPACE SHALL BE DESIGNED AT TEMMIN UPFIT.

C LIGHTING & POWER 2ND FLOOR
SCALE: 1/8" = 1'-0"

A R C H I T E C T S
514 Market Street
Wilmington, NC 28401
Tel - (910) 762-2621
Fax - (910) 762-8506

SEAL
007138

07/22/2019

226 North Front St.

FIRSTER SECOND FLOOR FIRE ALARM PLANS

JOB NUMBER


DRAWN BY
CHECKED BY

DATE 07/09/2019

REVISIONS

SHEET NUMBER

FA-101

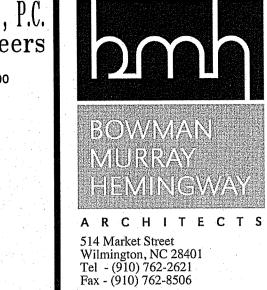



0

2

THIRIDERLOORE FIRE ALARM PLAN, DETAIL & RISER

JOB NUMBER


DRAWN BY

CHECKED BY


07/09/2019 REVISIONS


SHEET NUMBER

FA-102

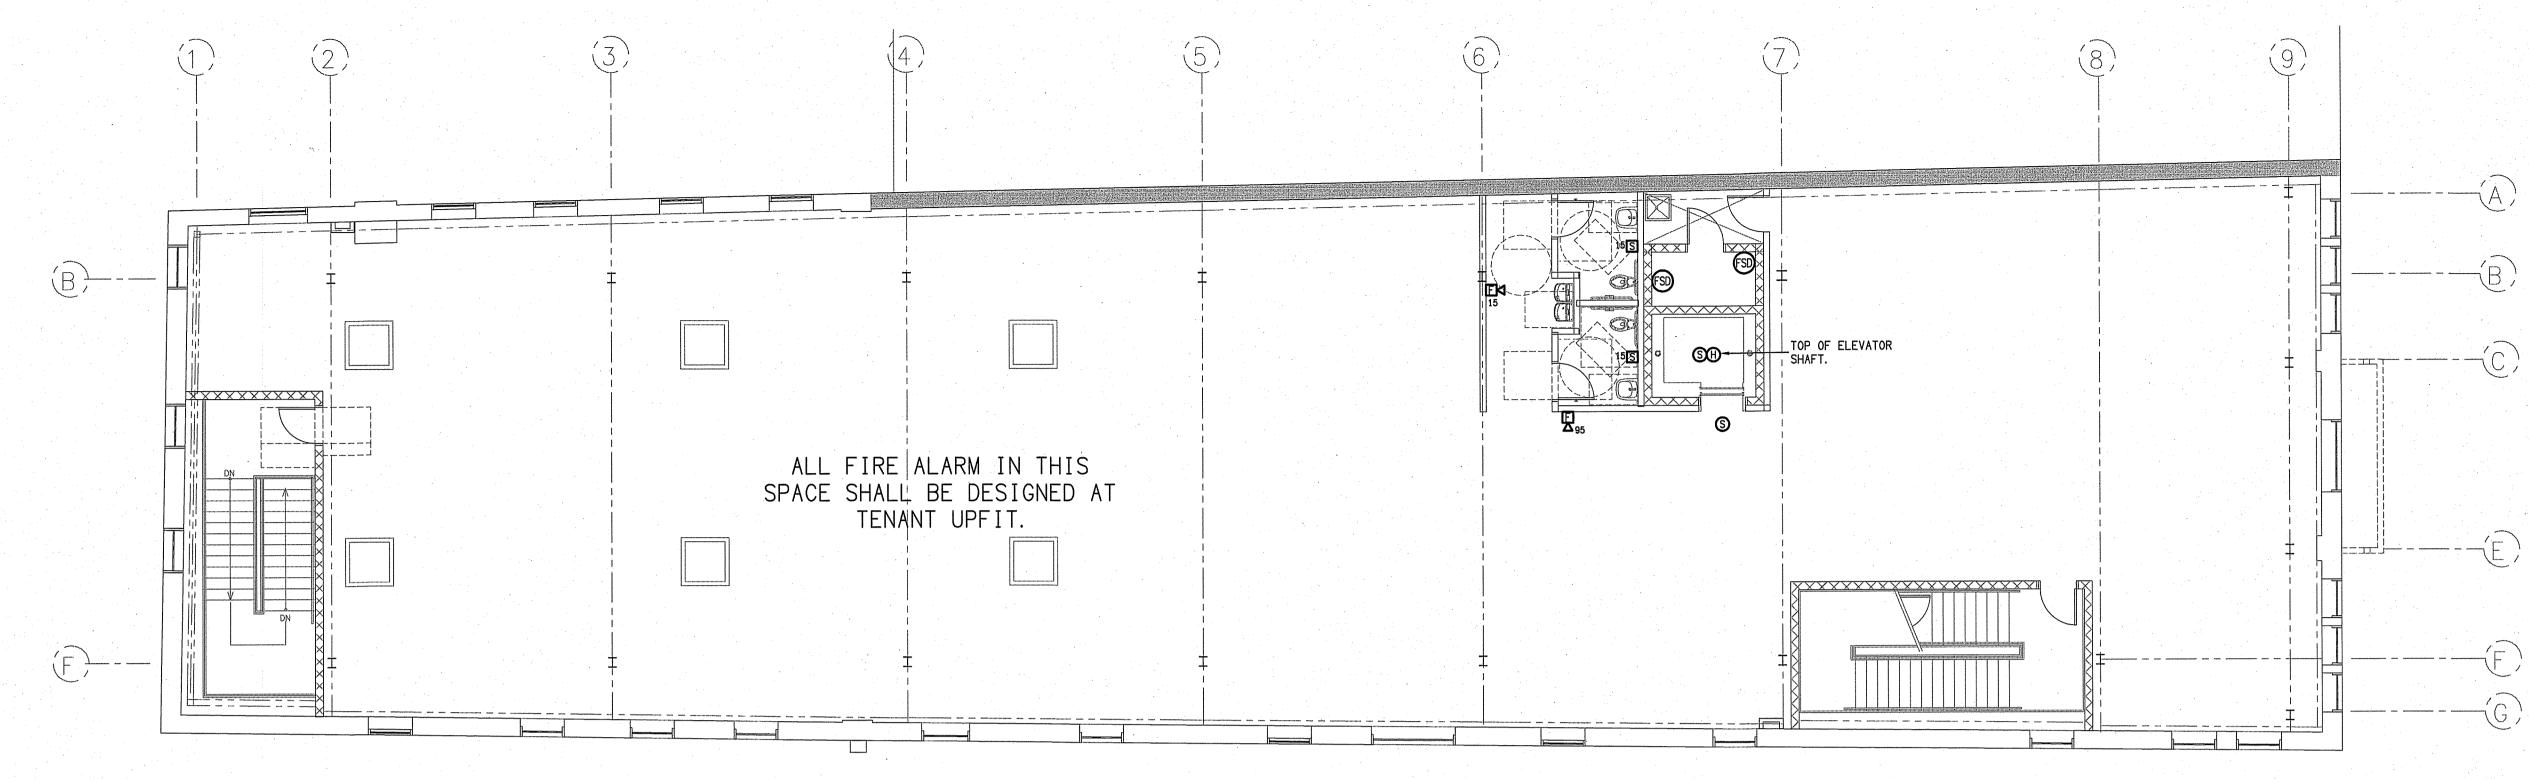


A LIGHTING & POWER 3RD FLOOR SCALE: 1/8" = 1'-0"

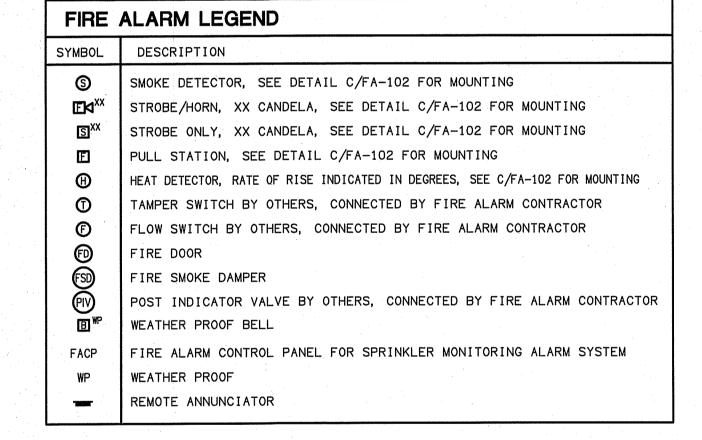

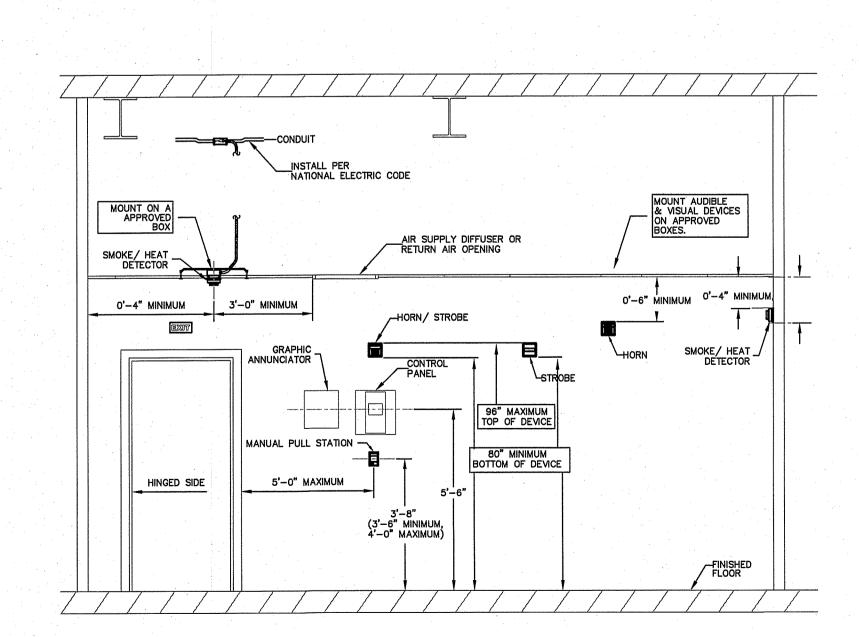



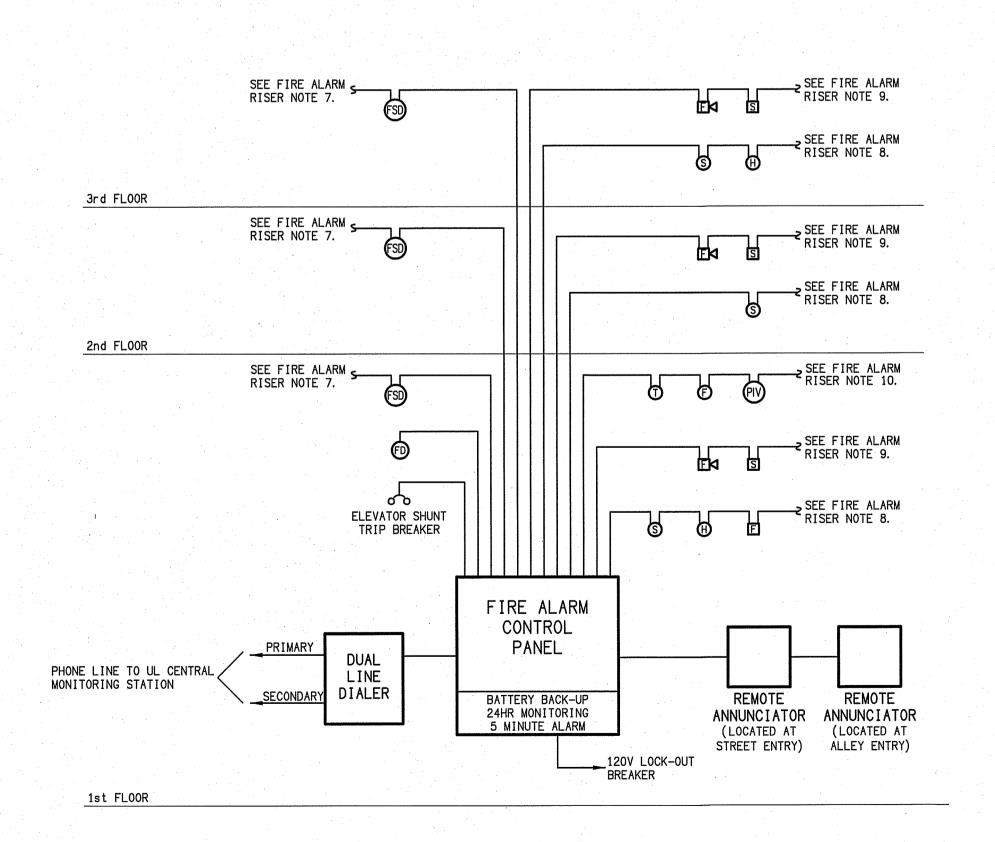

B FIRE ALARM RISER FA102 SCALE: NTS

- FIRE ALARM RISER NOTES: 1. FIRE ALARM SYSTEM SHALL BE 24V DC, POWER LIMITED, FULLY SUPERVISED, WITH 24 HOUR STANDBY BATTERY. PANEL TO BE SURFACE MOUNTED. SYSTEM SHALL HAVE MINIMUM 25% SPARE CAPACITY. SYSTEM SHALL BE ADDRESSABLE.
- 2. FIRE ALARM DEVICES ARE TO BE INSTALLED IN ACCORDANCE WITH NFPA 72 AND 'ADA'. 3. ALL FIRE ALARM WIRING SHALL BE IN CONDUIT. FIRE CABLE ALLOWED IN CONCEALED
- 4. DEVICE QUANTITIES SHALL BE AS INDICATED ON THE PLANS. VERIFY QUANTITY AND EXACT LOCATION OF SPRINKLER SYSTEM TAMPER AND FLOW SWITCHES WITH SPRINKLER
- CONTRACTOR. 5. ELECTRICAL CONTRACTOR SHALL PROVIDE A FIRE ALARM LAYOUT PLAN AT THE FACP AND THE ANNUNCIATOR PANEL.
- 6. ELECTRICAL CONTRACTOR TO PROVIDE AUTHORITY HAVING JURISDICTION WITH FIRE ALARM SYSTEM INSTALLATION PLANS FOR FINAL APPROVAL, PRIOR TO INSTALLATION. 7. CONNECT ALL FIRE SMOKE DAMPERS.
- 8. CONNECT ALL SMOKE DETECTORS, HEAT DETECTORS, CO DETECTORS AND PULL STATIONS. 9. CONNECT ALL STROBES AND STROBE HORNS. MAXIMUM OF TEN DEVICES ON A CIRCUIT. PROVIDE ADDITIONAL CIRCUITS AS REQUIRED.
- 10. CONNECT ALL SPRINKLER SYSTEM DEVICES. COORDINATE WITH SPRINKLER CONTRACTOR. 11. NOT USED. 12. NOT USED.
- 13. NOT USED. 14. VOLTAGE DROP CALCULATIONS AND BATTERY CALCULATIONS WILL BE PROVIDED BY THE CONTRACTOR. 15. ALL WIRE SHALL BE COPPER.
- 16. ALL WIRE SHALL BE CAPPED AND RUN IN CONDUIT. U.L. APPROVED FIRE ALARM CABLE MARKED FPL PER NEC 760. 28 SHALL BE ALLOWED IN CONCEALED NON-PLENUM AREAS ONLY WHEN NOT EXPOSED TO MECHANICAL DAMAGE.
- 17. ALL ALARM CIRCUITS SHALL BE 14 AWG MINIMUM. ALL SIGNAL CIRCUITS SHALL BE 18 AWG MINIMUM. ALL OTHER WIRE SHALL BE SIZED PER MANUFACTURE INSTRUCTIONS. 18. PHONE DIALER SHALL BE CONNECTED TO A CENTRAL MONITORING STATION. CONTRACTOR SHALL PROVIDE ALL EQUIPMENT NEEDED FOR THIS CONNECTION AND SHALL PAY ALL FEES REQUIRED FOR THIS CONNECTION. PHONE DIALER SHALL BE A DUAL LINE DIALER
- PROVIDED BY THE CONTRACTOR. 19. ALL COMPONENTS SHALL REFLECT U.L. LISTING AND LABELING FOR FIRE SERVICE USE AND SHALL BE COMPATIBLE.
- 20. UPON ACTIVATION OF THE FIRE ALARM SYSTEM BY A MANUAL STATION, SMOKE DETECTOR, DUCT DETECTOR, ANSUL SYSTEM, FLOW OR PRESSURE SWITCHES THE FOLLOWING TAKES
- A. ENERGIZE ALL ALARM SIGNALING DEVICES. B. SOUND ALL AUDIBLE ALARMS AND FLASH VISUAL SIGNAL THROUGHOUT THE BUILDING. C. ALERT THE LOCAL FIRE DEPARTMENT OR PROPRIETARY SYSTEM.
- D. CAUSE ALARM TO BE DISPLAYED ON THE ANNUNCIATOR AND ON THE CONTROL PANEL. E. CLOSE ALL DOORS WHICH ARE HELD OPEN BY AUTOMATIC RELEASE DEVICES THROUGHOUT THE FACILITY OR BY ZONE.
- F. ALL AHU'S AND RTU'S SHALL SHUT DOWN UPON FIRE ALARM ACTIVATION. SEE MECHANICAL PLANS FOR EXACT LOCATION OF UNITS.
- 21. PROVIDE A COMPLETE ZONE NAME LIST SUCH THAT IT CAN BE DETERMINED IF THE SMOKE COMPARTMENT NAME IS USED IN EACH ZONE NAME AND THE ZONE NAMES HAVE BEEN COORDINATED WITH THE SMOKE COMPARTMENTS.
- 22. PROVIDE TELEPHONE DIALER TROUBLE ALARM A. LOSS OF TELEPHONE LINE
- B. LOSS OF DIALER. C. LOSS OF UNIT POWER SUPPLY.
- 23. ALL STROBES AND STROBE/CHIMES SHALL BE ADJUSTABLE FOR LIGHT LEVEL AND AUDIO.