



PROJECT GENERAL NOTES

HVAC GENERAL
1. DRAWINGS ARE DIAGRAMMATIC IN NATURE AND, UNLESS EXPLICITLY DIMENSIONED, INDICATE APPROXIMATE LOCATIONS OF APPARATUS, EQUIPMENT, DUCTWORK AND PIPING. CHANGES IN THE LOCATION AND OFFSETS, OF SAME WHICH ARE NOT SHOWN ON THE DRAWINGS BUT ARE NECESSARY IN ORDER TO ACCOMMODATE BUILDING CONDITIONS AND COORDINATION WITH THE WORK OF OTHER TRADES, SHALL BE MADE DURING THE PREPARATION OF COORDINATION DRAWINGS AND PRIOR TO INITIAL INSTALLATION, WITHOUT ADDITIONAL COST TO THE OWNER.

MOTORS
1. PROVIDE MOTORS FOR EQUIPMENT COVERED IN DIVISION 23 UNLESS OTHERWISE SPECIFIED HEREIN. SELECT MOTORS FOR OPERATION NOT EXCEEDING A 1.0 SERVICE FACTOR AND WITHIN THE NAMEPLATE AMPERAGE AND NOMINAL POWER RATINGS.

VIBRATION ISOLATION

1. SELECT AND LOCATE VIBRATION ISOLATION EQUIPMENT FOR UNIFORM LOADING AND DEFLECTION, ACCORDING TO WEIGHT DISTRIBUTION OF EQUIPMENT.
2. VIBRATION ISOLATORS SHALL BE INSTALLED AND CONNECTED AS SPECIFIED OR INDICATED ON THE DRAWINGS IN ACCORDANCE WITH THE MANUFACTURER'S WRITTEN INSTRUCTIONS AND CERTIFIED SUBMITTAL DATA.

VIBRATION ISOLATION CONTINUED:

7. CONFLICTS WITH OTHER TRADES THAT WILL RESULT IN DIRECT CONTACT WITH ISOLATED EQUIPMENT, PIPING, OR DUCTWORK, SHALL BE BROUGHT TO THE ATTENTION OF THE ENGINEER PRIOR TO INSTALLATION.
8. DISCREPANCIES BETWEEN THE SPECIFICATIONS AND THE FIELD CONDITIONS, OR CHANGES REQUIRED DUE TO SPECIFIC EQUIPMENT SELECTION SHALL BE BROUGHT TO THE ATTENTION OF THE ENGINEER PRIOR TO INSTALLATION.

28. WHEN MECHANICAL EQUIPMENT IS OPERATING AT 2" OF WATER OR MORE STATIC PRESSURE OR WHEN EQUIPMENT THRUST, FORCES EXCEED 10% OF THE EQUIPMENT WEIGHT HORIZONTAL THRUST RESTRAINTS ARE REQUIRED, SIZE AND ADJUST TO LIMIT LATERAL MOVEMENT TO 0.25" OR LESS UNDER NORMAL OPERATIONAL STATIC PRESSURES.
29. ALL DUCTED CONNECTIONS TO FIRE DAMPERS SHALL BE PROVIDED WITH A FLEXIBLE DUCT CONNECTOR.

HVAC PERFORMANCE VERIFICATION

1. SUBMITTALS
A. SUBMIT ADDITIONAL DOCUMENTATION AS REQUIRED TO SUPPORT THE PERFORMANCE VERIFICATION PROCESS. THIS ADDITIONAL SUBMITTAL DOCUMENTATION SHALL INCLUDE, AT A MINIMUM, THE PROPOSED START-UP AND INITIAL CHECK-OUT PROCEDURES, AND PREFUNCTIONAL CHECKLISTS.
2. START-UP PLAN AND PREFUNCTIONAL TESTING
A. PREFUNCTIONAL TESTING SHALL BE REQUIRED FOR EACH PIECE OF EQUIPMENT TO ENSURE THAT THE EQUIPMENT AND SYSTEMS ARE PROPERLY INSTALLED AND READY FOR OPERATION, SO THAT FUNCTIONAL TESTING MAY PROCEED WITHOUT DELAYS. FOLLOW THE APPROVED START-UP, INITIAL CHECK-OUT, AND PREFUNCTIONAL TESTING PROCEDURES. SAMPLING STRATEGIES SHALL NOT BE USED FOR PREFUNCTIONAL TESTING. THE PREFUNCTIONAL TESTING FOR EQUIPMENT AND SUBSYSTEMS OF A GIVEN SYSTEM SHALL BE SUCCESSFULLY COMPLETED AND DOCUMENTED PRIOR TO FUNCTIONAL TESTING OF THE SYSTEM.

B. WHERE DEFICIENT OPERATION OR DEFECTIVE EQUIPMENT IS DISCOVERED, PROVIDE CORRECTIVE MEASURES.
6. TESTING DOCUMENTATION, NONCONFORMANCE, AND APPROVALS
A. LIST OUTSTANDING ITEMS OF THE INITIAL START-UP AND PREFUNCTIONAL PROCEDURES THAT WERE NOT COMPLETED SUCCESSFULLY, AT THE BOTTOM OF THE FUNCTIONAL TEST PROCEDURE FORMS OR ON AN ATTACHED SHEET. THE FUNCTIONAL TEST PROCEDURE FORMS AND ANY OUTSTANDING DEFICIENCIES SHALL BE PROVIDED TO THE ARCHITECT WITHIN 2 DAYS OF TEST COMPLETION. THE ARCHITECT SHALL REVIEW THE CONTRACTOR'S START-UP AND PREFUNCTIONAL TESTING DOCUMENTATION AND SHALL SUBMIT EITHER A NONCOMPLIANCE REPORT OR AN APPROVAL FORM TO THE CONTRACTOR. WORK WITH THE ARCHITECT TO CORRECT AND RETEST DEFICIENCIES OR UNCOMPLETED ITEMS. CORRECT ITEMS THAT ARE DEFICIENT OR INCOMPLETE IN A TIMELY MANNER, AND NOTIFY THE ARCHITECT AS SOON AS OUTSTANDING ITEMS HAVE BEEN CORRECTED AND RESUBMIT AN UPDATED START-UP REPORT AND A STATEMENT OF CORRECTION ON THE ORIGINAL NONCOMPLIANCE REPORT. WHEN REQUIREMENTS ARE COMPLETED, SCHEDULE THE FUNCTIONAL TESTING OF THE EQUIPMENT OR SYSTEM.

TESTING, ADJUSTING AND BALANCING

1. TESTING, ADJUSTING AND BALANCING
A. PROVIDE MATERIALS, EQUIPMENT, LABOR, AND POWER TO TEST, ADJUST, AND PROPORTIONALLY BALANCE NEW HEATING, VENTILATING, REFRIGERATION, AND AIR CONDITIONING SYSTEMS AND COMPONENTS AS INDICATED ON THE DRAWINGS AND AS SPECIFIED. VERIFY FUNCTIONING OF OPERATING DEVICES AND EQUIPMENT. IN ADDITION, THE FOLLOWING SPECIFIC TESTING, ADJUSTING AND BALANCING SHALL BE PERFORMED.

1) DUCTWORK LEAKAGE TESTING:
A) FOR DUCTWORK WITH STATIC PRESSURE CLASSIFICATION OF 4" WG, 6" WG, OR 10" WG, A LEAKAGE TEST SHALL BE MADE AFTER INSTALLATION OF EACH OF THE FIRST REPRESENTATIVE SAMPLE OF DUCTWORK OF EACH CLASSIFICATION. THE TEST SAMPLE SHALL INCORPORATE AT LEAST: 5 TRANSVERSE JOINTS, TYPICAL SEAMS, ONE ELBOW, 2 TYPICAL BRANCH CONNECTIONS, AND FOR RISER DUCTS OR OTHER SYSTEMS THAT INCLUDE MULTIPLE FIRE DAMPERS, ONE FIRE DAMPER AND ONE ACCESS DOOR. AFTER SATISFACTORY RESULTS FOR THE TEST SAMPLE, ADDITIONAL DUCTWORK SHALL BE TESTED TOTALING NO LESS THAN 25% OF THE TOTAL DUCT AREA FOR EACH PRESSURE CLASS. REMAINING DUCT SECTIONS SHALL BE TESTED UNTIL THE TOTAL DUCT AREA FOR EACH PRESSURE CLASS HAS BEEN TESTED.

Table with 3 columns: STATIC PRESSURE CLASSIFICATION, WG, LEAKAGE CLASS. Rows include 0.5" 1", 2", 3", 4", 6", 10" and 2) ROUND AND FLAT OVAL DUCTWORK: 0.5" 1", 2", 3", 4", 6", 10"


H) SUBMIT A REPORT CERTIFYING DUCTWORK TESTING AND RESULTS.
I) IN ADDITION TO THE TESTS SPECIFIED HEREIN, TEST DUCTWORK LOCATED OUTDOORS IN ACCORDANCE WITH THE CRITERIA SPECIFIED HEREIN FOR THE PRESSURE CLASSIFICATION OF THE DUCTWORK.
J) IN ADDITION TO THE TESTS SPECIFIED HEREIN, TEST SUPPLY, OUTSIDE AIR, AND EXHAUST / RELIEF DUCTWORK ASSOCIATED WITH AIR HANDLING UNITS AND EXHAUST / RELIEF DUCTWORK ASSOCIATED WITH FANS, WHICH ARE PART OF THE SMOKE CONTROL SYSTEM. TEST DUCT LEAKAGE AT 1.5 TIMES THE MAXIMUM FAN DISCHARGE PRESSURE FOR POSITIVE PRESSURE DUCTWORK AND MAXIMUM FAN SUCTION PRESSURE FOR NEGATIVE PRESSURE DUCTWORK. PERFORM TESTS BEFORE DUCTWORK IS INSULATED. SUBMIT REPORT WITH LEAKAGE RESULTS REPORTED IN AIRFLOW LEAKAGE PER SYSTEM WITHIN 5 DAYS OF TEST. LEAKAGE SHALL NOT EXCEED 5% OF DESIGN FLOW.



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Project Grace Grace Street Wilmington, NC 28401 LS3P PROJECT: 1701-177800

Table with 2 columns: DATE, DESCRIPTION. Multiple empty rows for entries.

SHEET NAME: HVAC GENERAL NOTES

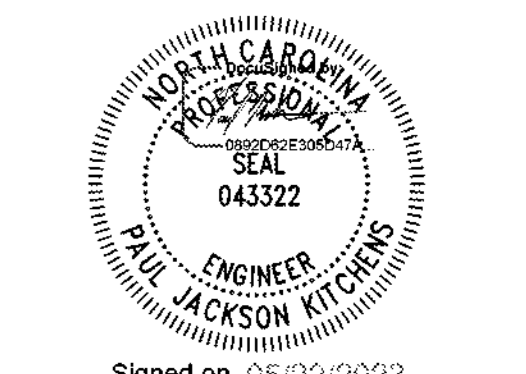ORIG SUBMISSION: 2023.05.22

SHEET: M-002



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**EQUIPMENT CONTINUED**

**7. AUTOMATIC BLOWDOWN SYSTEMS**

- A. THE TIMER SHALL ACTIVATE THE BLOWDOWN VALVE AND IF CONDUCTIVITY OF THE BLOWDOWN IS LESS THAN SETPOINT, THE BLOWDOWN VALVE WILL CLOSE AFTER AN ADJUSTABLE DELAY. IF CONDUCTIVITY IS ABOVE THE SETPOINT, THE VALVE SHALL REMAIN OPEN.

**AIR DISTRIBUTION**

**1. SHEET METAL WORK — GENERAL**

- A. CHANGES IN SHAPE, DIMENSION, OR DIRECTION SHALL BE MADE WITH A MAXIMUM TRANSITION, OFFSET, OR COMBINATION THEREOF OF 1 TO 7.
- B. EXCEPT WHERE INDICATED OTHERWISE ON THE DRAWINGS, USE METAL HAT SECTIONS OR STANDOFF BRACKETS IN LINED DUCTWORK TO INSTALL DAMPERS, TURNING VANES OR COILS. HAT SECTIONS OR STANDOFF BRACKETS SHALL BE THE SAME HEIGHT AS THE LINING THICKNESS.
- C. OPENINGS IN PLENUM CASINGS FOR ACCESS DOORS SHALL BE 9" ABOVE THE FLOOR. HINGE DOORS TO CLOSE WITH PLENUM PRESSURE.
- D. SEPARATE GALVANIZED SHEET METAL FROM ALUMINUM OR COPPER WITH LEAD OR FELT GASKETS.
- E. PROVIDE SUPPLEMENTAL STIFFENING AND SUPPORTS TO DUCTS AND APPARATUS CASINGS TO PREVENT DRUMMING, SAGGING AND TO PROVIDE A STRUCTURALLY SOUND ASSEMBLY.
- F. ENTIRE AIR SYSTEM INSTALLATION SHALL BE RIGID, AND FREE FROM RATTLES AND AIR NOISES. INTERIOR OF DUCTS SHALL BE SMOOTH.
- G. PROVIDE ANGLE BRACKETS INSIDE DUCTWORK ON BOTH SIDES TO SUPPORT SLIP-IN ELECTRIC HEATING COILS IN VERTICAL DUCTS OVER 24" WIDE.
- H. ON MULTIZONE AIR HANDLING UNITS, MATCH SIZE AND ARRANGEMENT OF ZONE DUCTS TO ZONE DAMPER SECTIONS TO ACHIEVE UNIFORM OUTLET VELOCITY FOR EACH ZONE.
- I. PROVIDE TRANSITIONS BETWEEN DIFFERENT SIZE SECTIONS OF AIR HANDLING UNITS.
- J. INSTALL UNINSULATED DUCTWORK EXPOSED IN FINISHED AREAS AGAINST THE CEILING.
- K. PROVIDE OFFSETS, ELBOWS, AND TRANSITIONS TO COORDINATE WITH OTHER WORK.
- L. PROVIDE TRANSITIONS TO CONNECT DUCTWORK TO EQUIPMENT AND COILS.

**M. ELBOWS:**

- 1) ELBOWS IN ROUND AND FLAT OVAL DUCTWORK ARE SPECIFIED HEREINBEFORE.
- 2) RADIUS ELBOWS IN RECTANGULAR AND SQUARE DUCTWORK SHALL HAVE AN INSIDE RADIUS EQUAL TO THE WIDTH OF THE DUCT, EXCEPT WHERE SPACE CONDITIONS PROHIBIT, IN WHICH CASE A REDUCED INSIDE RADIUS WITH FULL HEEL RADIUS IS PERMITTED. WHERE THE SPACE CONDITIONS REQUIRE THE INSIDE RADIUS TO BE LESS THAN 75% OF THE DUCT WIDTH, PROVIDE MULTIPLE SPLITTER VANES INSIDE THE ELBOW.
- 3) SQUARE (MITERED) ELBOWS IN RECTANGULAR AND SQUARE DUCTWORK SHALL CONTAIN SINGLE THICKNESS TURNING VANES AND SHALL BE LIMITED TO 90° TURN APPLICATIONS.
  - A) SHALL BE PARALLEL TO AIRFLOW.
  - B) VANES EXCEEDING THE MAXIMUM UNSUPPORTED LENGTH DEFINED BY SMACNA SHALL BE DIVIDED INTO MULTIPLE SECTIONS WITH INTERMEDIATE VANE RAILS OR SHALL BE BRACED WITH TIE RODS SPANNING PERPENDICULARLY ACROSS THE LEADING EDGES OF THE VANES. THE TIE RODS SHALL BE WELDED TO THE LEADING EDGE OF EACH VANE.
- 4) TURNS LESS THAN 90° IN RECTANGULAR AND SQUARE DUCTWORK SHALL BE MADE WITH RADIUS TYPE ELBOWS. MITERED ELBOWS ARE NOT PERMITTED.

- N. SEAL WALL AND FLOOR PENETRATIONS.
- O. INTERNAL SURFACES OF CLOTHES DRYER EXHAUST SHALL BE FREE OF OBSTRUCTIONS. SHEET METAL SCREWS SHALL NOT BE USED FOR FASTENING. ELBOWS IN SQUARE AND RECTANGULAR DUCTWORK SHALL BE RADIUS TYPE WITHOUT SPLITTER VANES.
- P. INSTRUMENT TEST PORTS: PROVIDE WHERE REQUIRED FOR MEASUREMENTS.

**2. AIR DISTRIBUTION SYSTEMS**

- A. NEW DUCTWORK AND AIR DISTRIBUTION EQUIPMENT IN SYSTEMS SHALL BE THOROUGHLY CLEANED INTERNALLY OF DUST, DIRT AND DEBRIS BEFORE INSTALLATION OF FILTERS AND OPERATION OF SYSTEMS. SUBMIT SIGNED STATEMENT CERTIFYING COMPLETION OF CLEANING BEFORE INSTALLATION OF FILTERS.

**3. PLENUM LINING**

- A. LINE RETURN TRANSFER DUCTWORK WITH FIBROUS PLENUM LINING.
- B. INSTALL LINING WITH COATED SIDE FACING AIR STREAM. ADHERE LINING TO INSIDE OF PLENUMS WITH 100% COVERAGE OF ADHESIVE. COAT EXPOSED EDGES AND JOINTS WITH EDGE SEALER. ATTACH LINING TO SHEET METAL PLENUMS WITH WELD OR MECHANICAL GRIP PINS 16" ON CENTER. MECHANICAL FASTENERS SHALL NOT COMPRESS THE LINING MORE THAN 0.125". COAT FIELD CUTS AND MINOR SURFACE DAMAGE WITH EDGE SEALER AFTER LINING IS INSTALLED.

**4. ROUND AND FLAT OVAL DUCTWORK**

- A. EXPOSED DUCTWORK SHALL BE PARALLEL TO BUILDING SURFACES AND STRUCTURAL MEMBERS, AND SHALL HAVE SEAMS ALIGNED AT JOINTS.
- B. CONSTRUCT A MOCK-UP OF EXPOSED DUCTWORK SHOWING TYPICAL JOINTS, METHODS OF SUPPORT, LINEAR DIFFUSERS, AND FITTINGS FOR APPROVAL BY THE ARCHITECT AND ENGINEER BEFORE FABRICATION OF EXPOSED DUCTWORK.


JOINTS SHALL BE SEALED WITH DUCT SEALER. DUCT SEALER SHALL NOT BE VISIBLE ON THE EXTERIOR OF THE DUCTWORK.



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SHEET NAME:  
HVAC GENERAL  
NOTES

ORIG SUBMISSION: 2023.05.22

SHEET: **M-004**
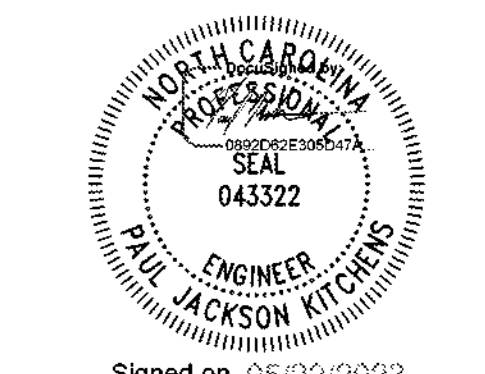
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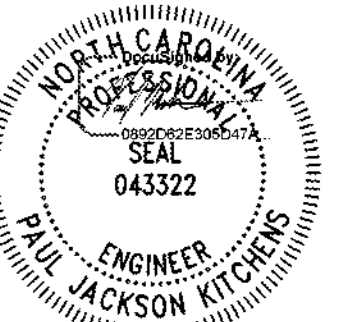
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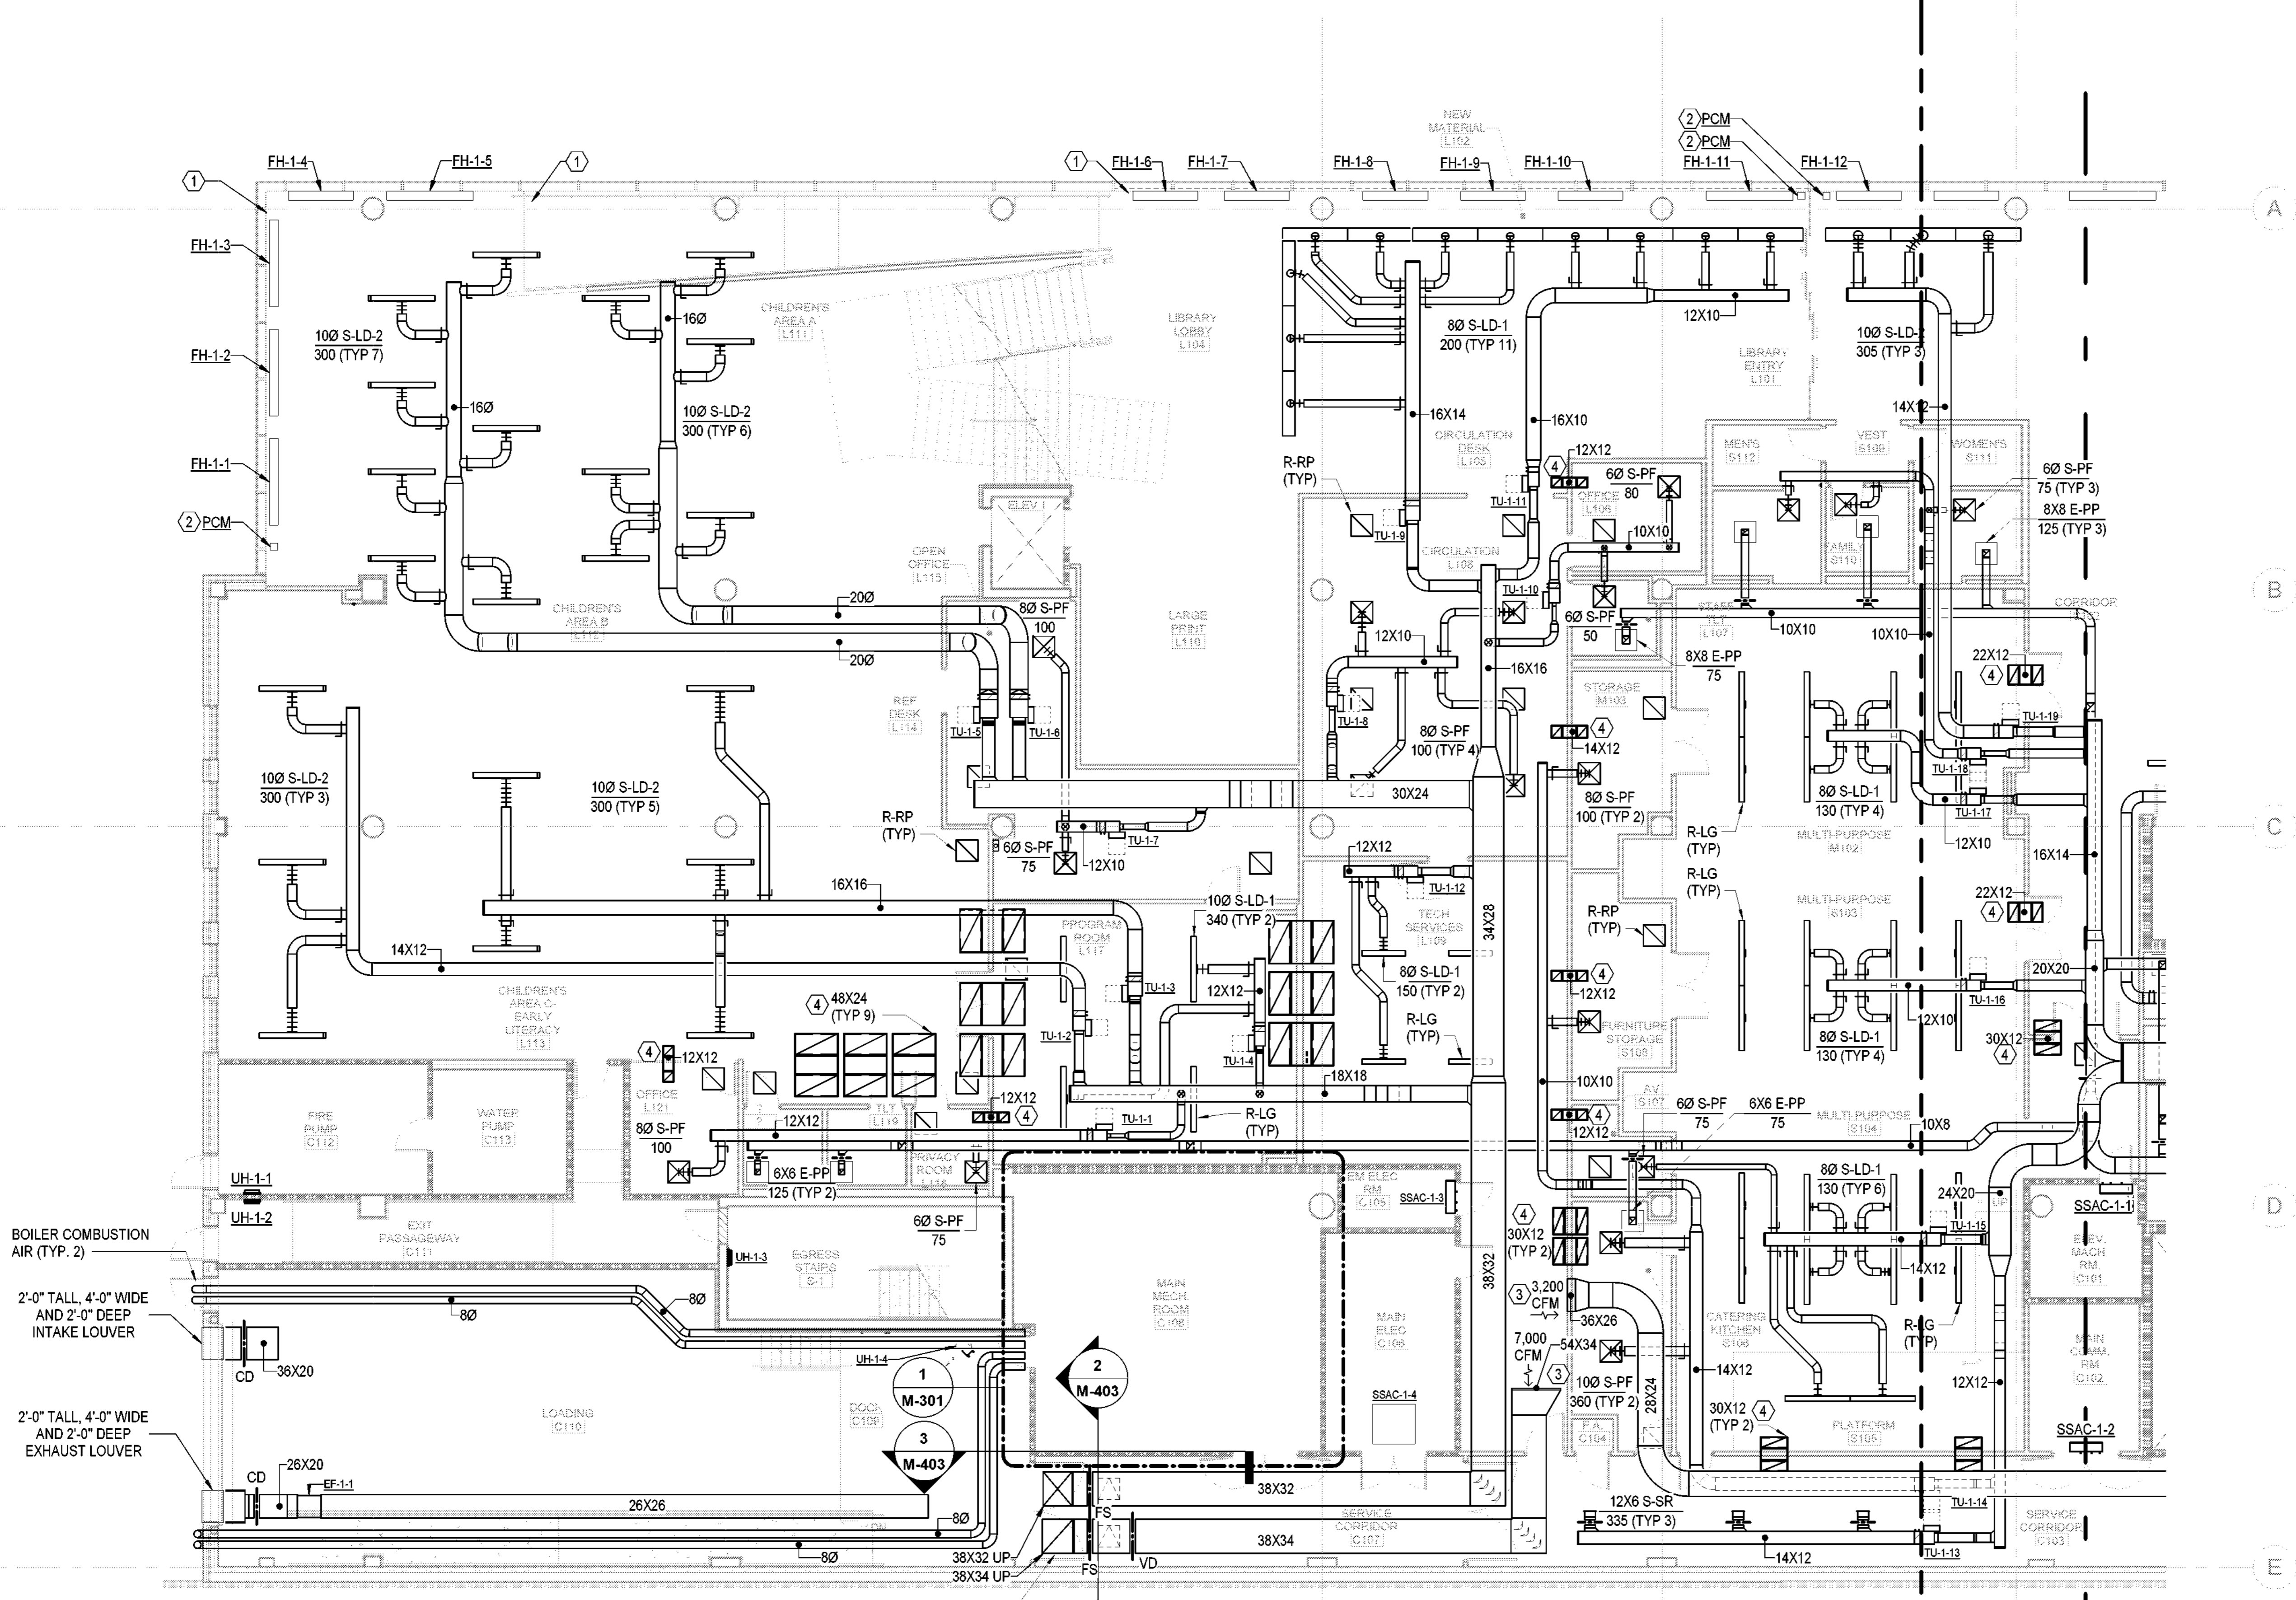
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**KEY NOTES:**

- 1. CONTINUOUS LINEAR FLOOR GRILLE ABOVE RECESSED ELECTRIC BASEBOARD HEATER. PROVIDE CONTINUOUS SECTION. PROVIDE MITERED CORNER, AND VERIFY ALL DIMENSIONS IN FIELD.
- 2. POWER AND CONTROL MODULE SERVING FLOOR HEATERS. LOCATE WITHIN FLOOR TRENCH ADJACENT TO FLOOR HEATERS. DAISY CHAIN CONTROL WIRING BETWEEN FLOOR HEATERS. REFER TO MANUFACTURERS INSTRUCTIONS FOR INSTALLATION AND WIRING.
- 3. OPEN ENDED DUCT WITH WIRE MESH SCREEN. BALANCE TO CFM INDICATED.
- 4. TRANSFER DUCT. REFER TO DETAIL 9/M-601.

**ADDITIONAL ALTERNATE**

- 1. SCOPE ASSOCIATED WITH PARKING DECK ACCESS DOOR. A. DUCTWORK SHALL SHIFT TO BE HOUSED WITHIN ALTERNATE SHAFT LOCATION. ADJACENT SYSTEMS SHALL SHIFT TO ACCOMMODATE THE ALTERNATE SHAFT LOCATION. REFER TO ARCHITECTURAL DRAWINGS FOR MORE INFORMATION.



**1 HVAC DUCTWORK LEVEL 1 - AREA A**  
1/8" = 1'-0"

**Project Grace**

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Wilmington, NC 28401  
LSP PROJECT: 7701-177800

| DATE       | DESCRIPTION |
|------------|-------------|
| 2023.05.22 | PERMIT SET  |

SHEET NAME:  
HVAC DUCTWORK  
LEVEL 1 - AREA A

ORIG. SUBMISSION: 2023.05.22

SHEET:  
**M-101A**

PERMIT SET



### GENERAL NOTES:


1. EXPOSED DUCTWORK LOCATED ABOVE GALLERY SPACES SHALL BE INSULATED DOUBLE WALL ROUND AND FLAT OVAL TYPE. DIMENSIONS ON PLANS REFER TO INTERNAL CLEAR DIMENSIONS. OUTER DUCTWORK SHALL BE SIZED TO ACCOMMODATE INNER DIMENSIONS AND INSULATION THICKNESS.
2. EXPOSED DUCTWORK AND ALL ASSOCIATED APPURTENANCES, INCLUDING EQUIPMENT AND GRILLES / DIFFUSERS SHALL BE PAINTED BLACK TO MATCH THE CEILING. REFER TO ARCHITECTURAL PLANS AND SPECIFICATIONS FOR MORE INFORMATION.

### KEY NOTES:


1. CONTINUOUS LINEAR FLOOR GRILLE ABOVE RECESSED ELECTRIC BASEBOARD HEATER. PROVIDE CONTINUOUS SECTION. PROVIDE MITERED CORNER, AND VERIFY ALL DIMENSIONS IN FIELD.
2. POWER AND CONTROL MODULE SERVING FLOOR HEATERS. LOCATE WITHIN FLOOR TRENCH ADJACENT TO FLOOR HEATERS. DAISY CHAIN CONTROL WIRING BETWEEN FLOOR HEATERS. REFER TO MANUFACTURERS INSTRUCTIONS FOR INSTALLATION AND WIRING.
3. LINEAR RETURN WITH PLENUM SERVING DISPLAY.
4. TERMINAL UNIT SERVING FUTURE THEATER.
5. OPEN ENDED DUCT WITH WIRE MESH SCREEN. BALANCE TO CFM INDICATED.
6. TRANSFER DUCT. REFER TO DETAIL 9/M-601.

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**1 HVAC DUCTWORK LEVEL 1 - AREA B**  
1/8" = 1'-0"

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LS3P PROJECT: 7701-177800
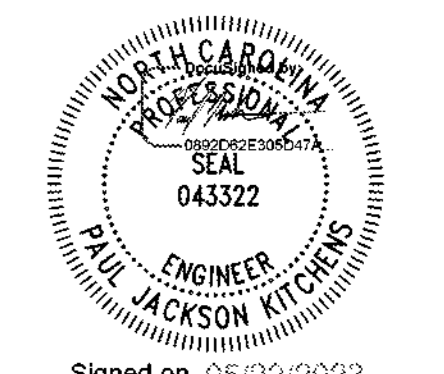
| DATE | DESCRIPTION           |
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| 0    | 2023.05.22 PERMIT SET |

SHEET NAME:  
HVAC DUCTWORK  
LEVEL 1 - AREA B

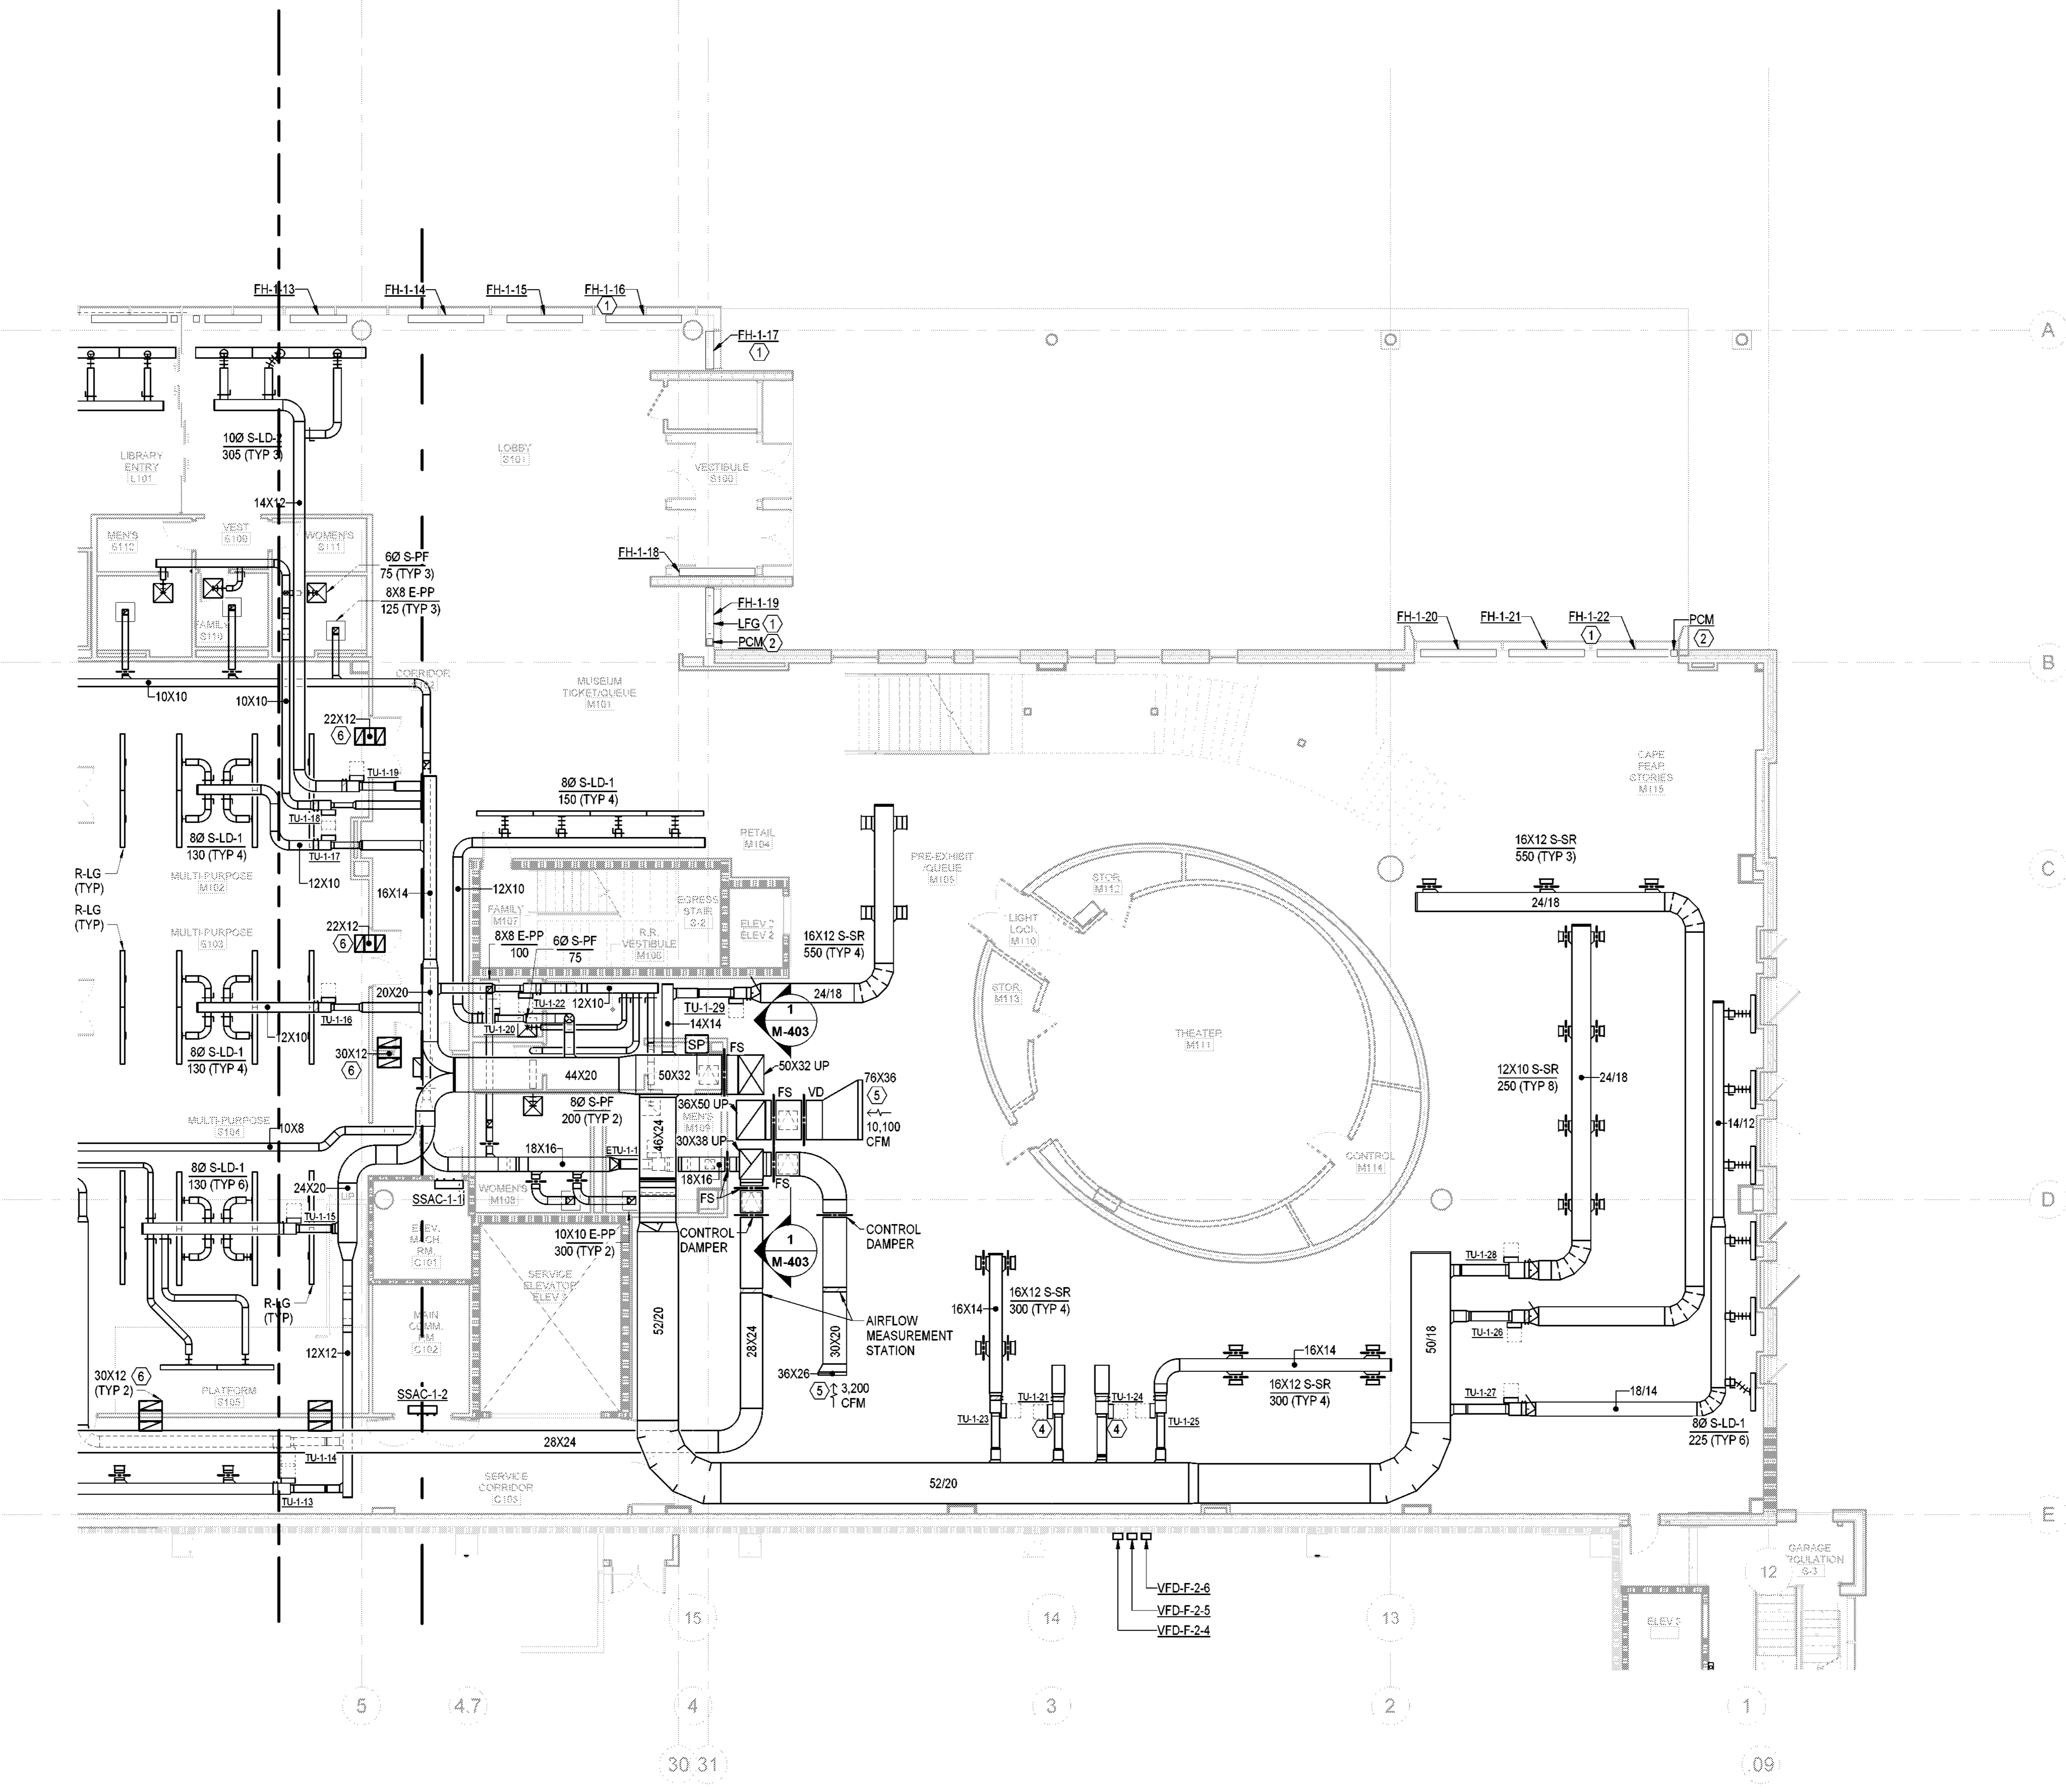ORIG SUBMISSION: 2023.05.22

SHEET:  
**M-101B**

PERMIT SET



**1 HVAC DUCTWORK LEVEL 2 - AREA B**  
1/8" = 1'-0"

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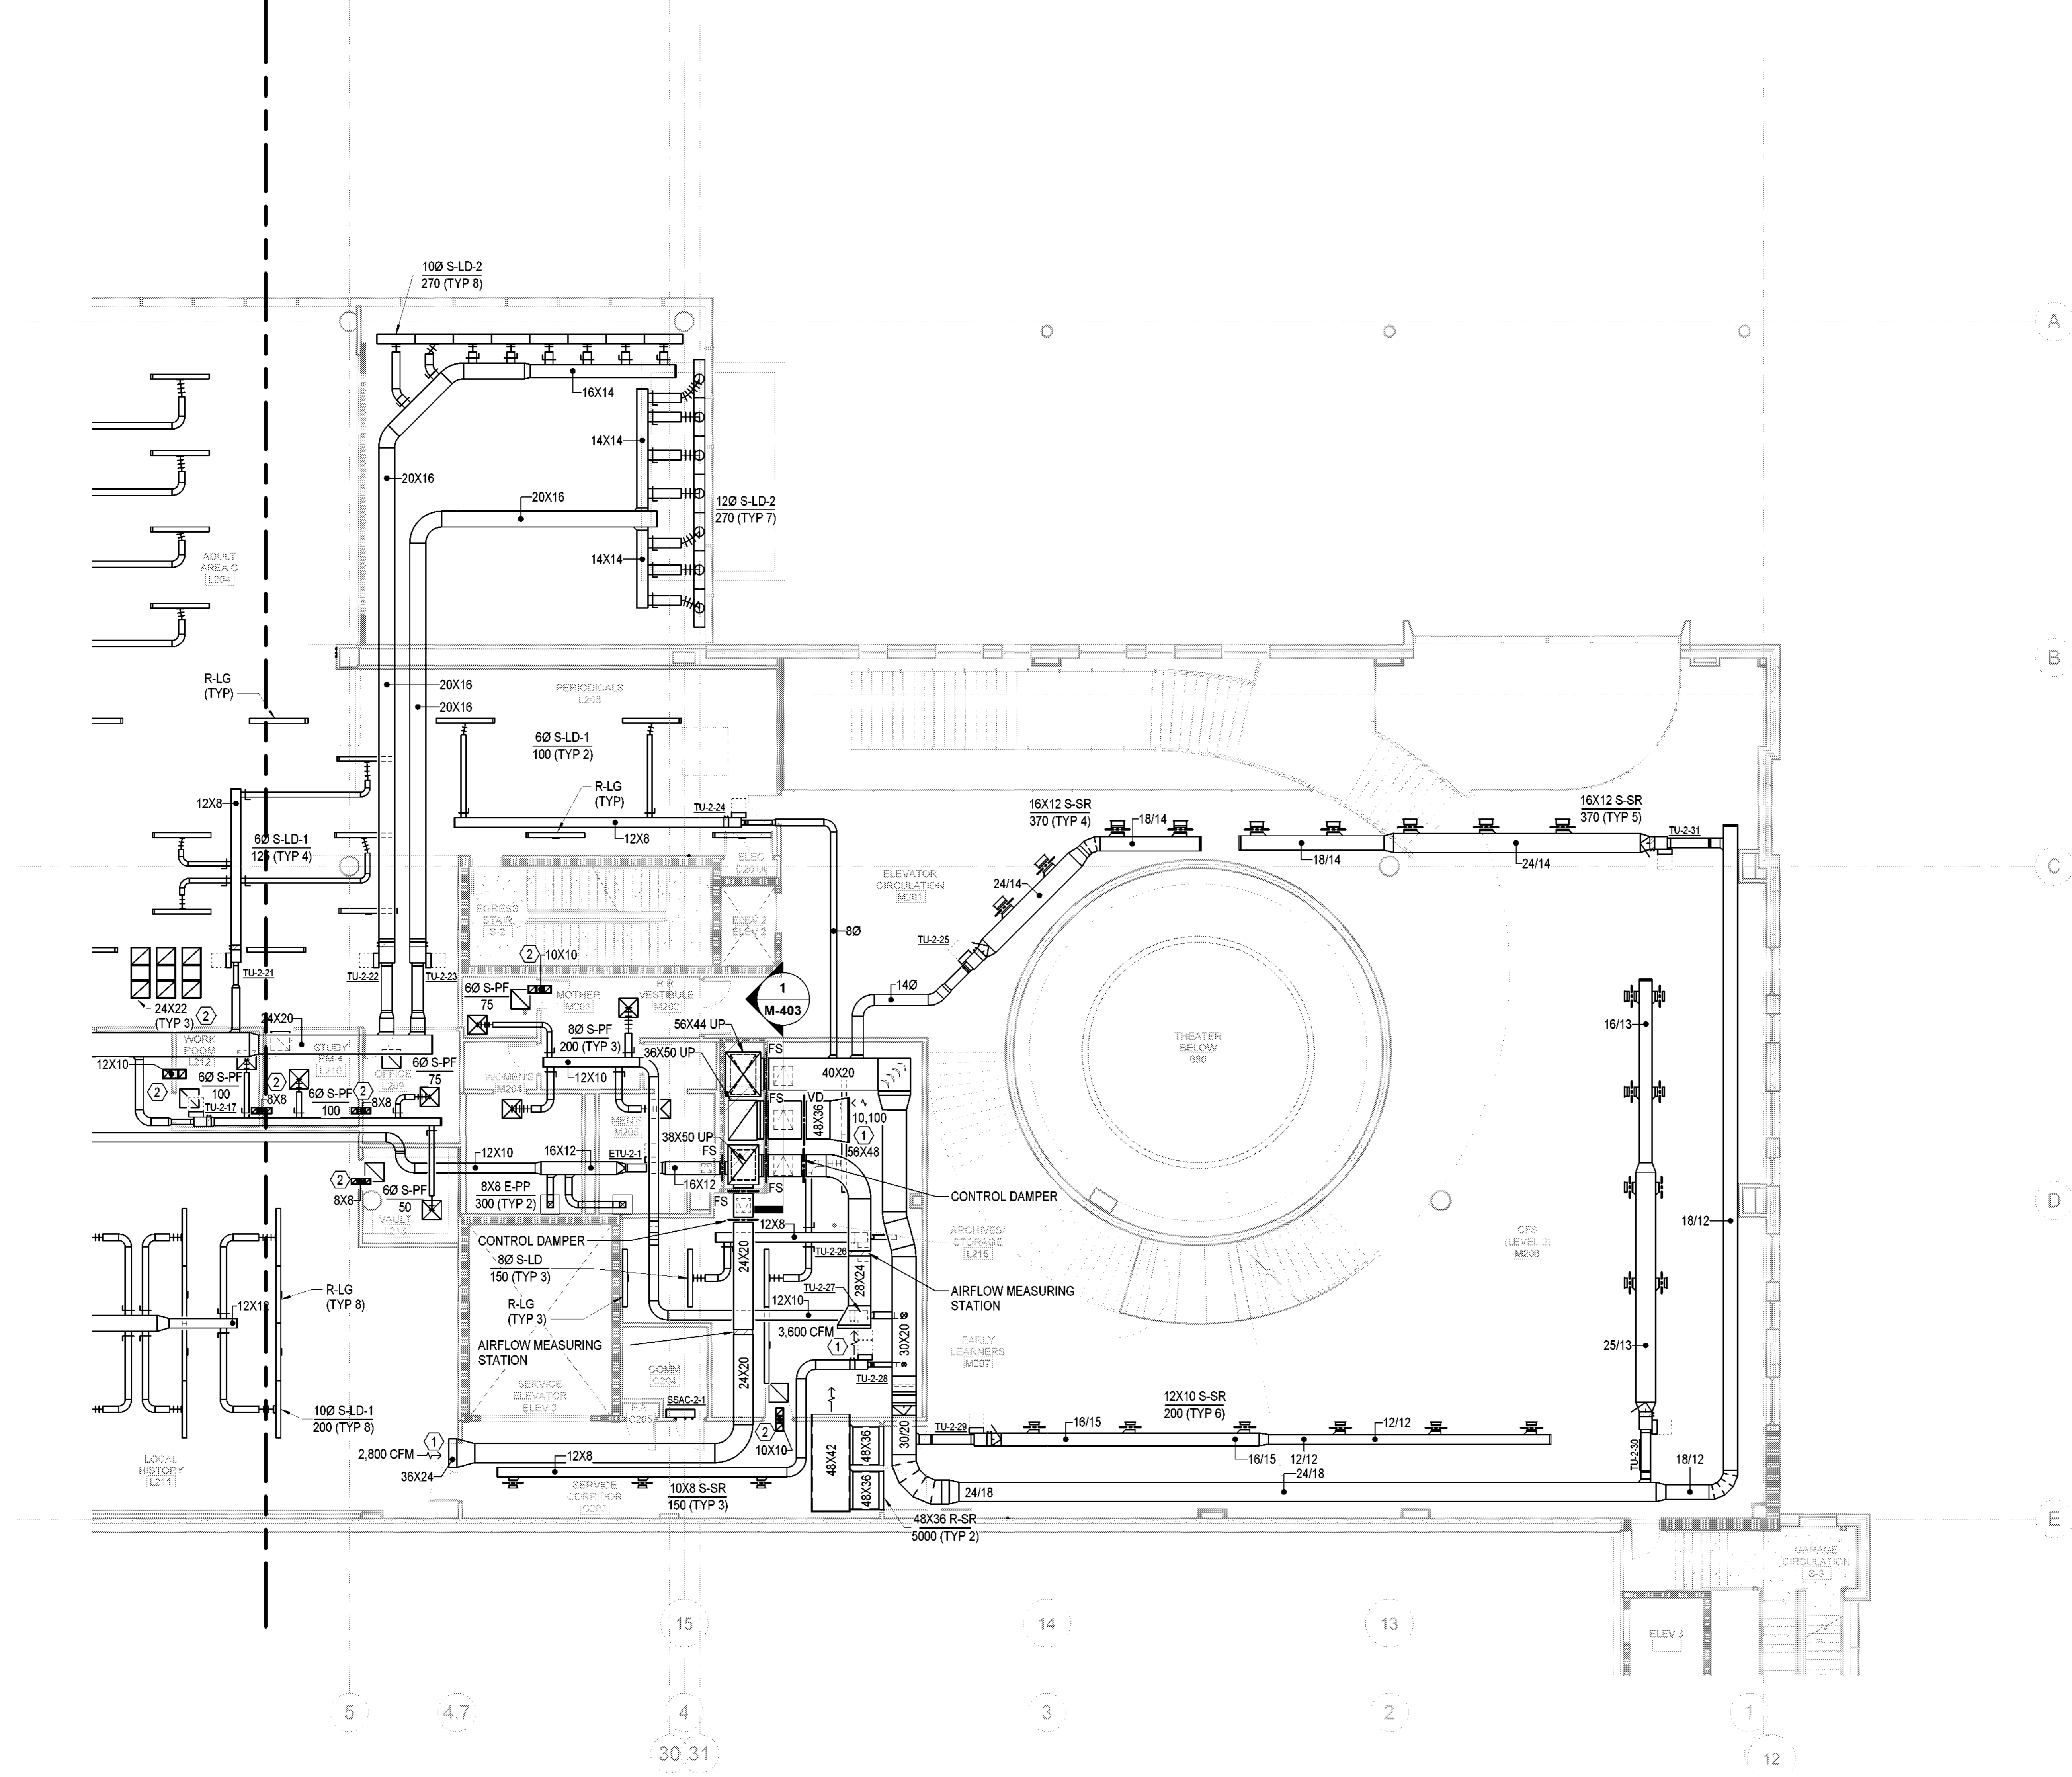
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**GENERAL NOTES:**

- 1. EXPOSED DUCTWORK LOCATED ABOVE GALLERY SPACES SHALL BE INSULATED DOUBLE WALL ROUND AND FLAT OVAL TYPE. DIMENSIONS ON PLANS REFER TO INTERNAL CLEAR DIMENSIONS. OUTER DUCTWORK SHALL BE SIZED TO ACCOMMODATE INNER DIMENSIONS AND INSULATION THICKNESS.
- 2. EXPOSED DUCTWORK AND ALL ASSOCIATED APPURTENANCES, INCLUDING EQUIPMENT AND GRILLES / DIFFUSERS SHALL BE PAINTED BLACK TO MATCH THE CEILING. REFER TO ARCHITECTURAL PLANS AND SPECIFICATIONS FOR MORE INFORMATION.

**KEY NOTES:**


- 1. OPEN ENDED DUCT WITH WIRE MESH SCREEN. BALANCE TO CFM INDICATED.
- 2. TRANSFER DUCT. REFER TO DETAIL 9/M-801.



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**SHEET NAME:**  
HVAC DUCTWORK  
LEVEL 2 - AREA B

**ORIG SUBMISSION:** 2023.05.22

**SHEET:**  
**M-102B**

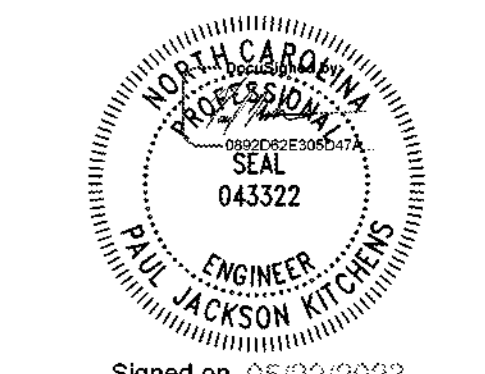

THESE DRAWINGS ARE EXACTLY  
AS SHOWN AND WITHOUT  
ANY OTHER NOTATIONS

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**GENERAL NOTES:**


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**KEY NOTES:**

- 1. TRANSFER DUCT. REFER TO DETAIL 9/M-801.

**ADDITIONAL ALTERNATE**

- 1. SCOPE ASSOCIATED WITH PARKING DECK ACCESS DOOR. A. DUCTWORK SHALL SHIFT TO BE HOUSED WITHIN ALTERNATE SHAFT LOCATION. ADJACENT SYSTEMS SHALL SHIFT TO ACCOMMODATE THE ALTERNATE SHAFT LOCATION. REFER TO ARCHITECTURAL DRAWINGS FOR MORE INFORMATION.

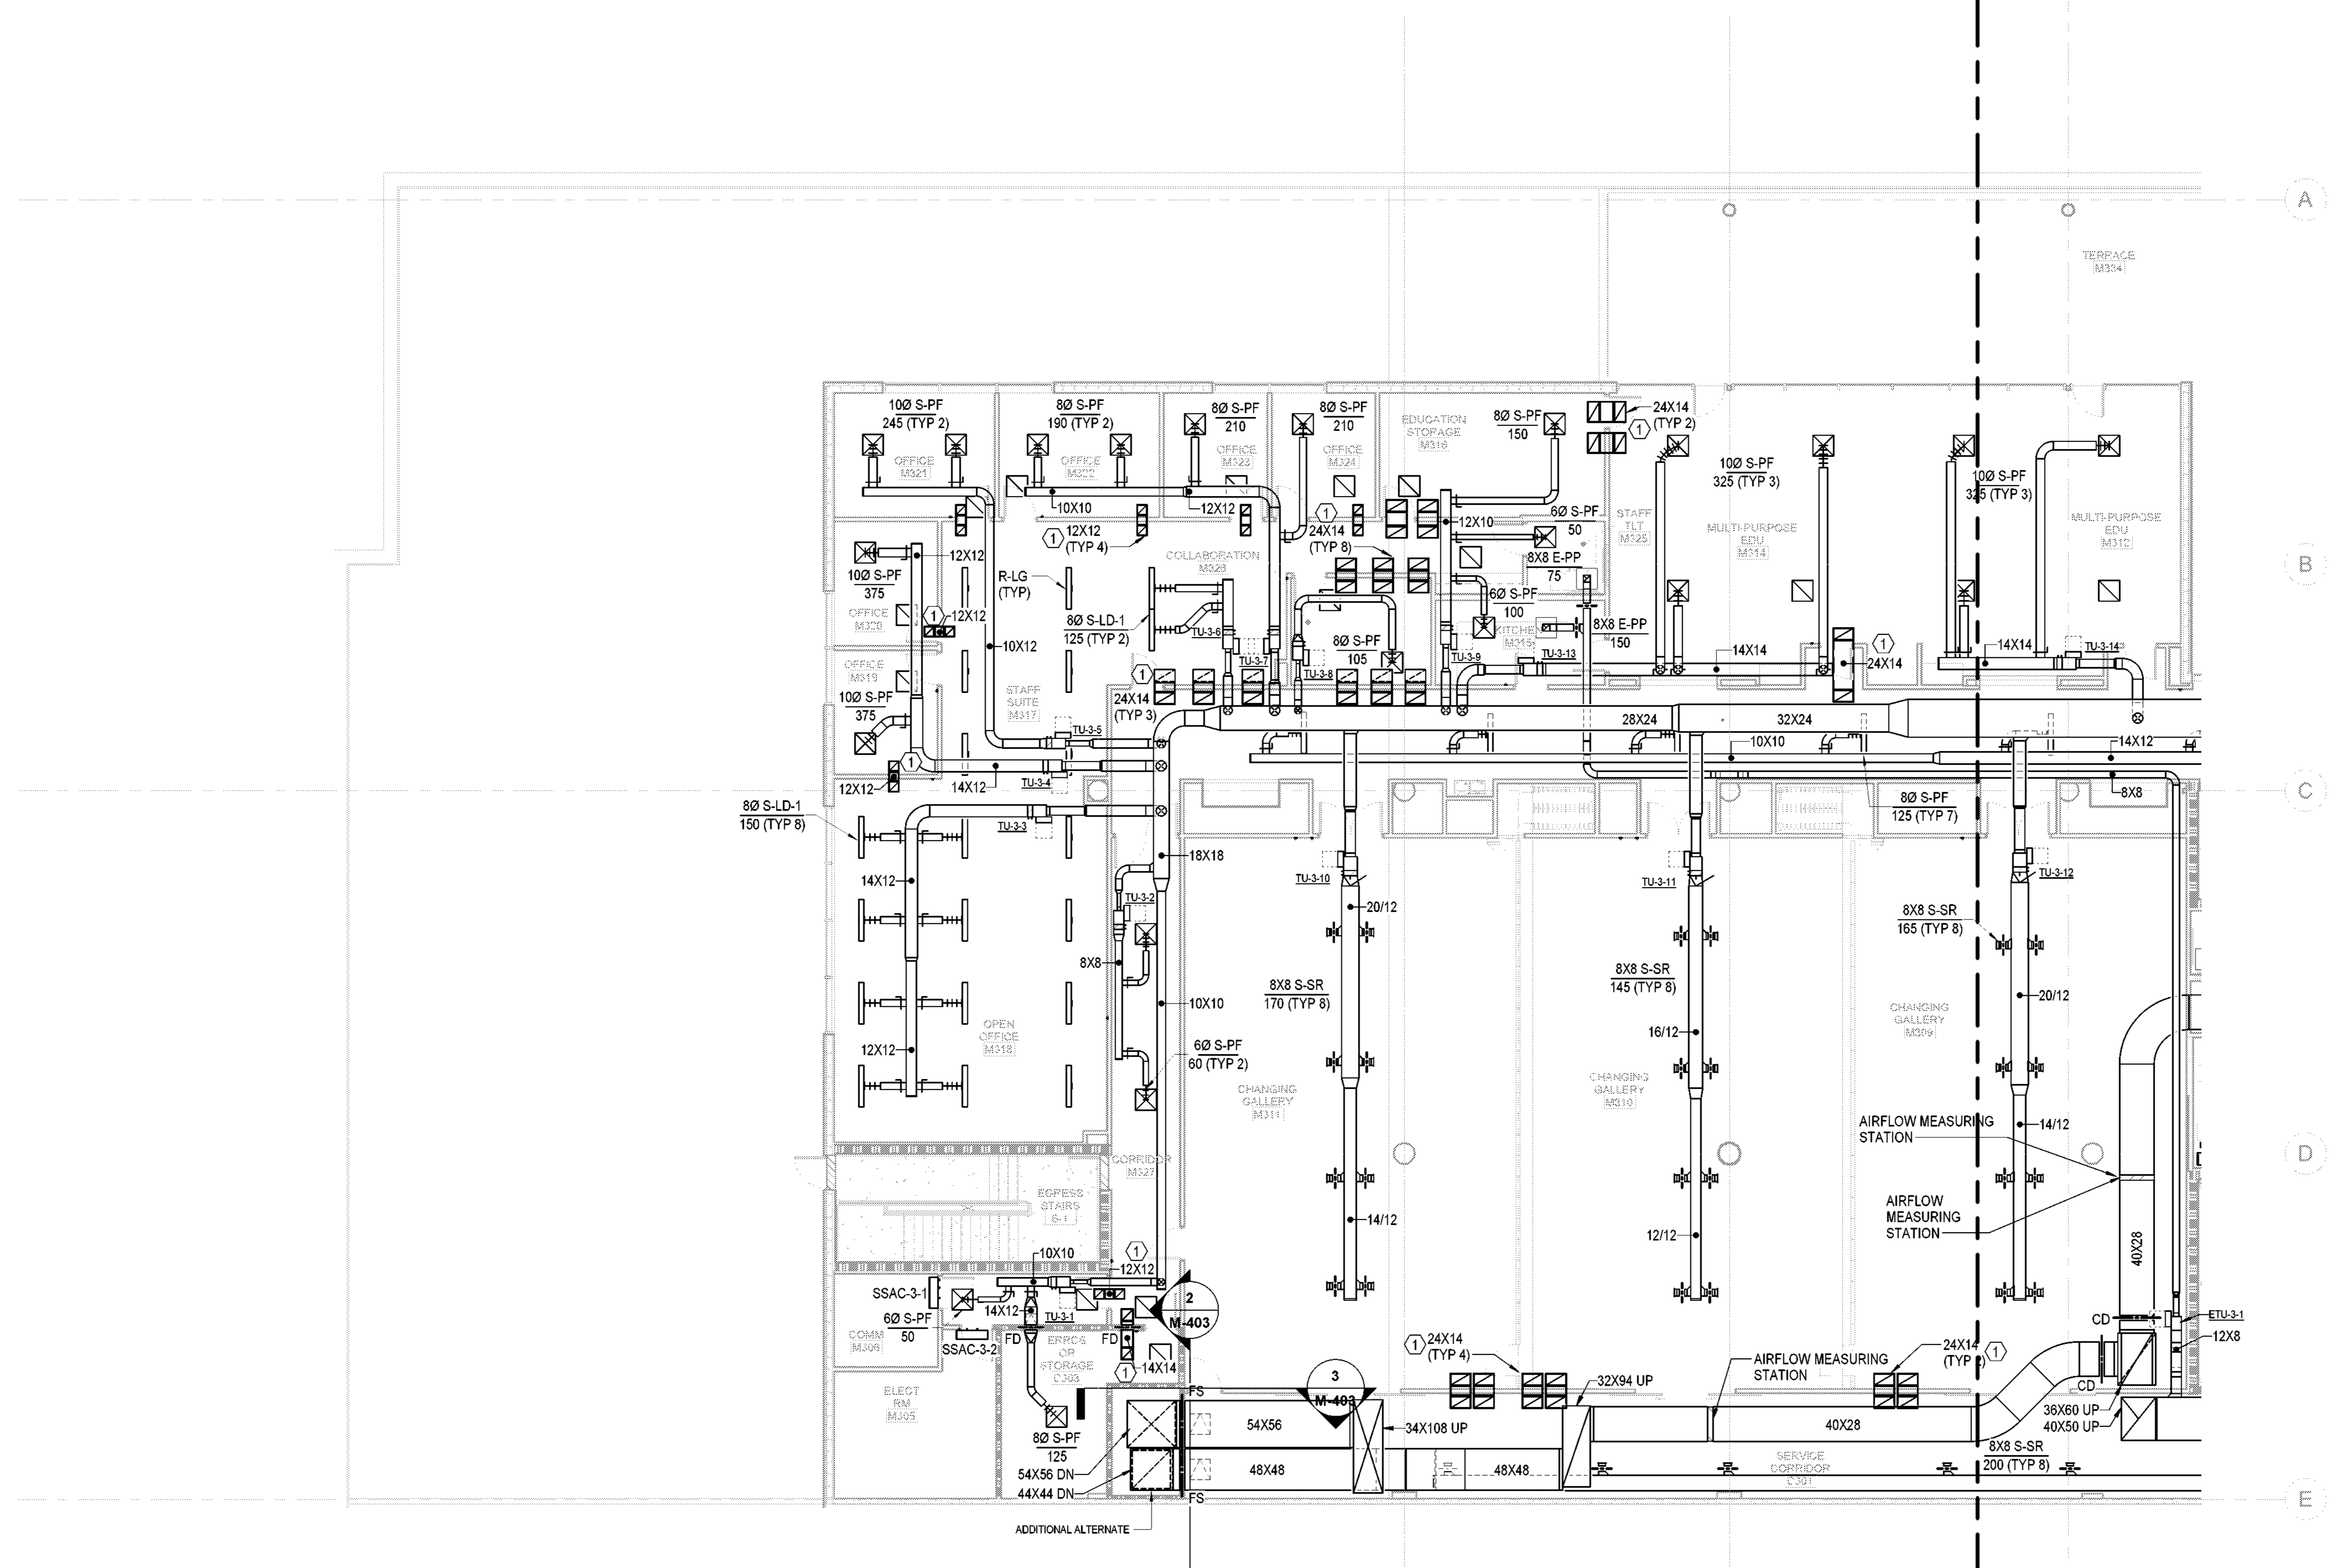


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Cape Fear Development

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LS3P PROJECT: 7701-177800

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SHEET NAME:  
**HVAC DUCTWORK  
LEVEL 3 - AREA A**

ORIG SUBMISSION: 2023.05.22

SHEET:  
**M-103A**

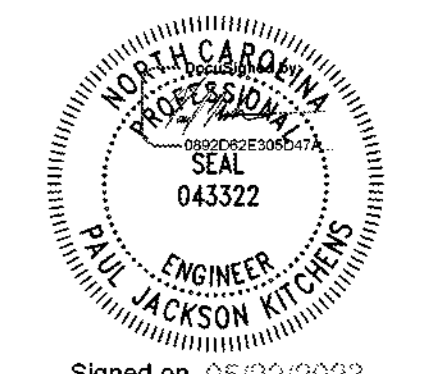PERMIT SET

**1 HVAC DUCTWORK LEVEL 3 - AREA A**  
1/8" = 1'-0"

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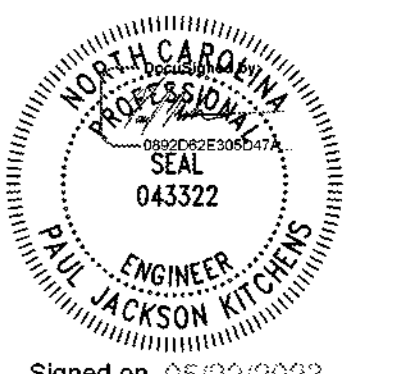
CFD Cape Fear Development

LS3P

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5425 Page Road Suite 215 Durham, NC 27703 T 919 783-7812 NB Contact: Brandon R. Nevin N&B PROJECT: 21N185 Newcomb & Boyd, LLP Firm Lic. # F-0312




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GENERAL NOTES:

- 1. EXPOSED DUCTWORK LOCATED ABOVE GALLERY SPACES SHALL BE INSULATED DOUBLE WALL ROUND AND FLAT OVAL TYPE. DIMENSIONS ON PLANS REFER TO INTERNAL CLEAR DIMENSIONS. OUTER DUCTWORK SHALL BE SIZED TO ACCOMMODATE INNER DIMENSIONS AND INSULATION THICKNESS.
2. EXPOSED DUCTWORK AND ALL ASSOCIATED APPURTENANCES, INCLUDING EQUIPMENT AND GRILLES / DIFFUSERS SHALL BE PAINTED BLACK TO MATCH THE CEILING. REFER TO ARCHITECTURAL PLANS AND SPECIFICATIONS FOR MORE INFORMATION.

KEY NOTES:

- 1. TRANSFER DUCT. REFER TO DETAIL 9/M-801.
2. AIR CURTAIN MOUNTED ABOVE CEILING. PROVIDE DUCTWORK FROM AIR CURTAIN DISCHARGE TO LINEAR DIFFUSER. PROVIDE DOOR CONTACT FOR OPERATION.
3. LINEAR DIFFUSER SUPPLY AND RETURN SERVING VESTIBULE. LINEAR DIFFUSERS SHALL NOT BE PROVIDED WITH PLENUM.
4. OPEN ENDED DUCT WITH WIRE MESH SCREEN. BALANCE TO CFM INDICATED.
5. DRYER VENT BOX WITH 4" DRYER VENT TO ROOF.

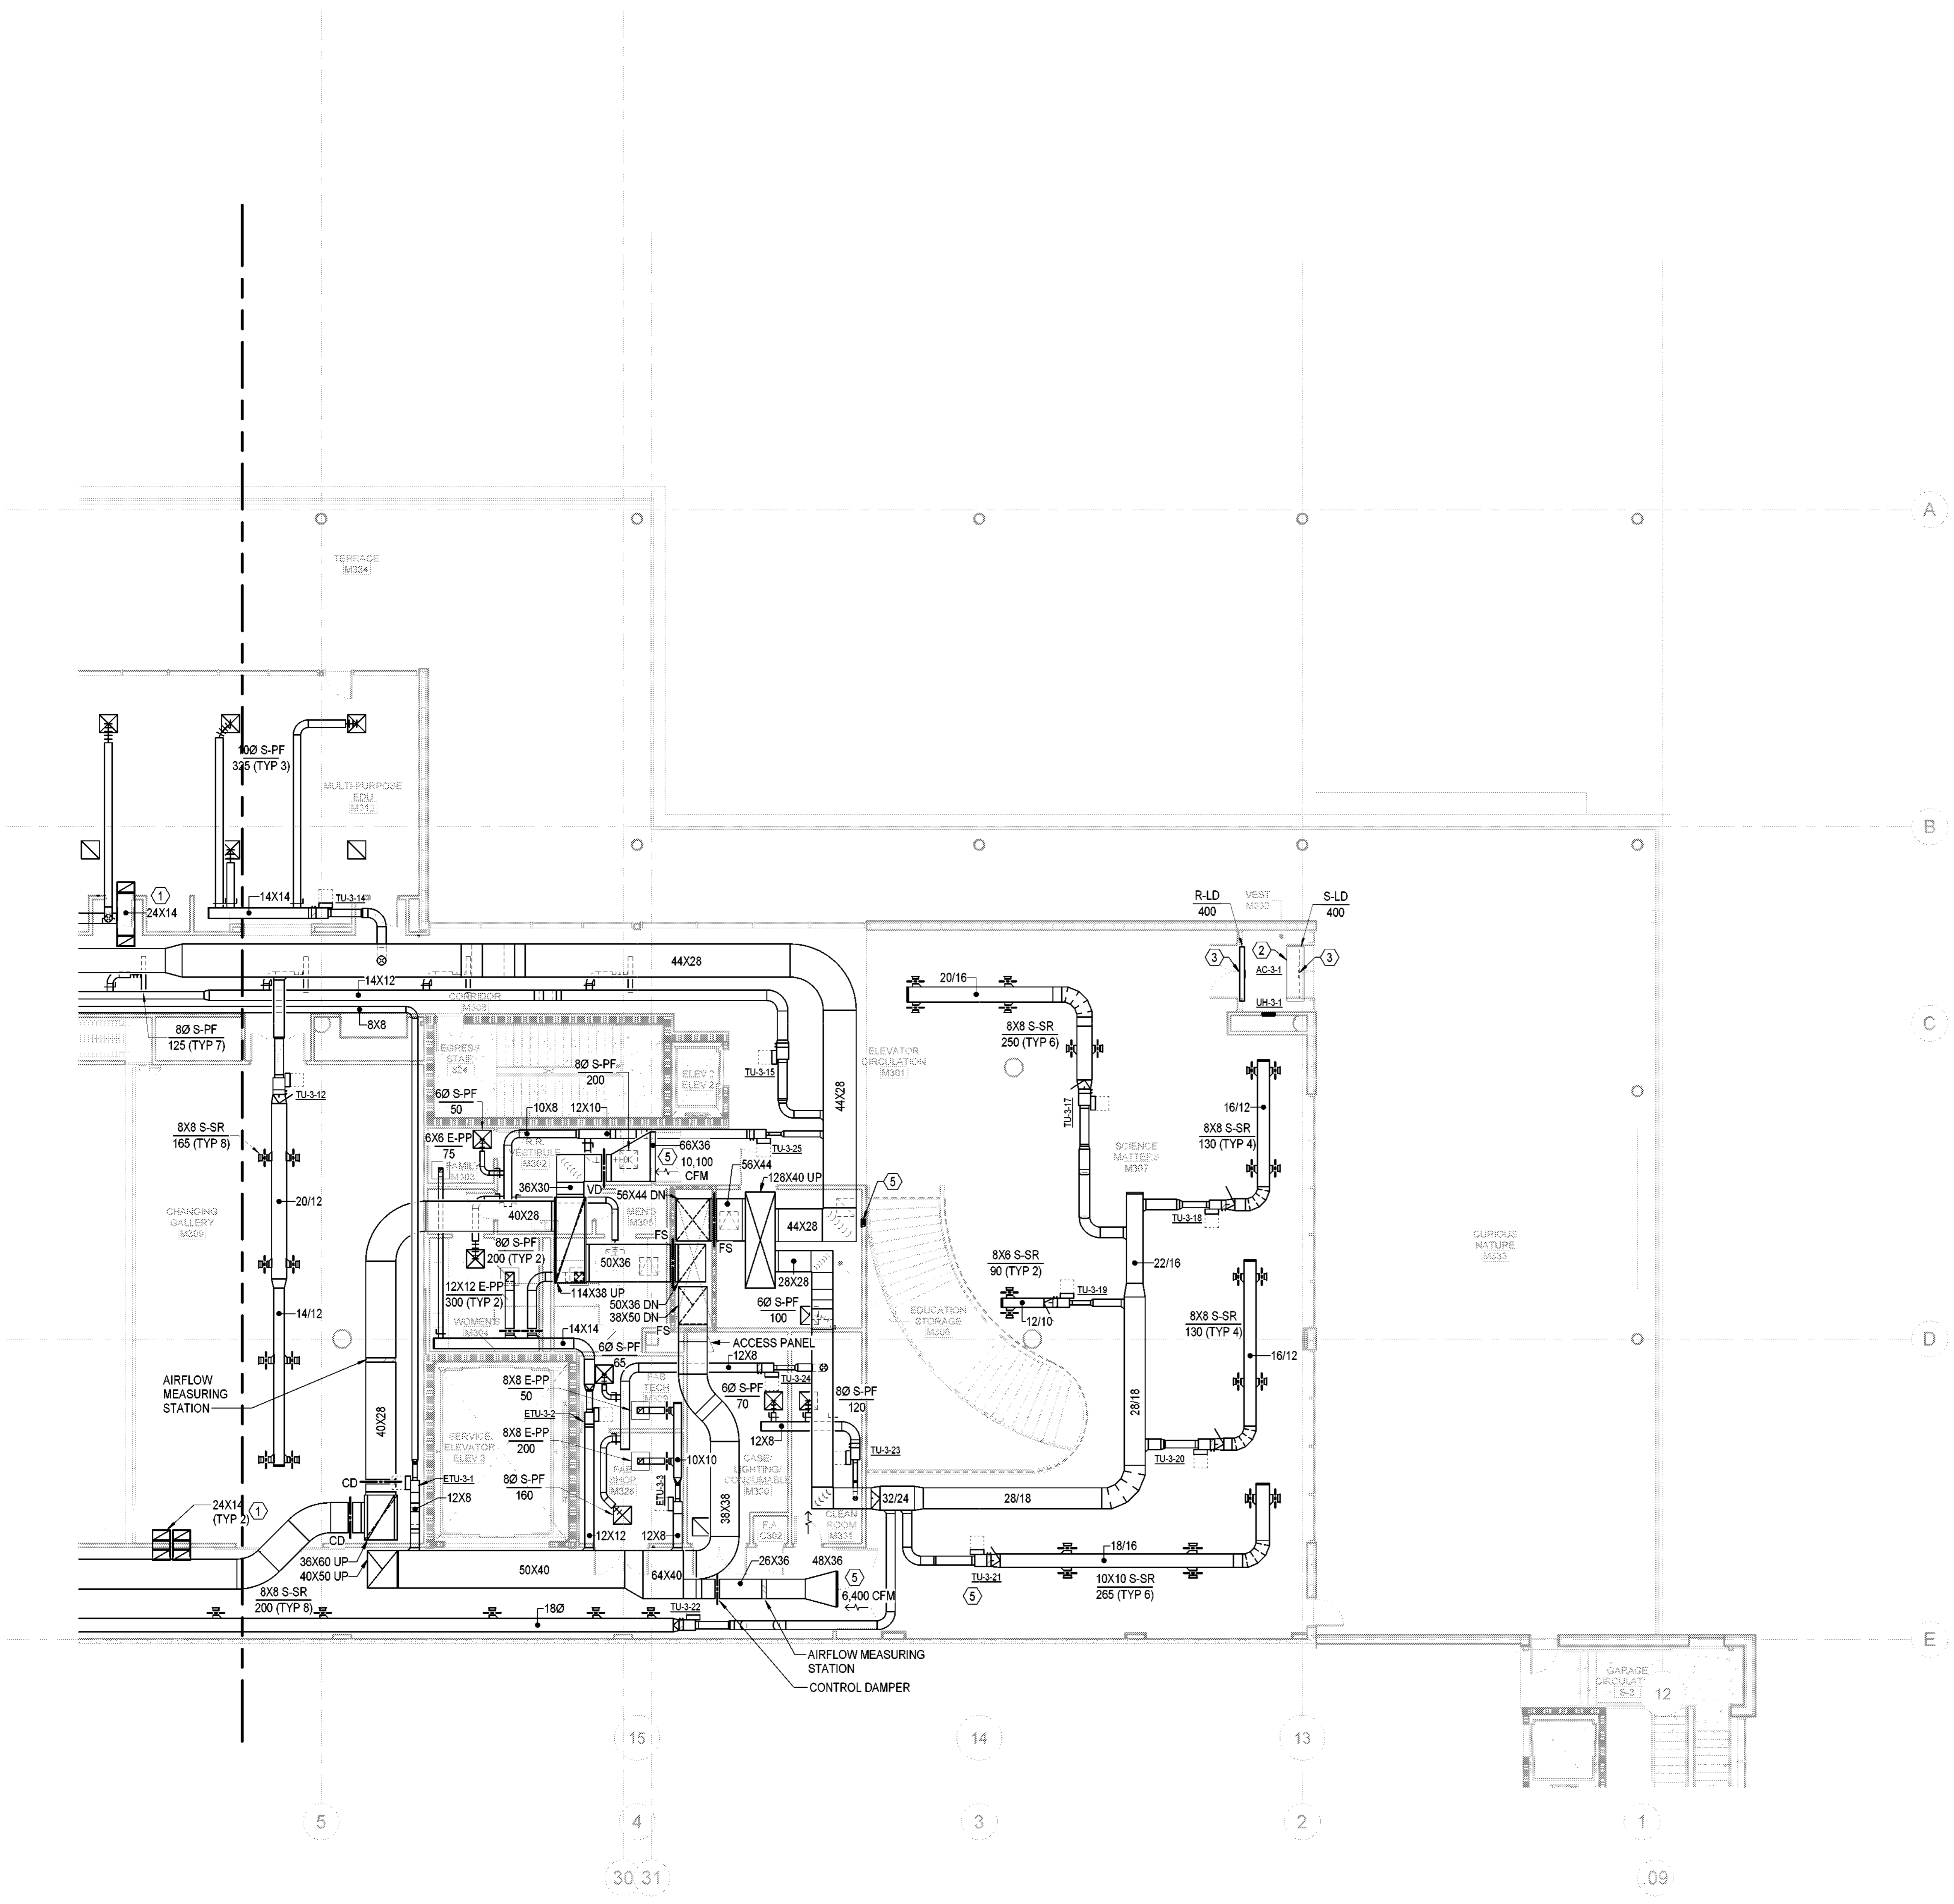

1 HVAC DUCTWORK LEVEL 3 - AREA B 1/8" = 1'-0"

Project Grace

Grace Street Wilmington, NC 28401

LS3P PROJECT: 7701-177800

Revision table with columns for DATE and DESCRIPTION. Row 0: 2023.05.22 PERMIT SET

SHEET NAME: HVAC DUCTWORK LEVEL 3 - AREA B

ORIG SUBMISSION: 2023.05.22

SHEET: M-103B

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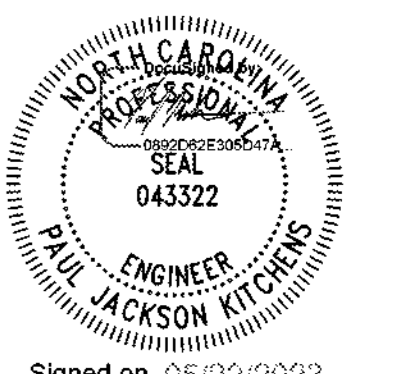
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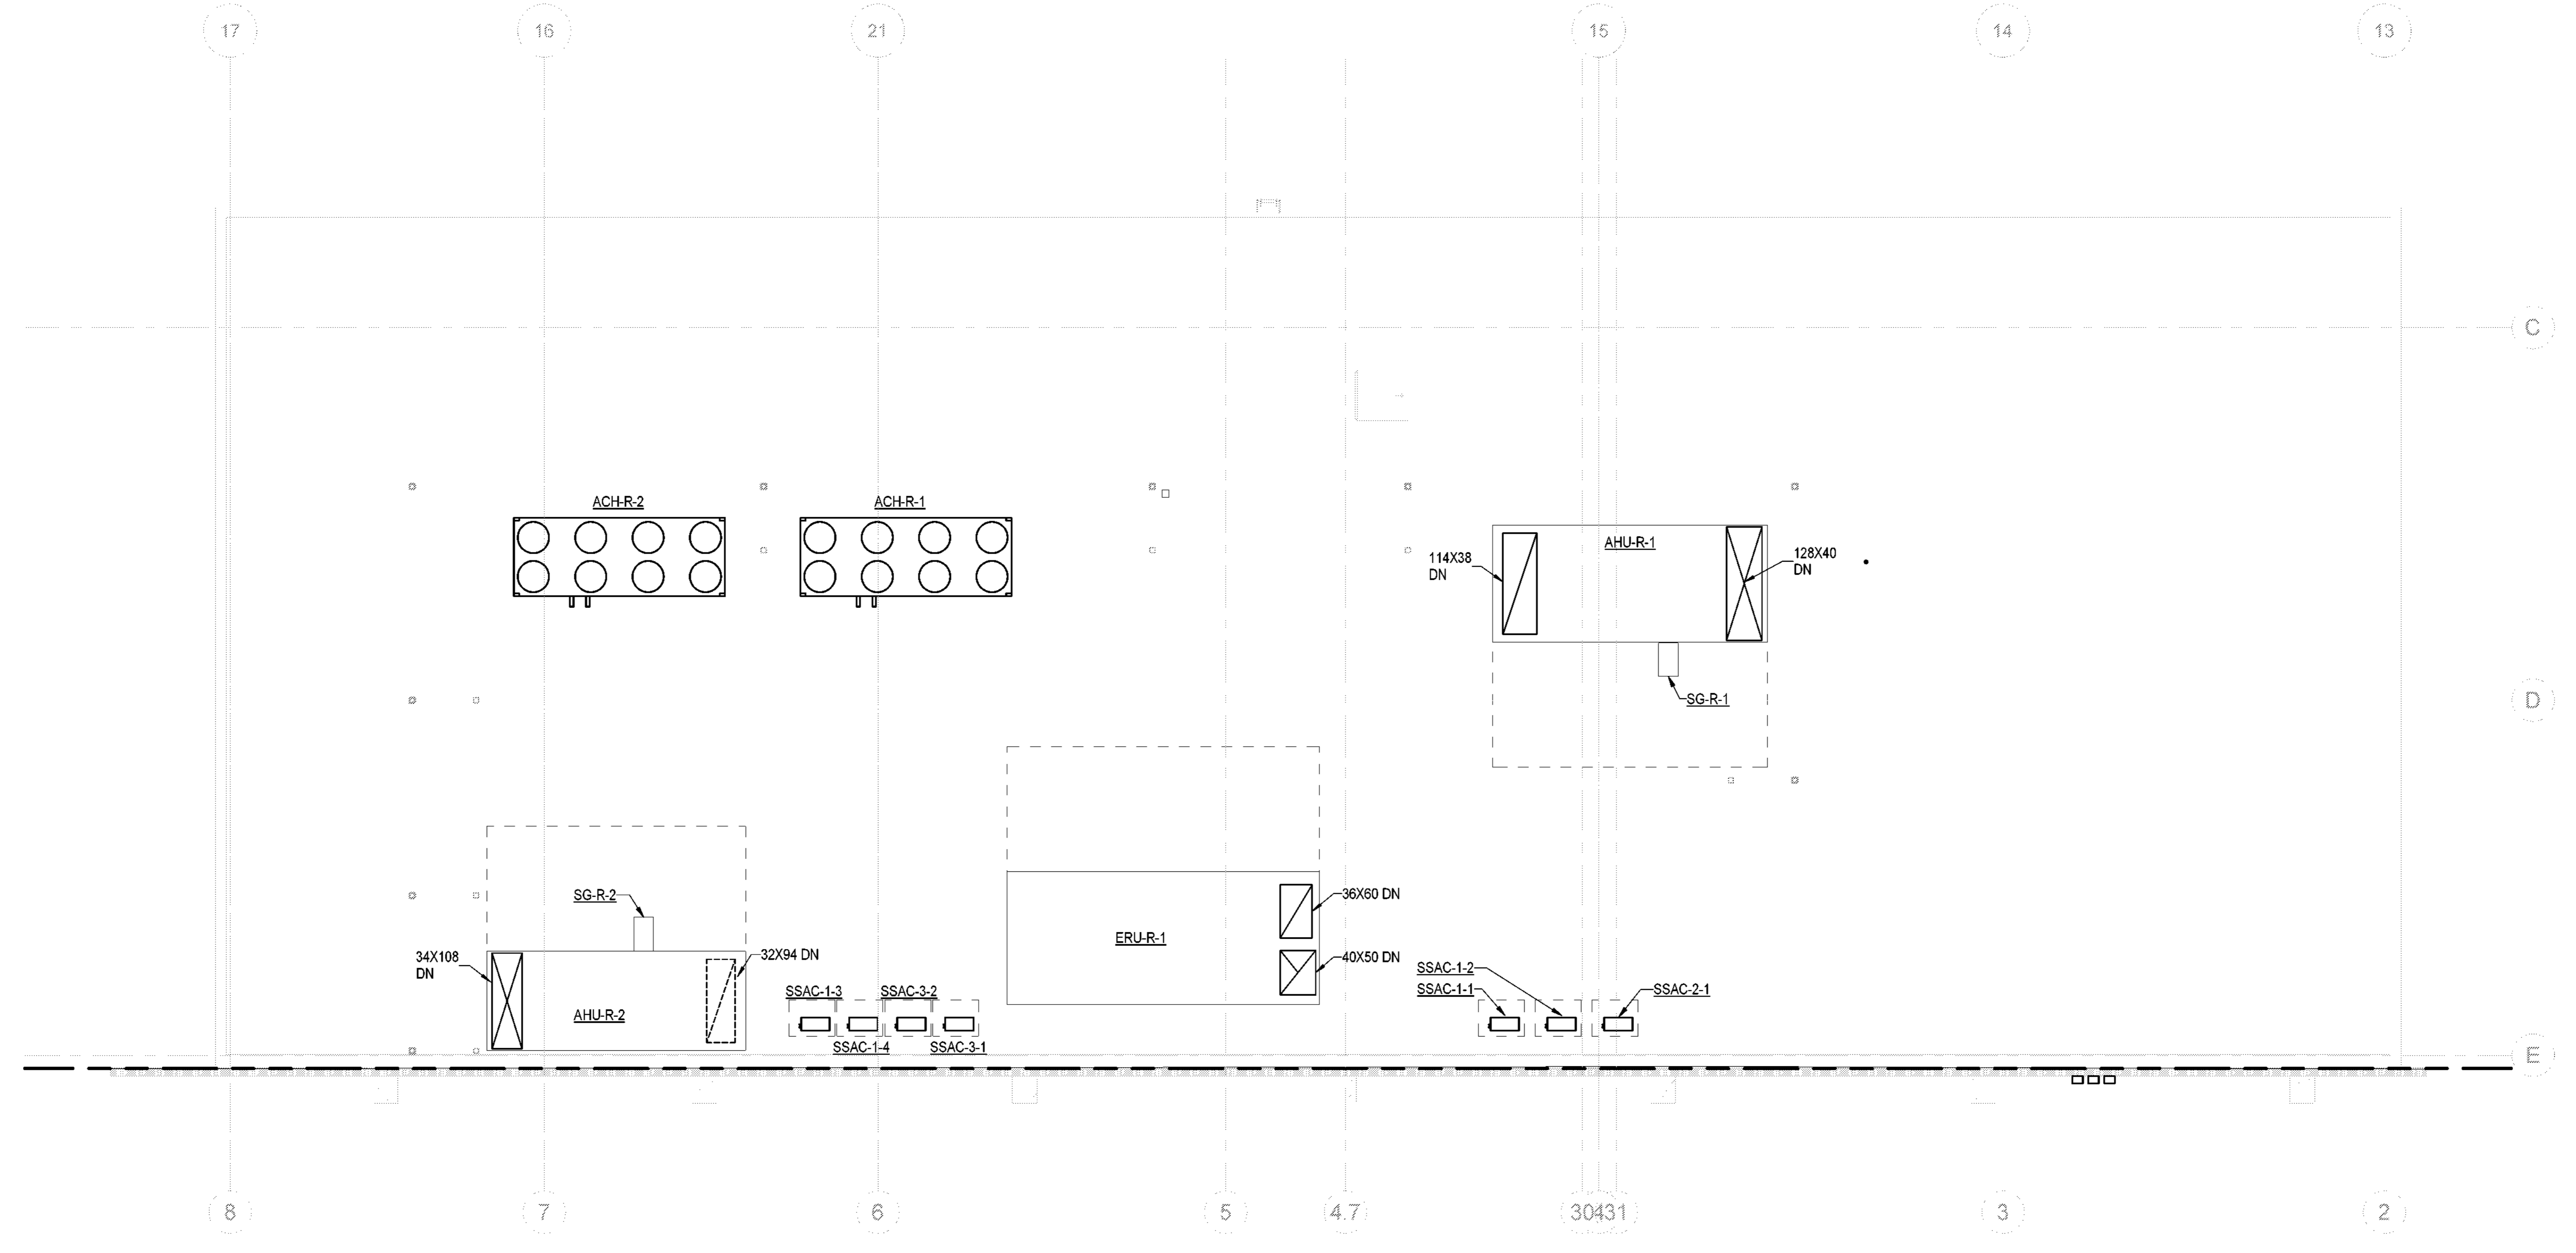
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**Project Grace**

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LS3P PROJECT: 7701-177800

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SHEET NAME:  
HVAC DUCTWORK  
OVERALL ROOF

ORIG: 2023.05.22  
SUBMISSION:

SHEET: **M-104**

PERMIT SET

**1 HVAC DUCTWORK OVERALL ROOF**

1/8" = 1'-0"

1 2 3 4 5 6

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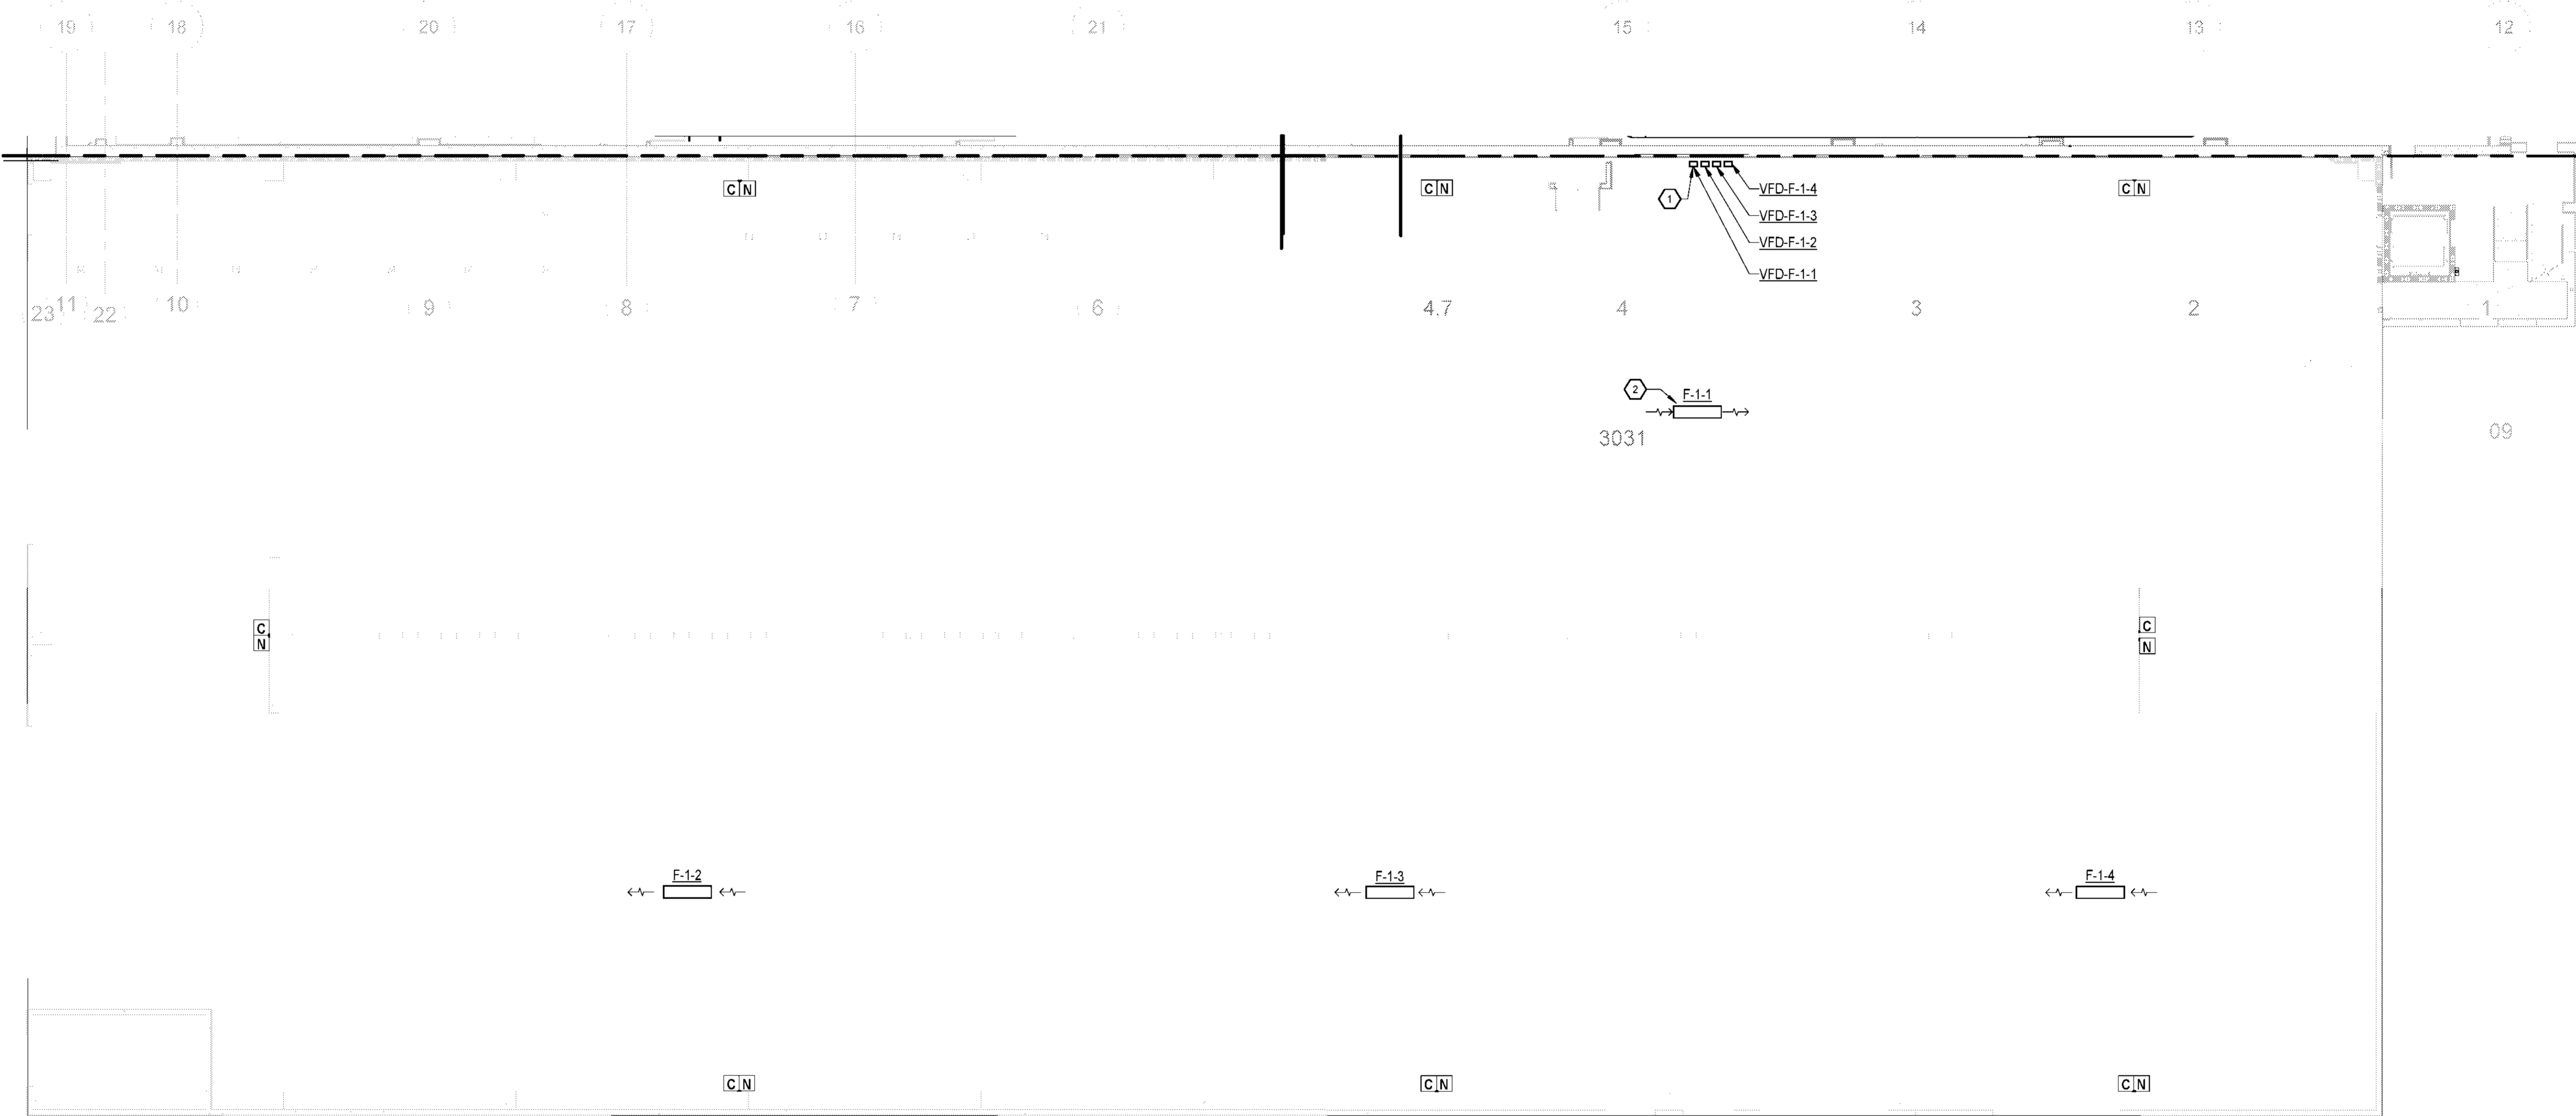
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**HVAC PARKING DECK LEVEL 1**

3/32" = 1'-0"

**KEY NOTES:**

- 1. VFD'S SERVING PARKING DECK JET FANS. PROVIDE WITH NEMA-4 ENCLOSURE RATED FOR OUTDOOR APPLICATION. PROVIDE TAMPER PROOF WIRE ENCLOSURE WITH GATE AND LOCK AROUND VFD'S. PROVIDE BOLLARDS IN FRONT OF VFD'S. TYPICAL FOR ALL LEVELS OF PARKING DECK
- 2. JET FAN LOCATED ON GROUND LEVEL OF PARKING DECK BELOW FIRST FLOOR RAMP




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**Project Grace**

Grace Street  
Wilmington, NC 28401

LS3P PROJECT: 7701-177600

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**SHEET NAME:**  
HVAC PARKING DECK LEVEL 1

**ORIG SUBMISSION:** 2023.05.22

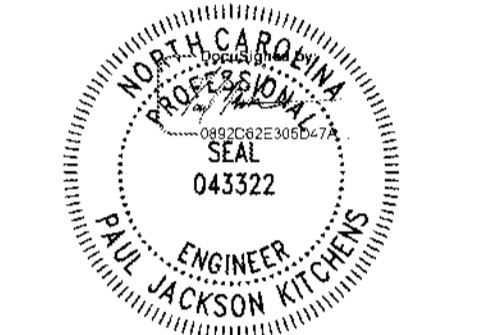**SHEET:**  
**M-105**

PERMIT SET


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**1 HVAC PARKING DECK LEVEL 2**  
3/32" = 1'-0"

**KEY NOTES:**

1. VFD'S SERVING PARKING DECK JET FANS. PROVIDE WITH NEMA-4 ENCLOSURE RATED FOR OUTDOOR APPLICATION. PROVIDE TAMPER PROOF WIRE ENCLOSURE WITH GATE AND LOCK AROUND VFD'S. PROVIDE BOLLARDS IN FRONT OF VFD'S. TYPICAL FOR ALL LEVELS OF PARKING DECK




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LS3P PROJECT: 7701-177800
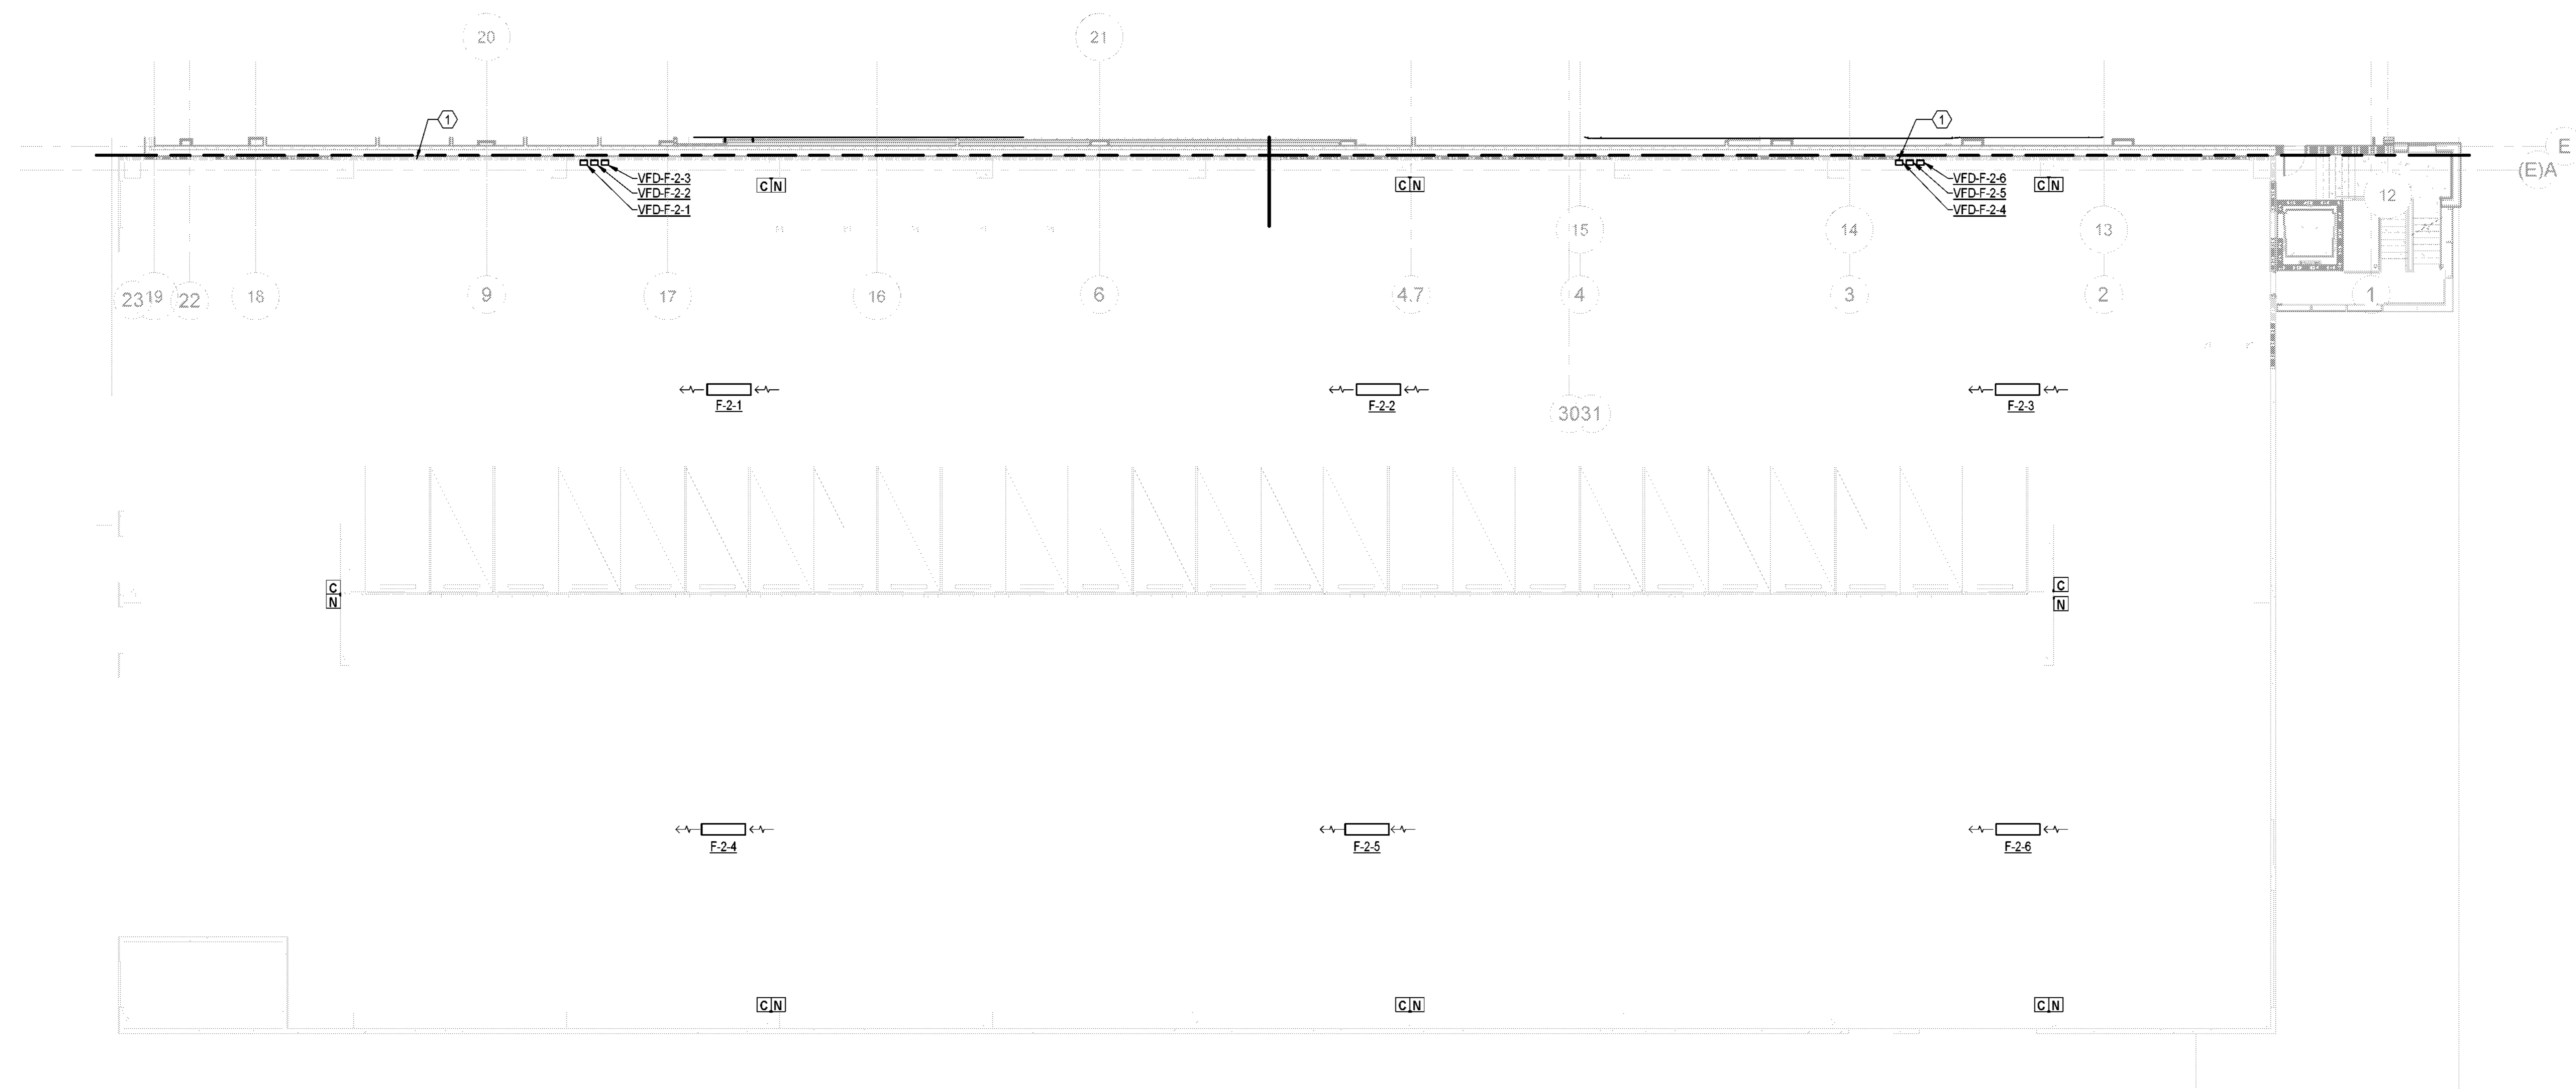
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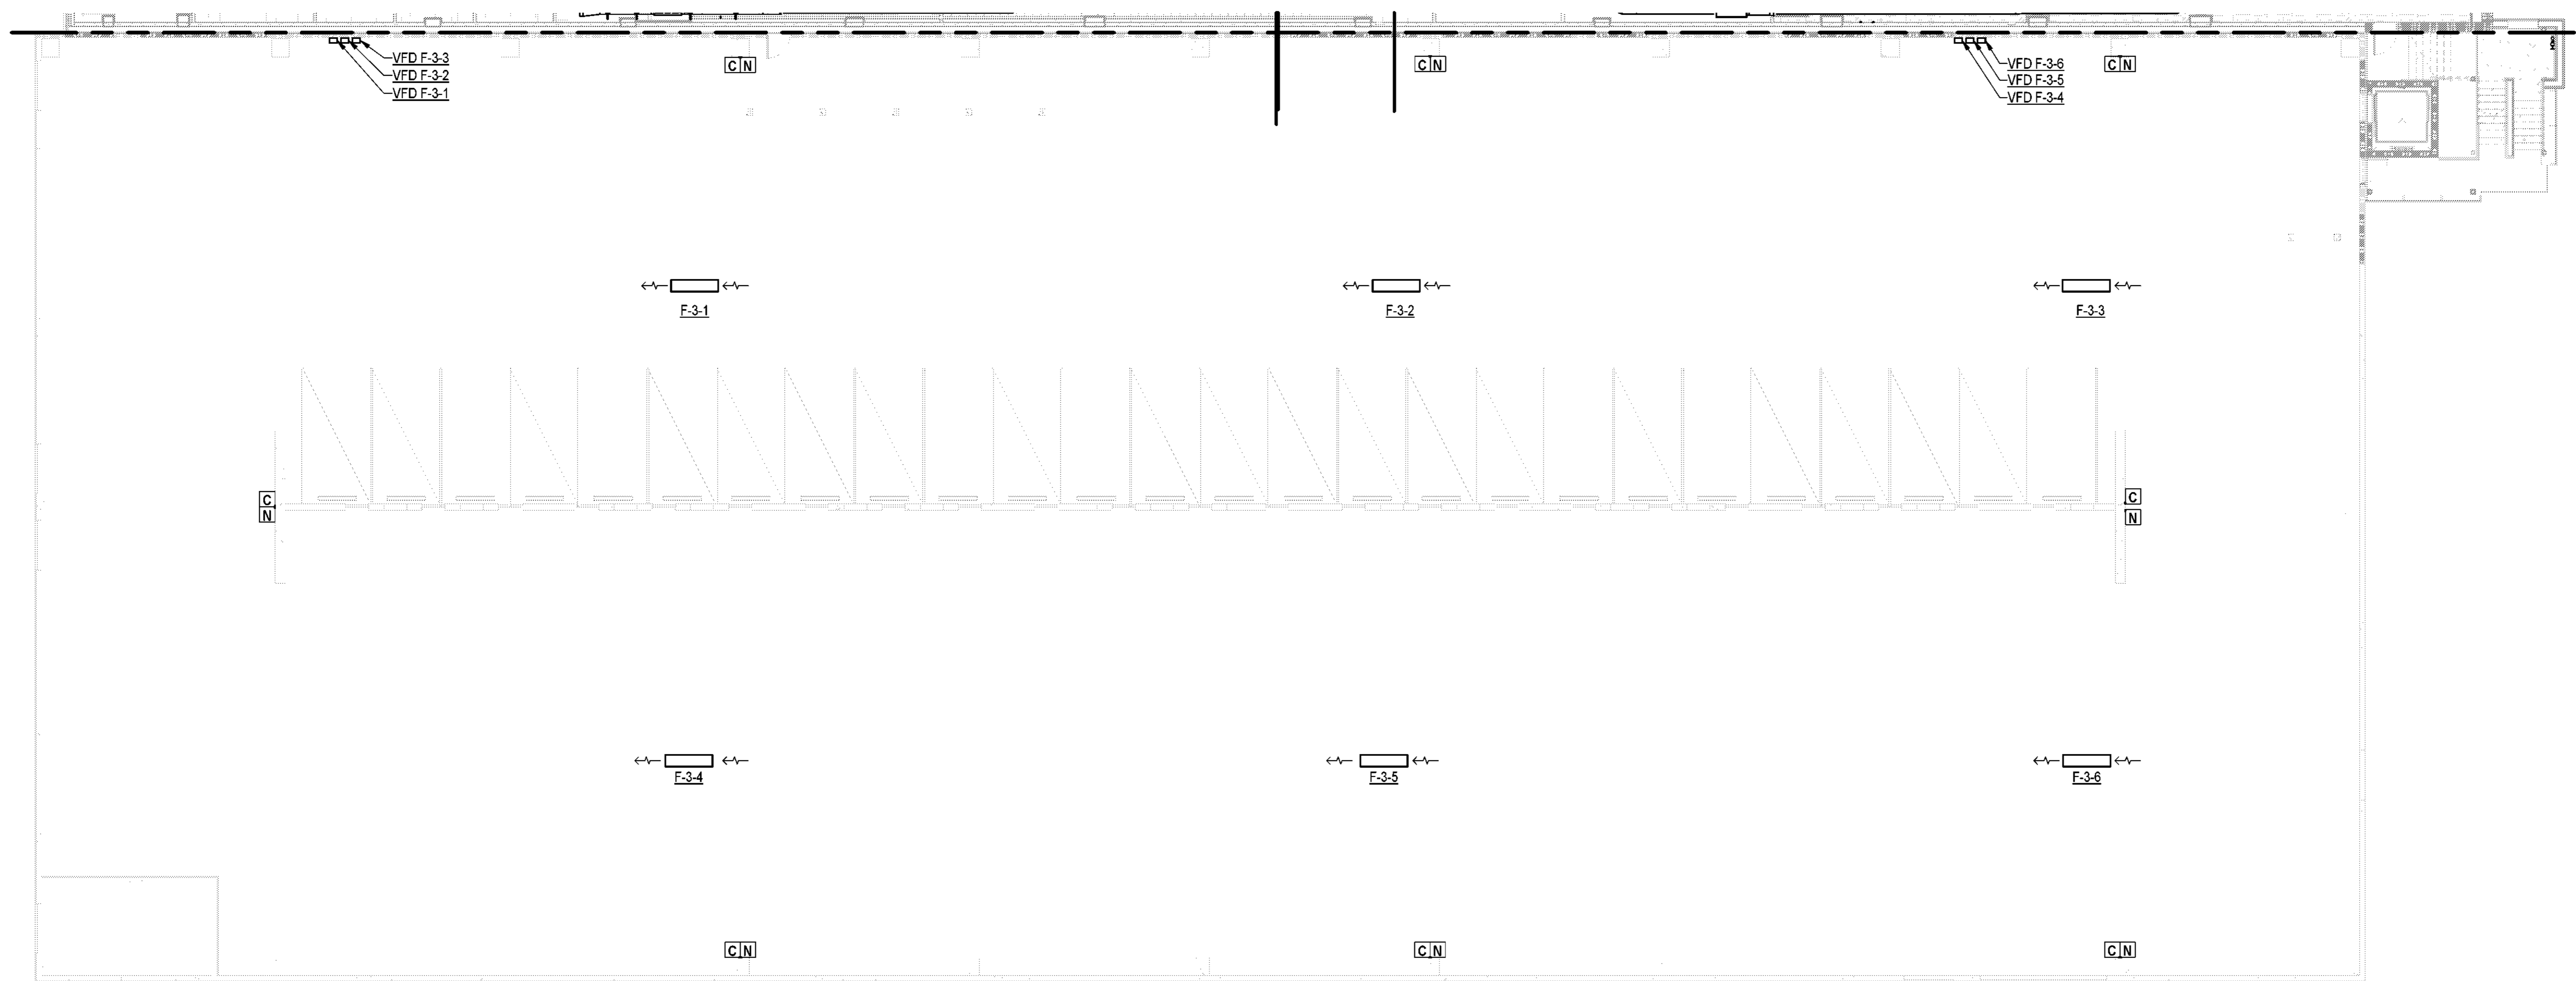
SHEET NAME:  
**HVAC PARKING DECK LEVEL 2**

ORIG SUBMISSION: 2023.05.22

SHEET: **M-106**

PERMIT SET

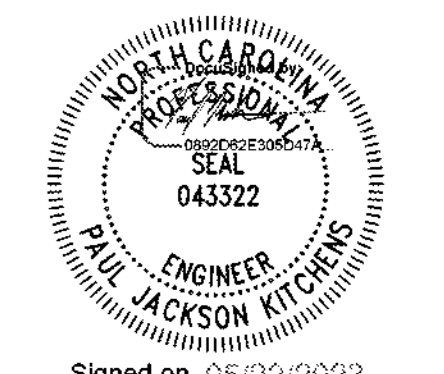1 HVAC PARKING DECK LEVEL 3  
3/32" = 1'-0"




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LS3P PROJECT: 7701-177800

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SHEET NAME:  
HVAC PARKING  
DECK LEVEL 3

ORIG SUBMISSION: 2023.05.22

SHEET: M-107


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1 HVAC PARKING DECK LEVEL 4  
3/32" = 1'-0"

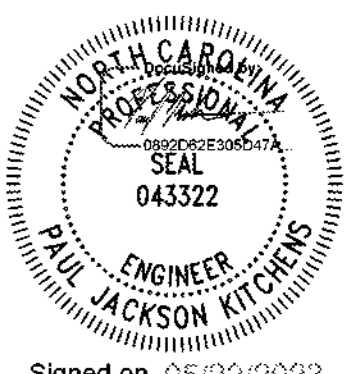


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SHEET NAME:  
HVAC PARKING  
DECK LEVEL 4

ORIG SUBMISSION: 2023.05.22

SHEET: M-108
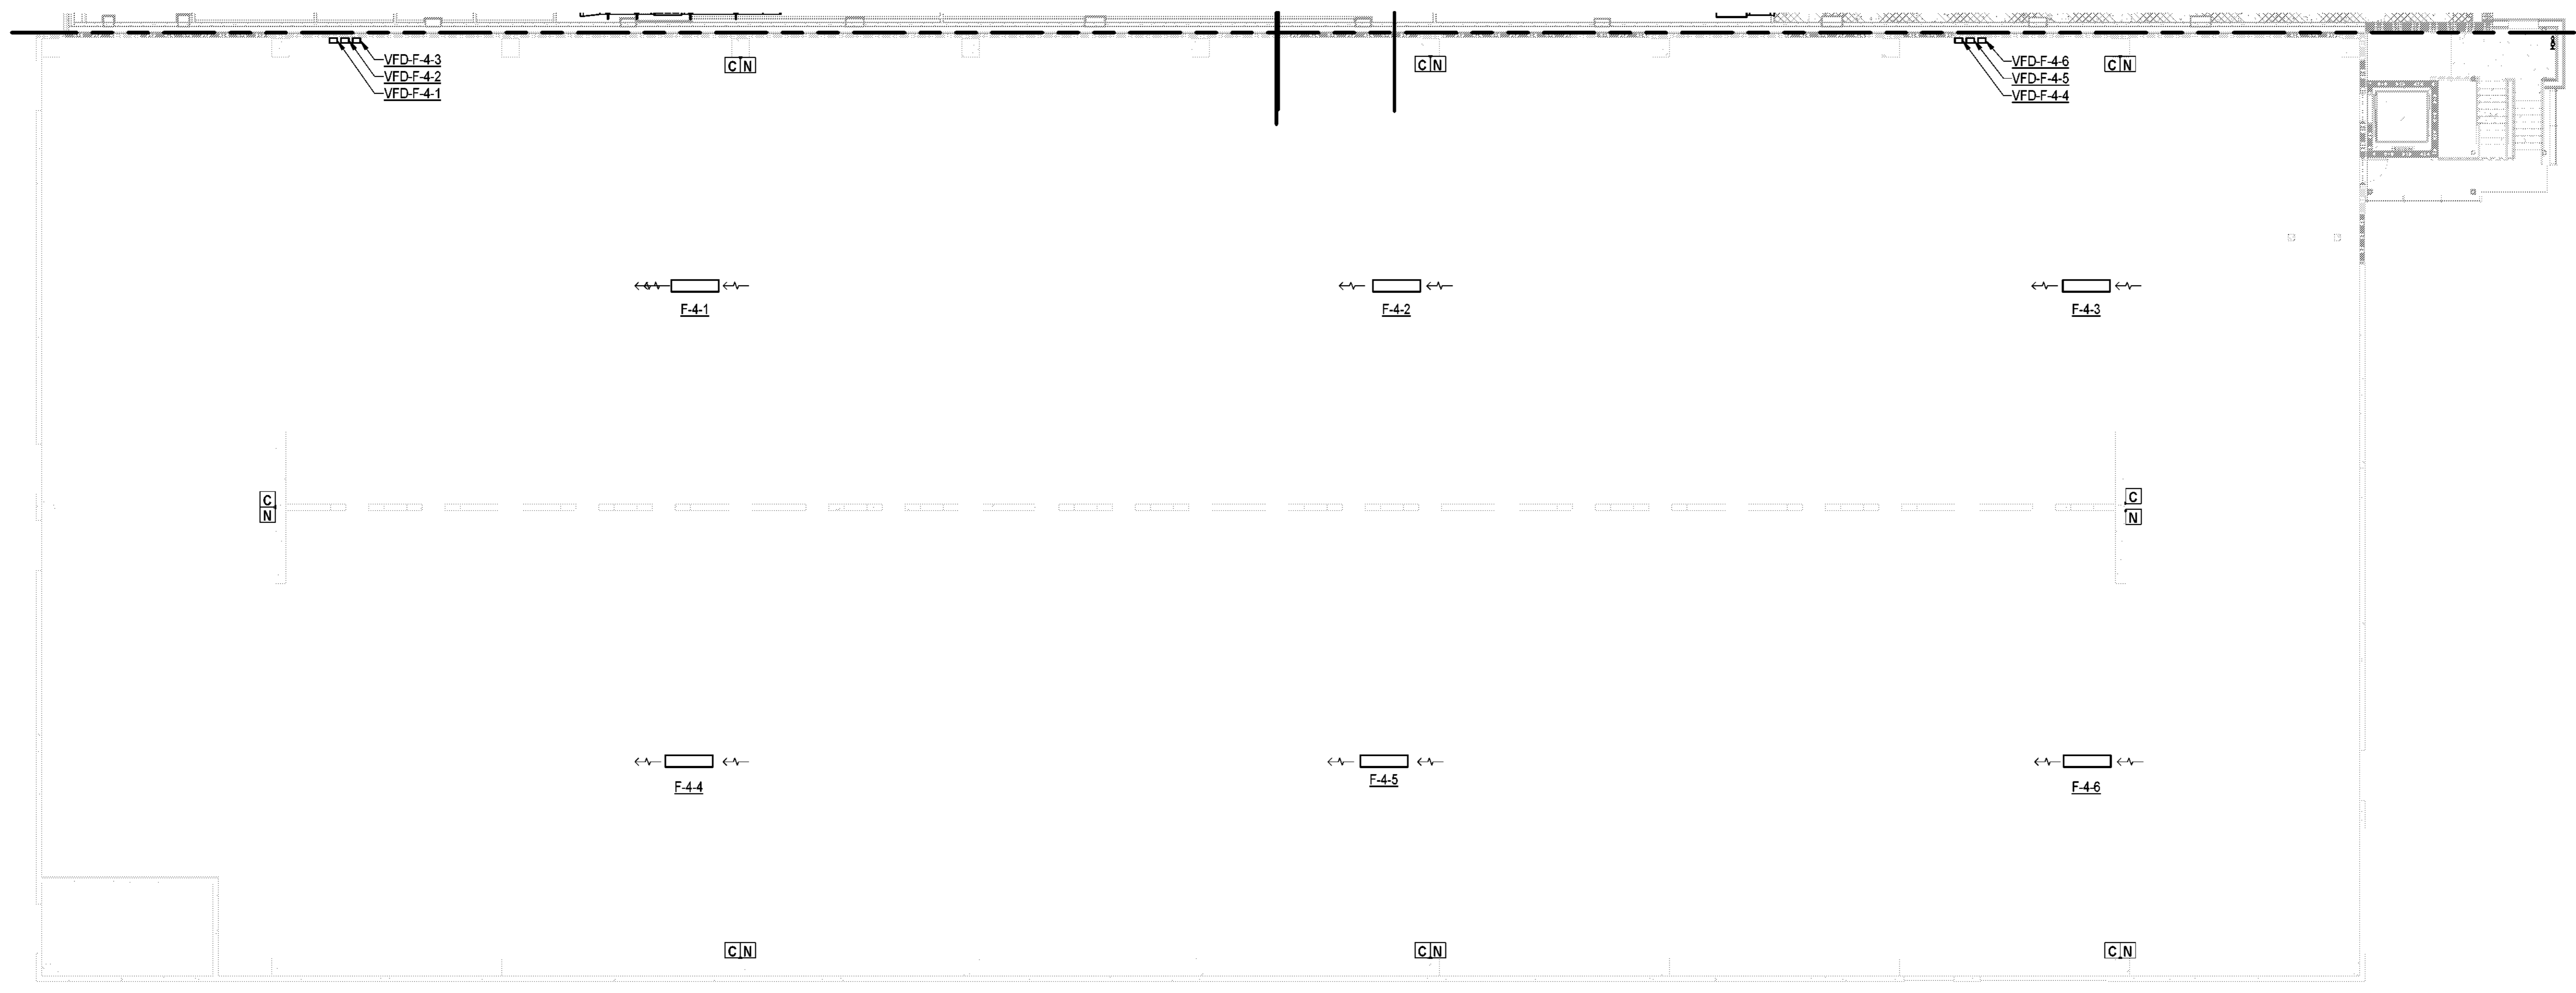
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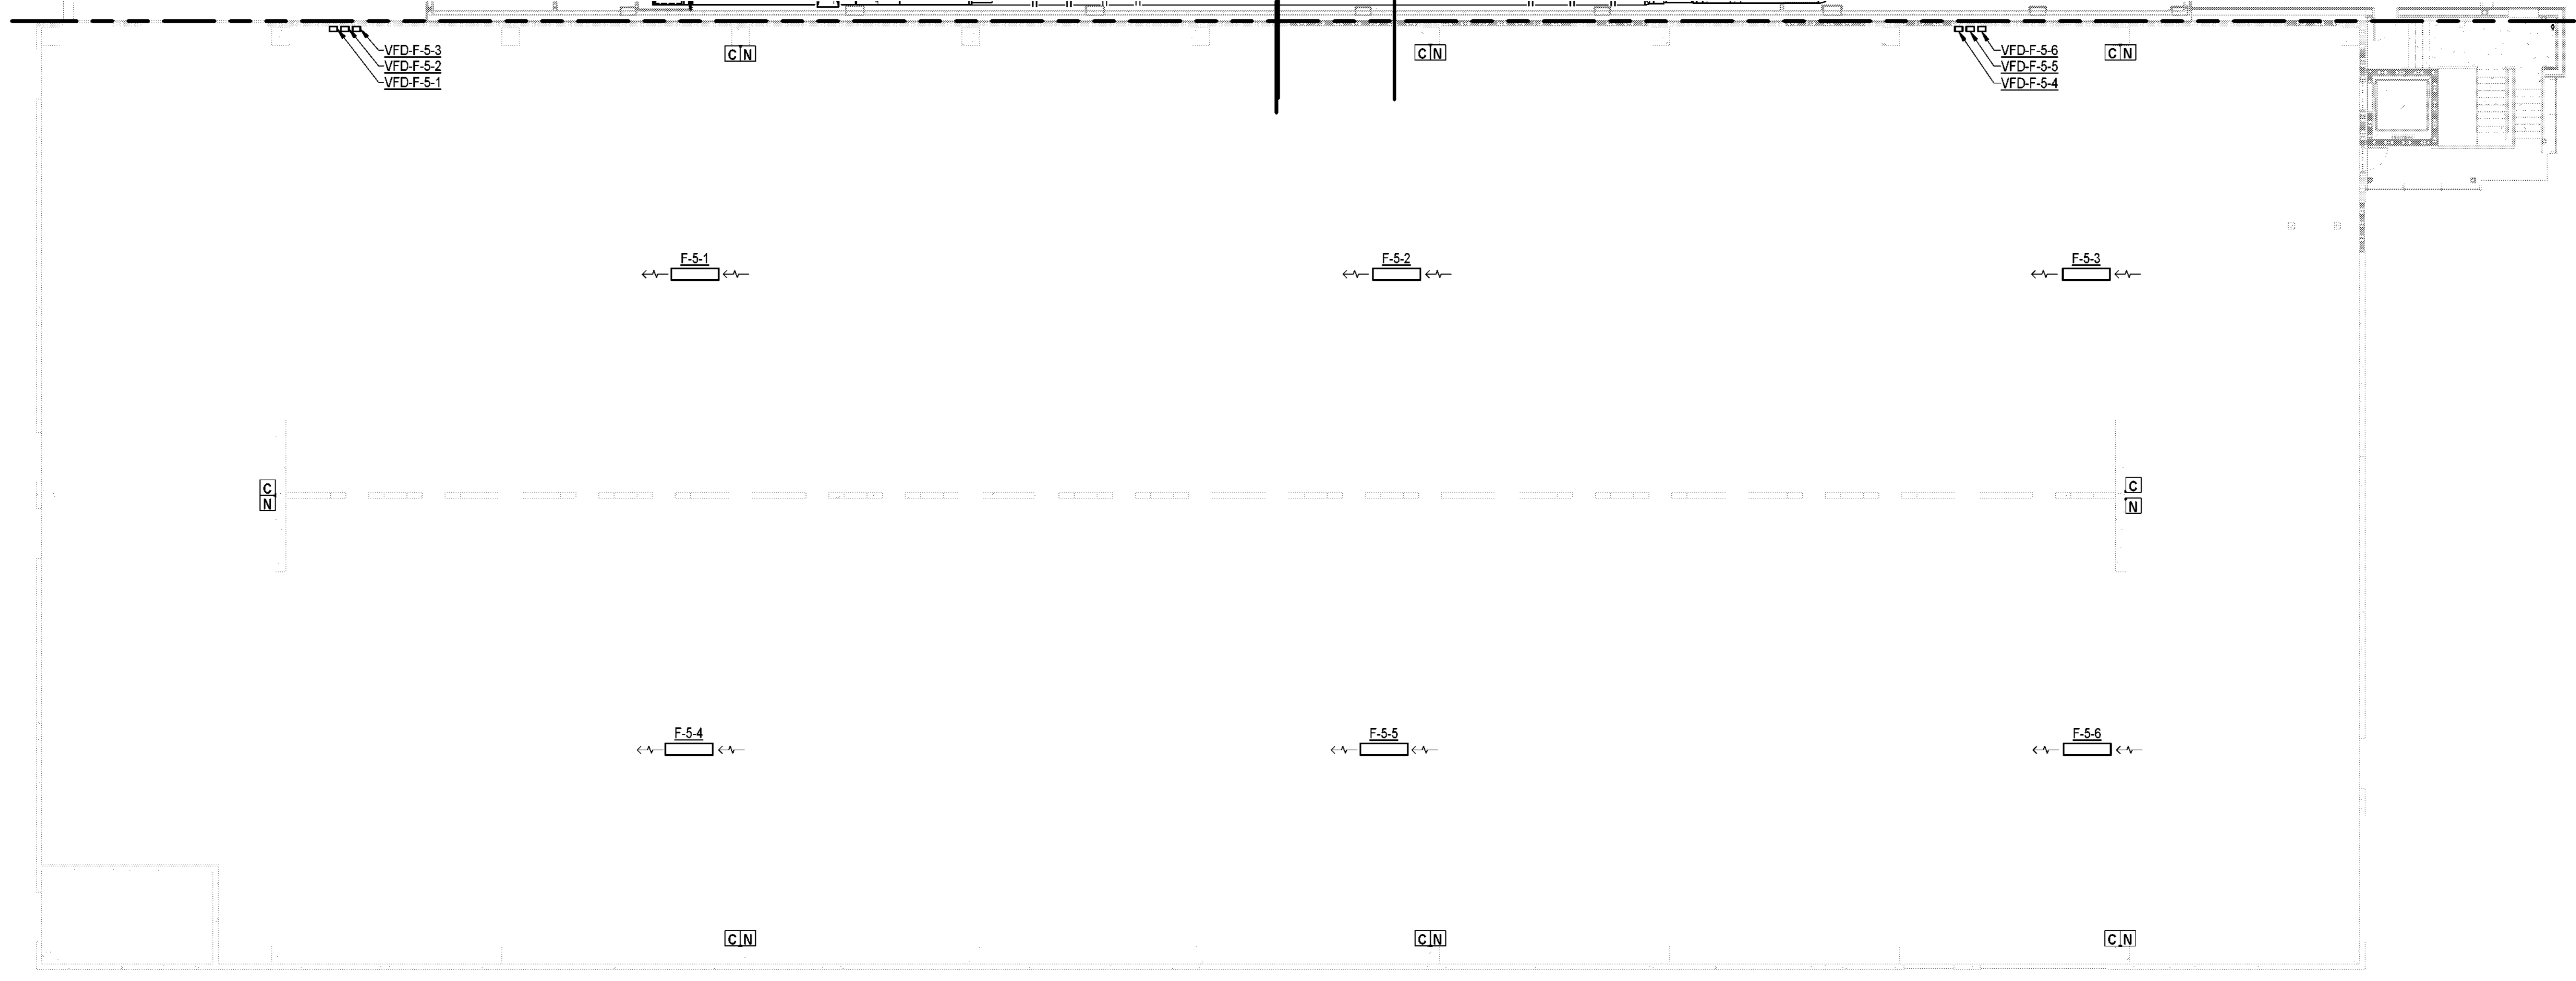
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**1 HVAC PARKING DECK LEVEL 5**  
3/32" = 1'-0"

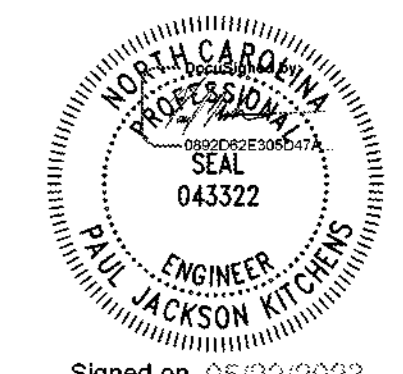


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SHEET NAME:  
HVAC PARKING  
DECK LEVEL 5

ORIG SUBMISSION: 2023.05.22

SHEET: **M-109**

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THE LITTLE ENGINEER'S QUALITY CONTROL PROGRAM

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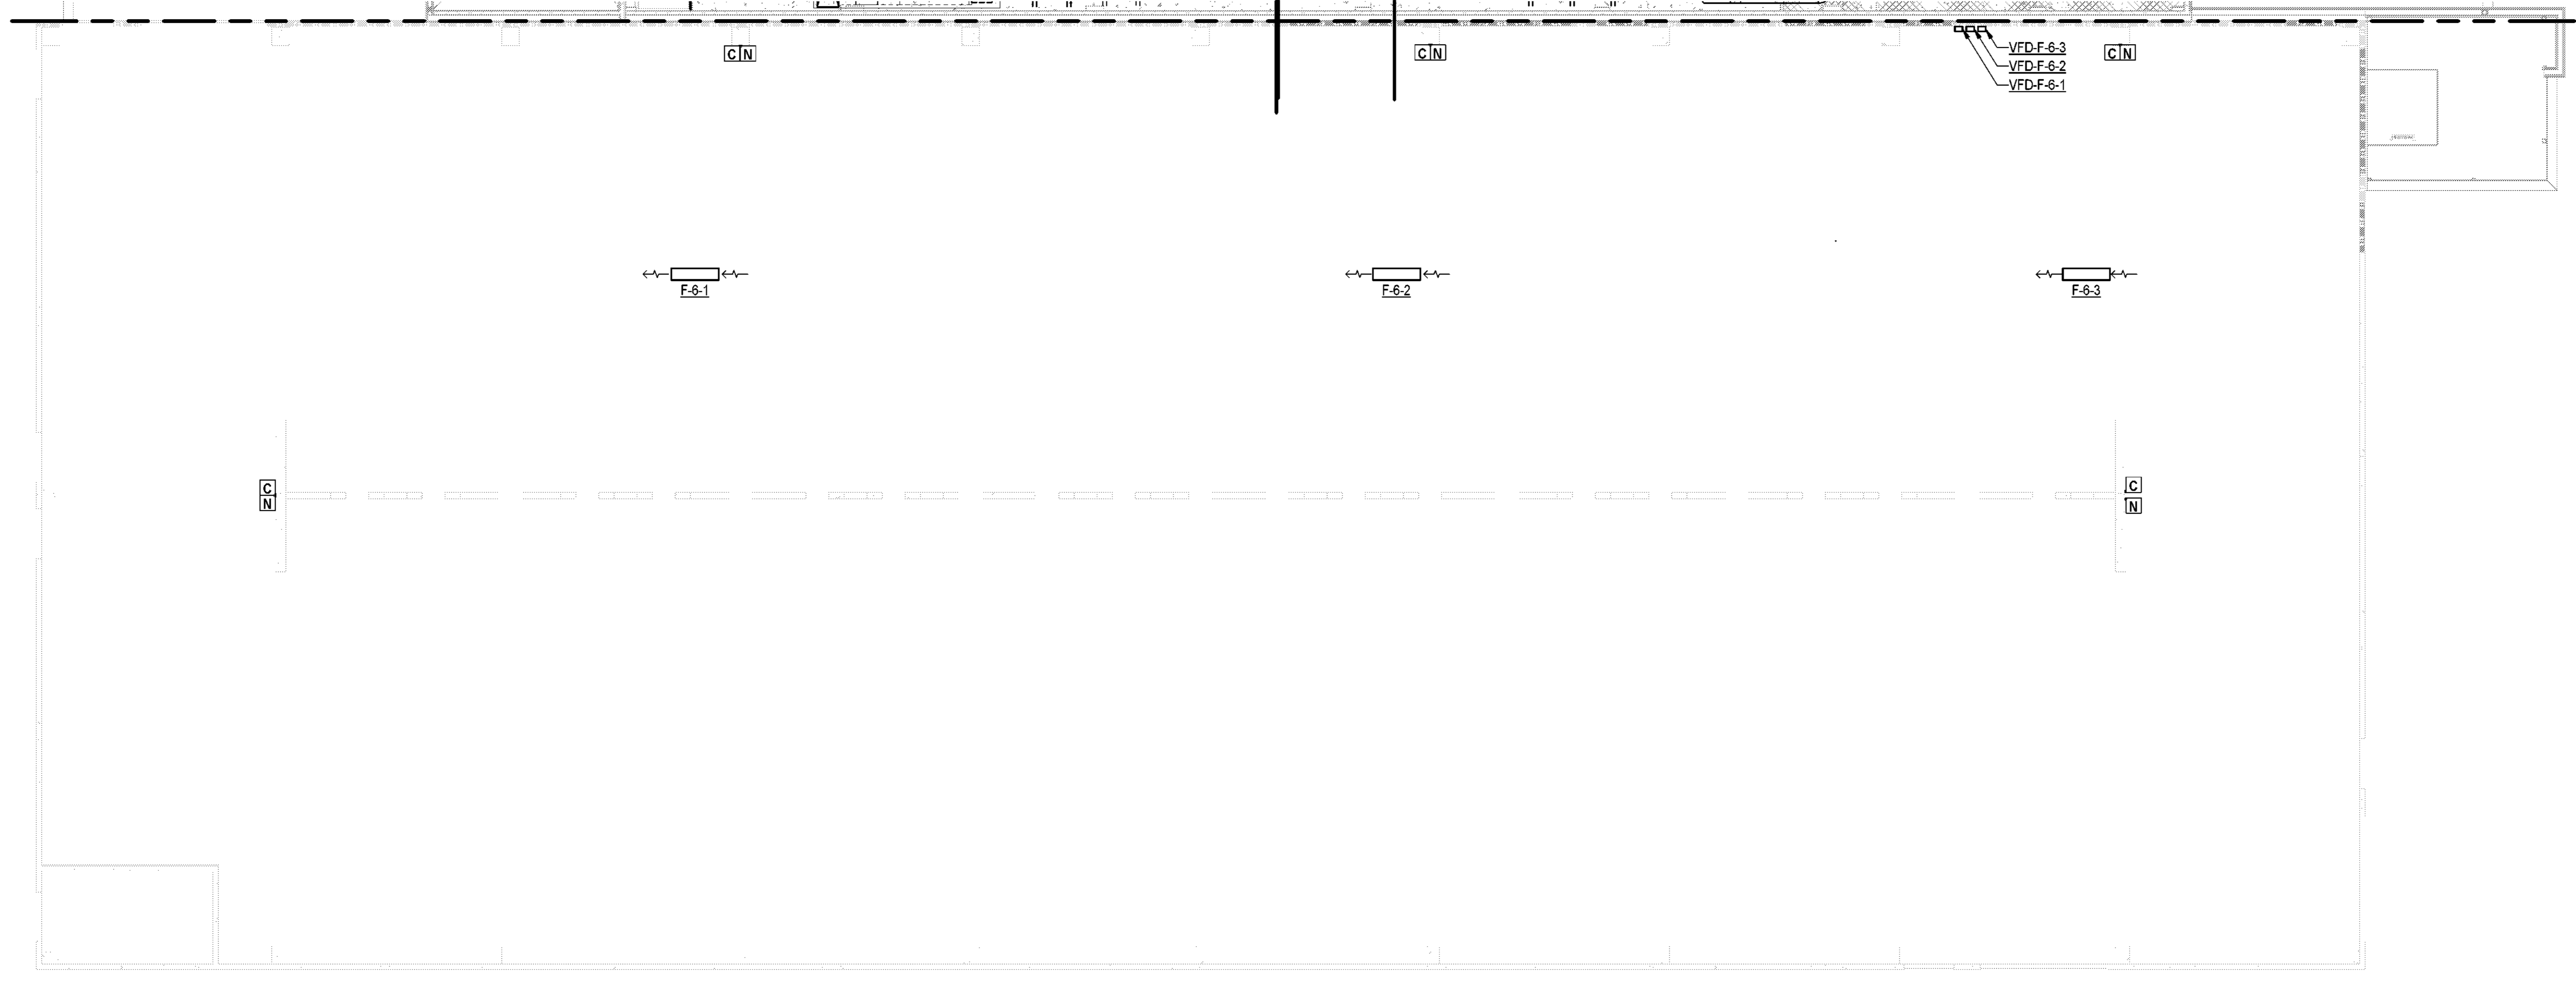
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**1 HVAC PARKING DECK LEVEL 6**  
3/32" = 1'-0"

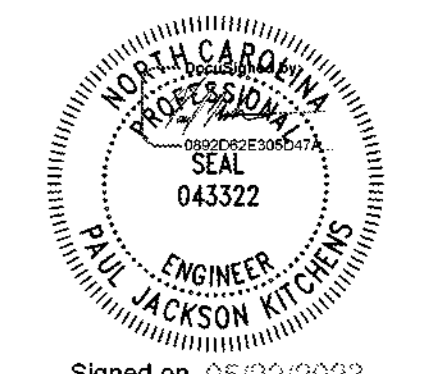


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SHEET NAME:  
**HVAC PARKING  
DECK LEVEL 6**

ORIG SUBMISSION: 2023.05.22

SHEET:  
**M-110**

PERMIT SET

THEME: GROUNDWATER & QUALITY  
 DATE: 05/22/2023 10:15:46 AM
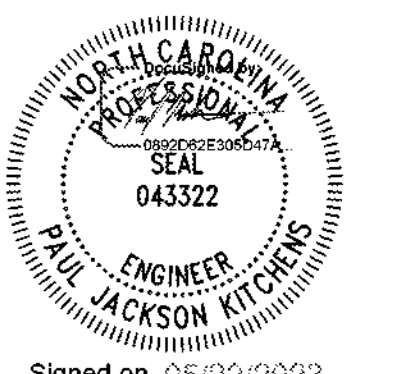
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**KEY NOTES:**

- ROUTE CONDENSATE TO FLOOR DRAIN IN MAIN MECH. ROOM (C108).

**ADDITIONAL ALTERNATE**

- SCOPE ASSOCIATED WITH PARKING DECK ACCESS DOOR. A. PIPING SHALL SHIFT TO BE HOUSED WITHIN ALTERNATE SHAFT LOCATION. ADJACENT SYSTEMS SHALL SHIFT TO ACCOMMODATE THE ALTERNATE SHAFT LOCATION. REFER TO ARCHITECTURAL DRAWINGS FOR MORE INFORMATION.




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 LSSP PROJECT: 7701-177800

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1 HVAC PIPING LEVEL 1 - AREA A  
 1/8" = 1'-0"

SHEET NAME:  
 HVAC PIPING  
 LEVEL 1 - AREA A

ORIG SUBMISSION: 2023.05.22

SHEET:  
**M-201A**

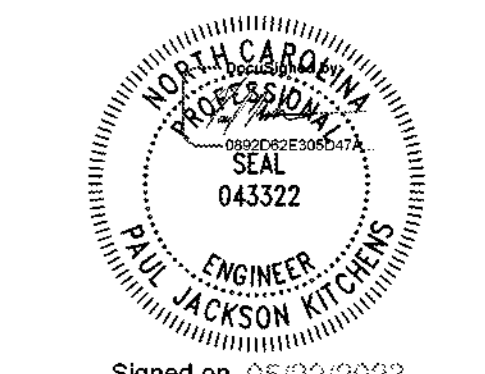PERMIT SET

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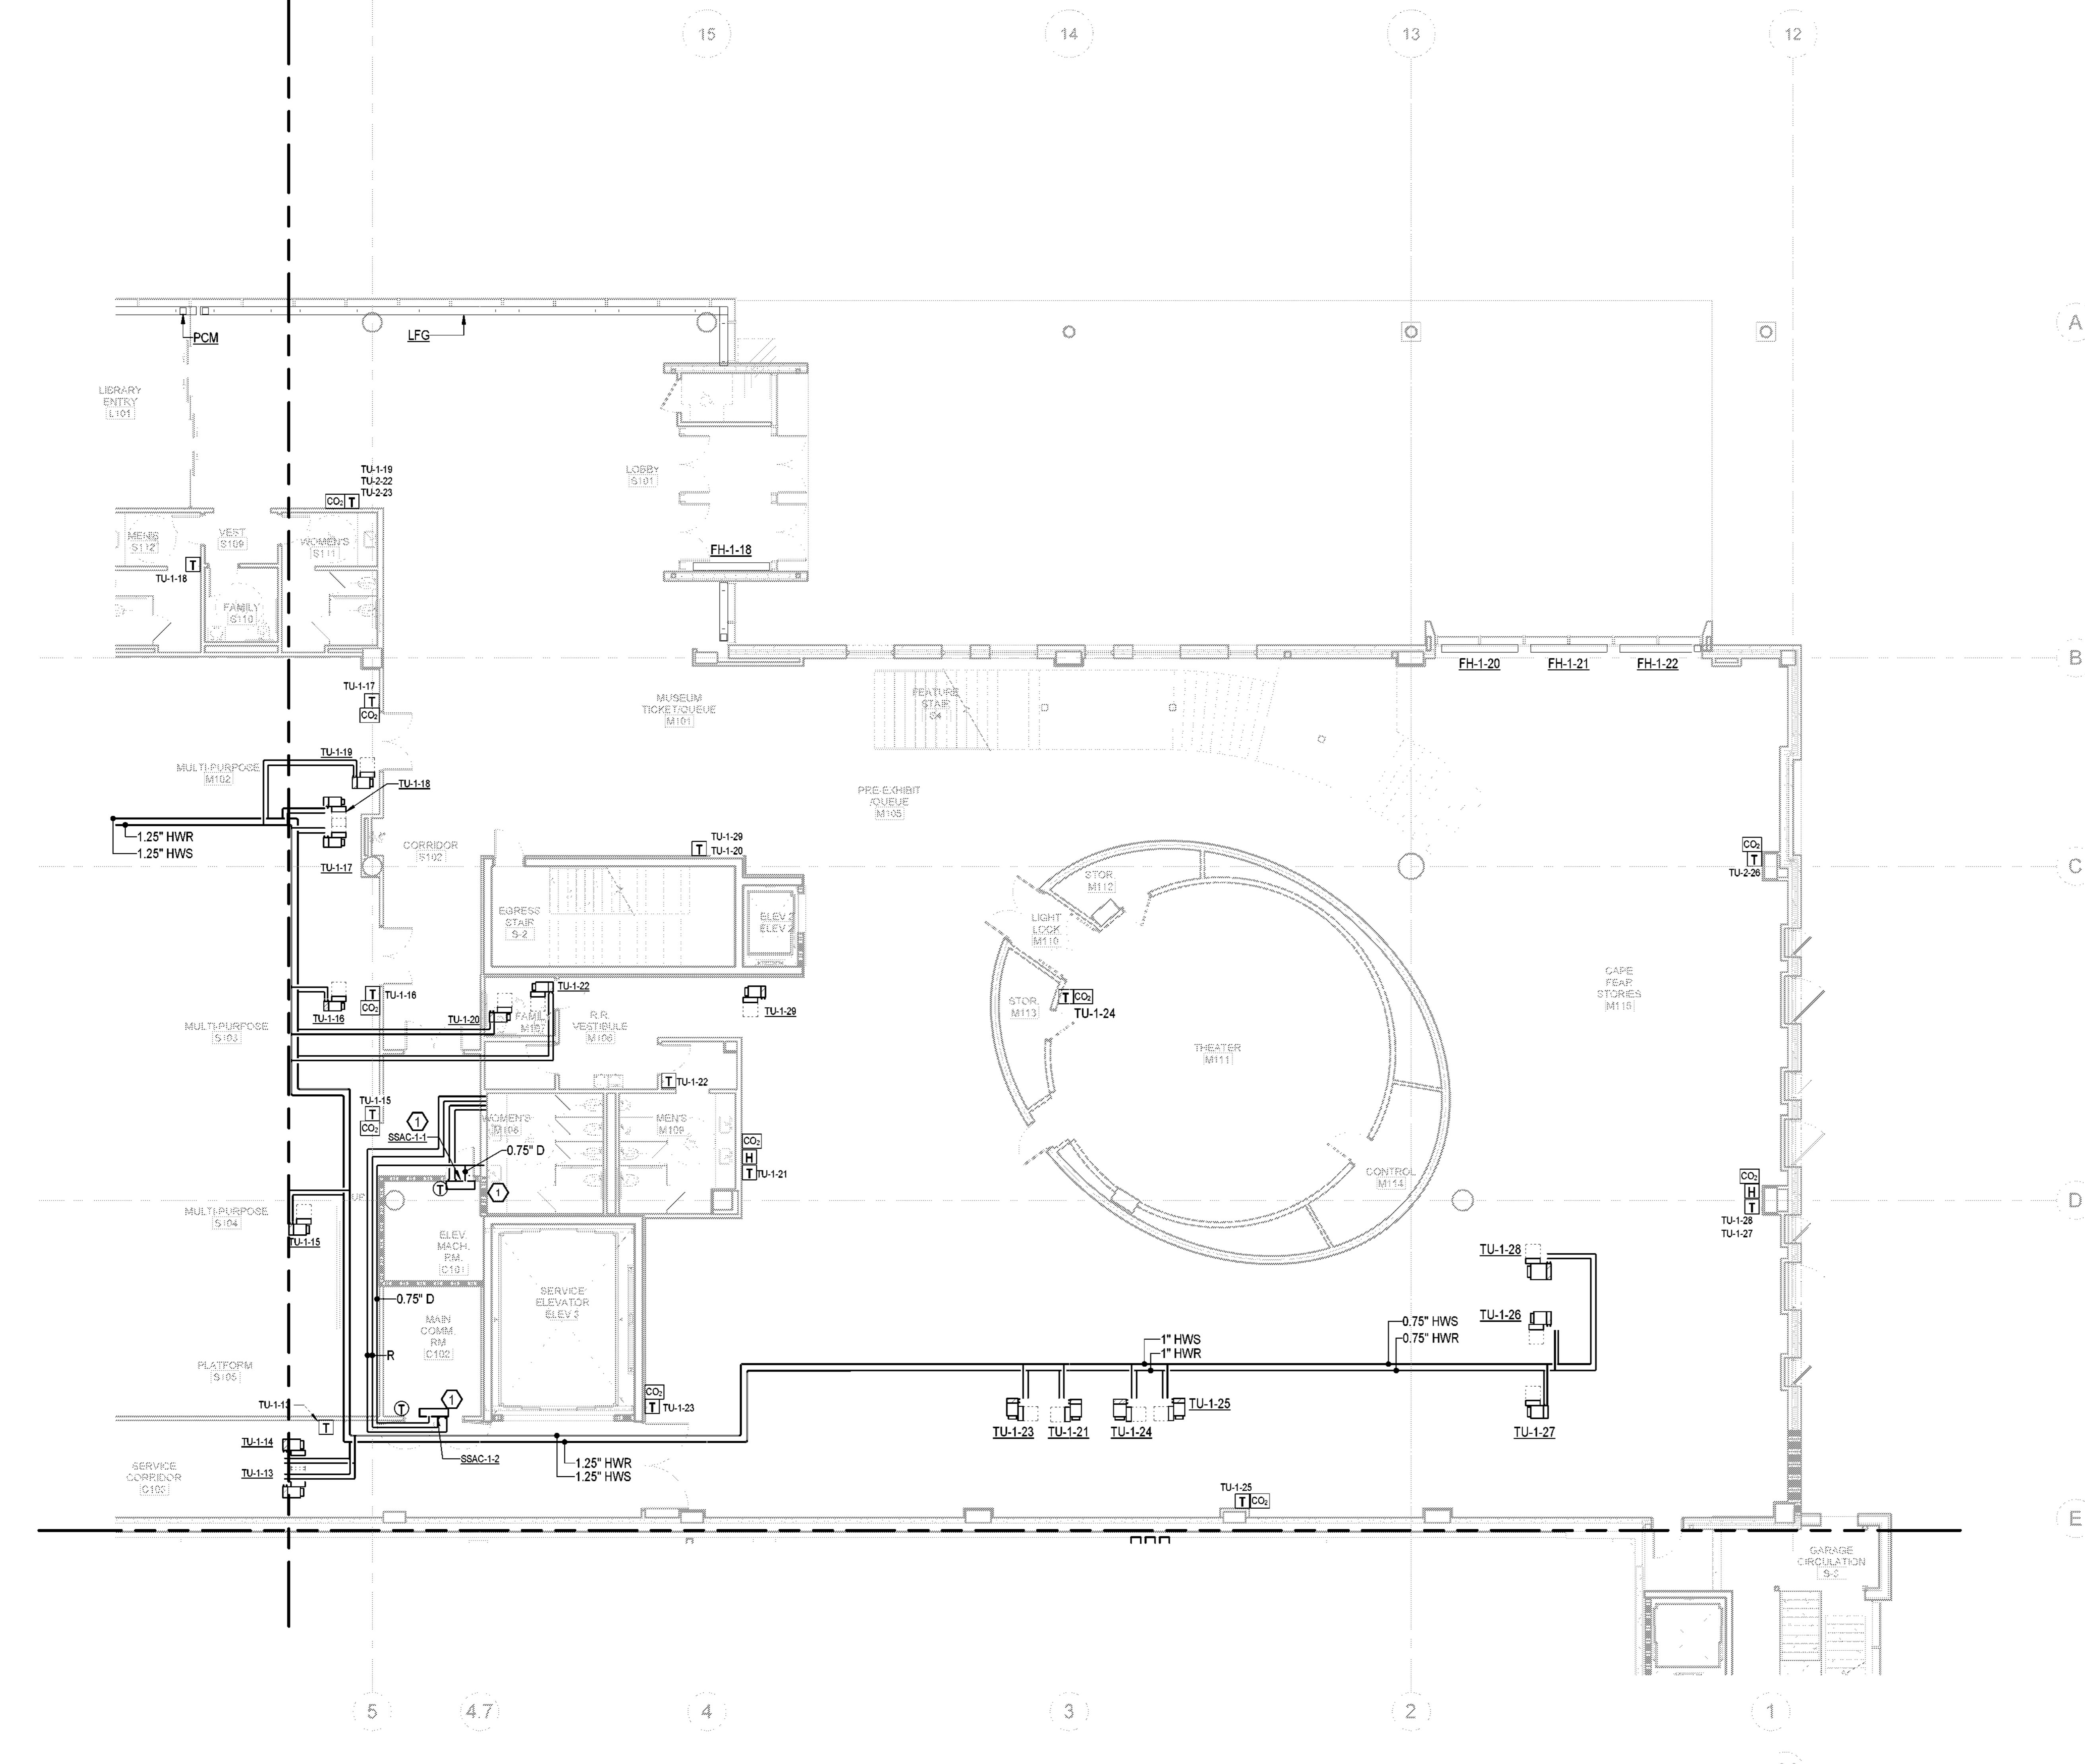
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1 HVAC PIPING LEVEL 1 - AREA B  
1/8" = 1'-0"

GENERAL NOTES:

- 1. EXPOSED PIPING AND ALL ASSOCIATED APPURTENANCES, INCLUDING EQUIPMENT SHALL BE PAINTED BLACK TO MATCH THE CEILING. REFER TO ARCHITECTURAL PLANS AND SPECIFICATIONS FOR MORE INFORMATION.

KEY NOTES:

- 1. CONDENSATE DRAIN PIPING TO TIE INTO SINK TAILPIECE.




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LS3P PROJECT: 7701-177800


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SHEET NAME:  
HVAC PIPING  
LEVEL 1 - AREA B

ORIG SUBMISSION: 2023.05.22

SHEET:  
M-201B

PERMIT SET

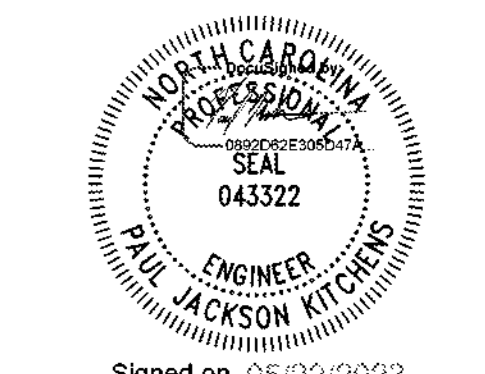

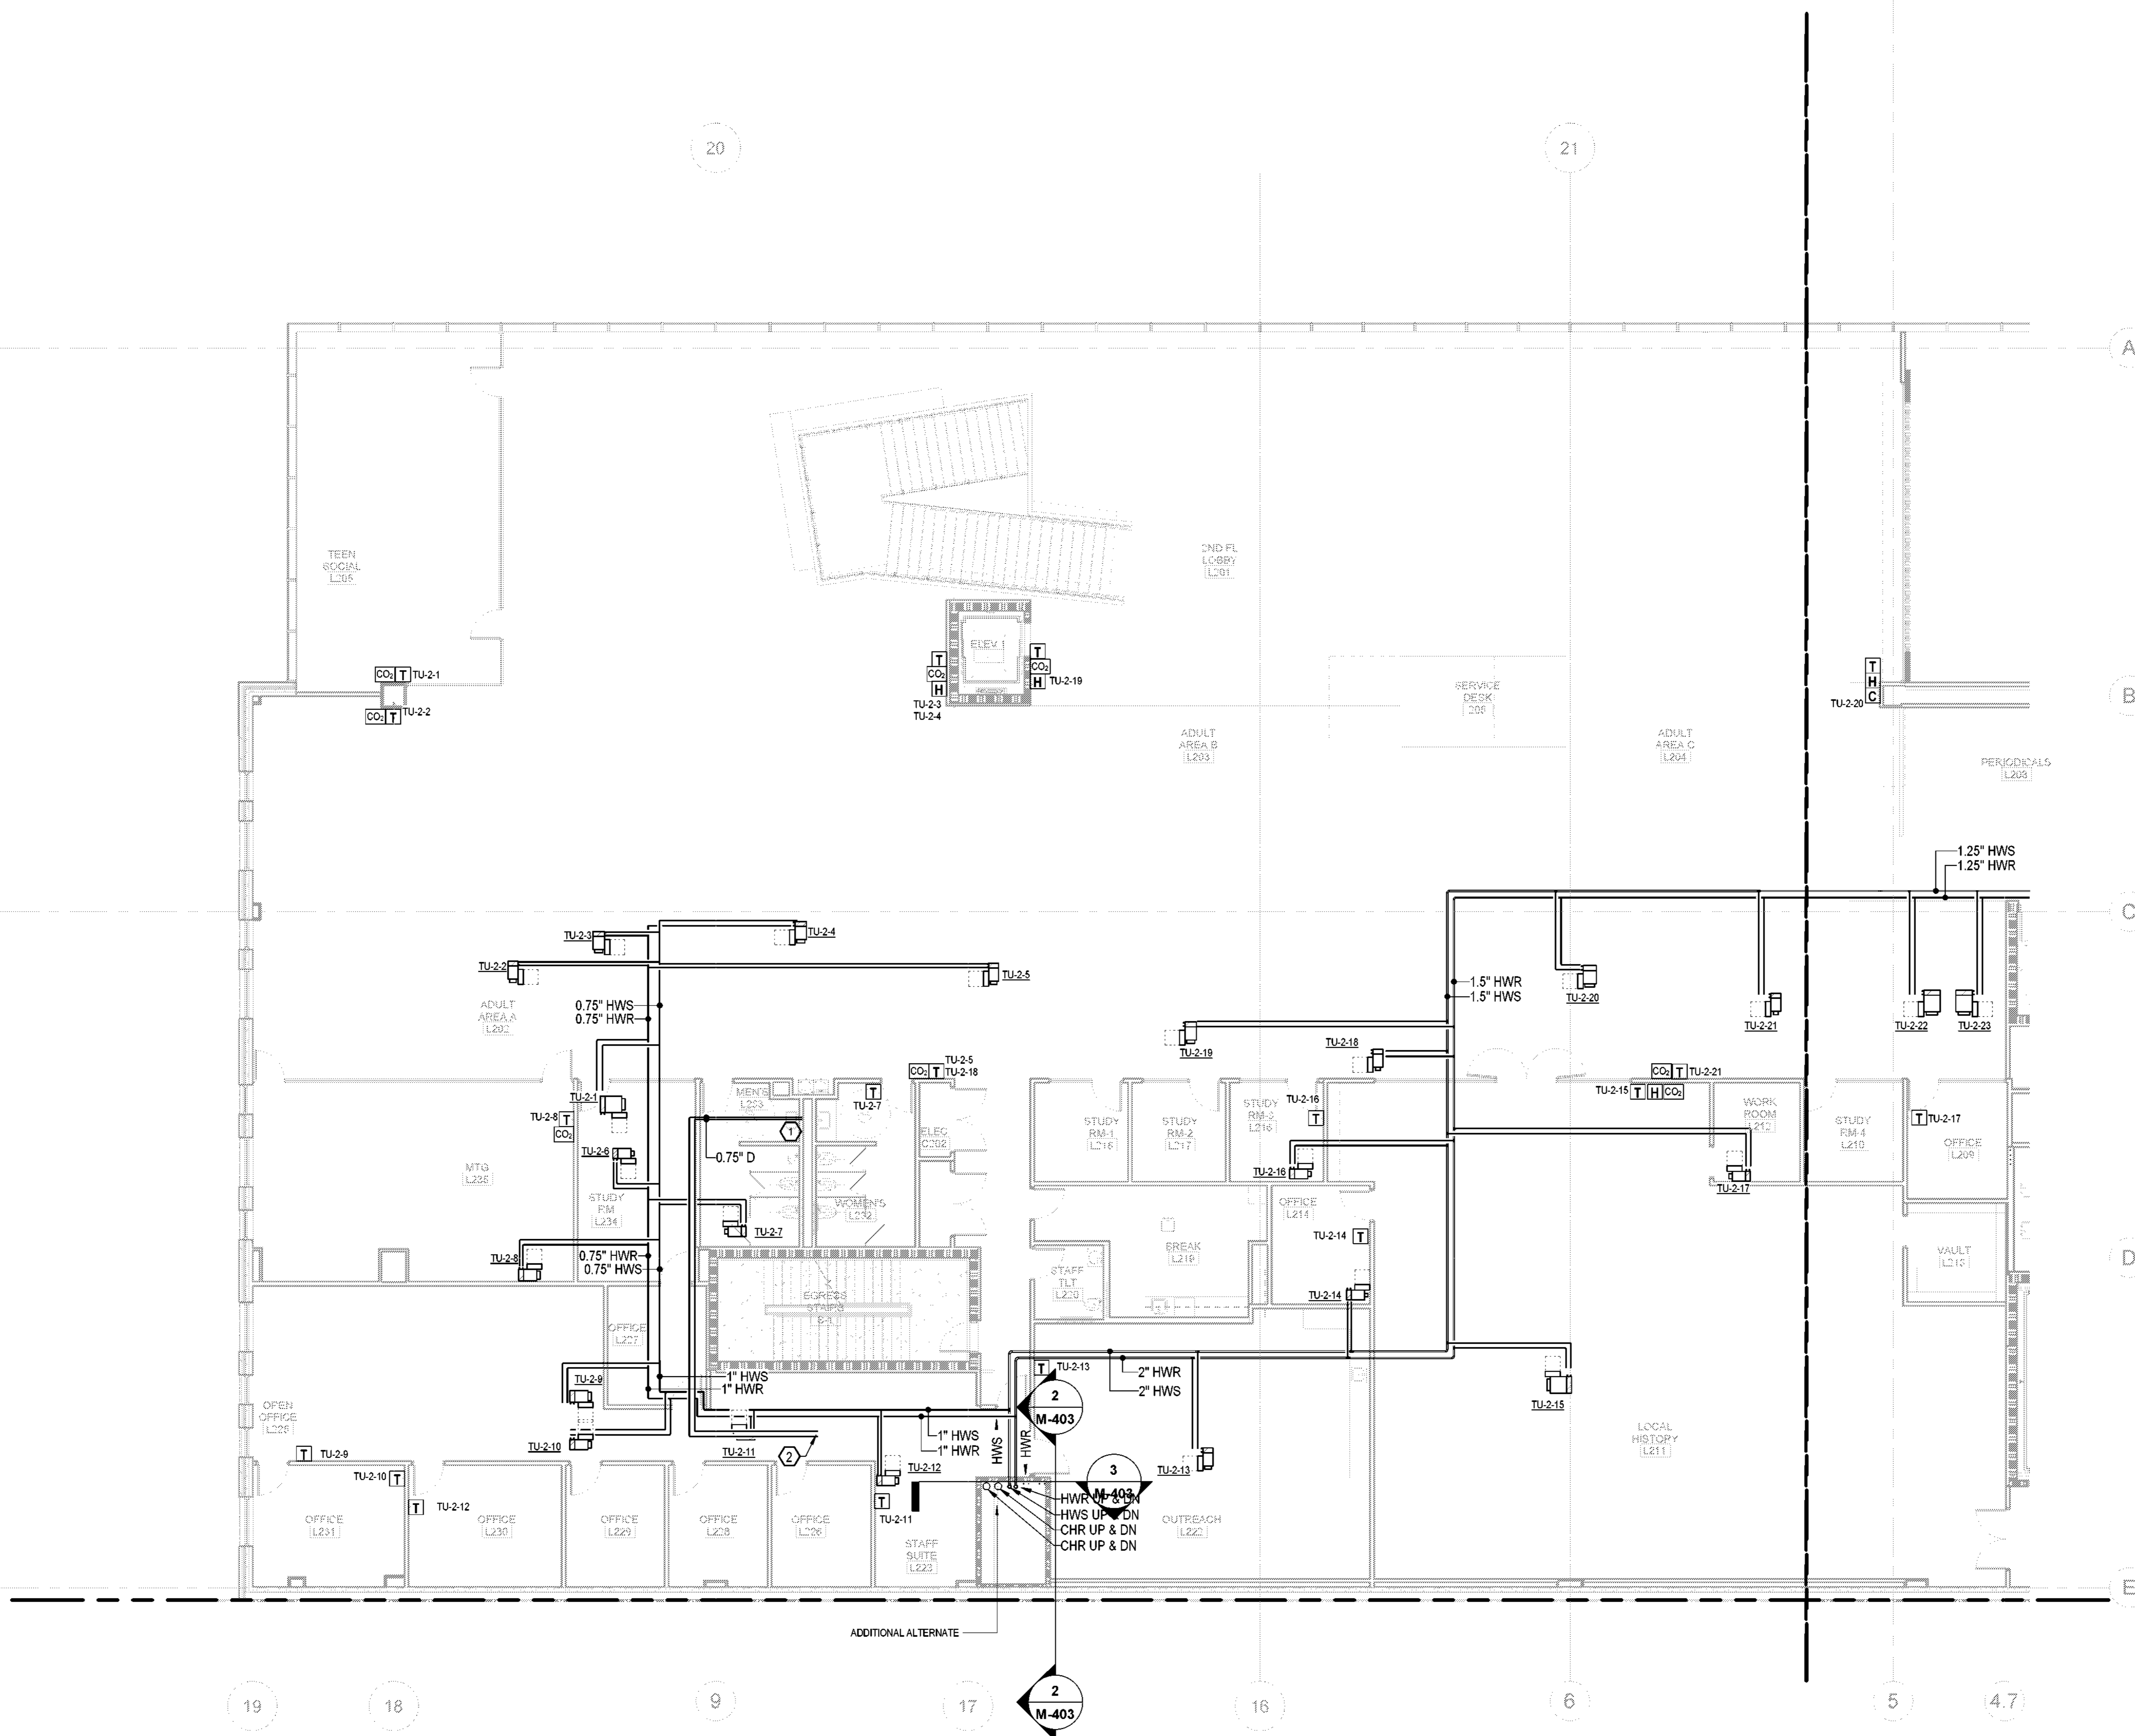**KEY NOTES:**

- CONDENSATE DRAINS TO TIE IN TO TAILPIECE OF SINK.
- CONDENSATE DRAIN PIPING FROM ABOVE.

**ADDITIONAL ALTERNATE**

- SCOPE ASSOCIATED WITH PARKING DECK ACCESS DOOR.  
A. PIPING SHALL SHIFT TO BE HOUSED WITHIN ALTERNATE SHAFT LOCATION. ADJACENT SYSTEMS SHALL SHIFT TO ACCOMMODATE THE ALTERNATE SHAFT LOCATION. REFER TO ARCHITECTURAL DRAWINGS FOR MORE INFORMATION.




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SHEET NAME:  
**HVAC PIPING  
LEVEL 2 - AREA A**

ORIG SUBMISSION: 2023.05.22

SHEET:  
**M-202A**

**1 HVAC PIPING LEVEL 2 - AREA A**  
1/8" = 1'-0"

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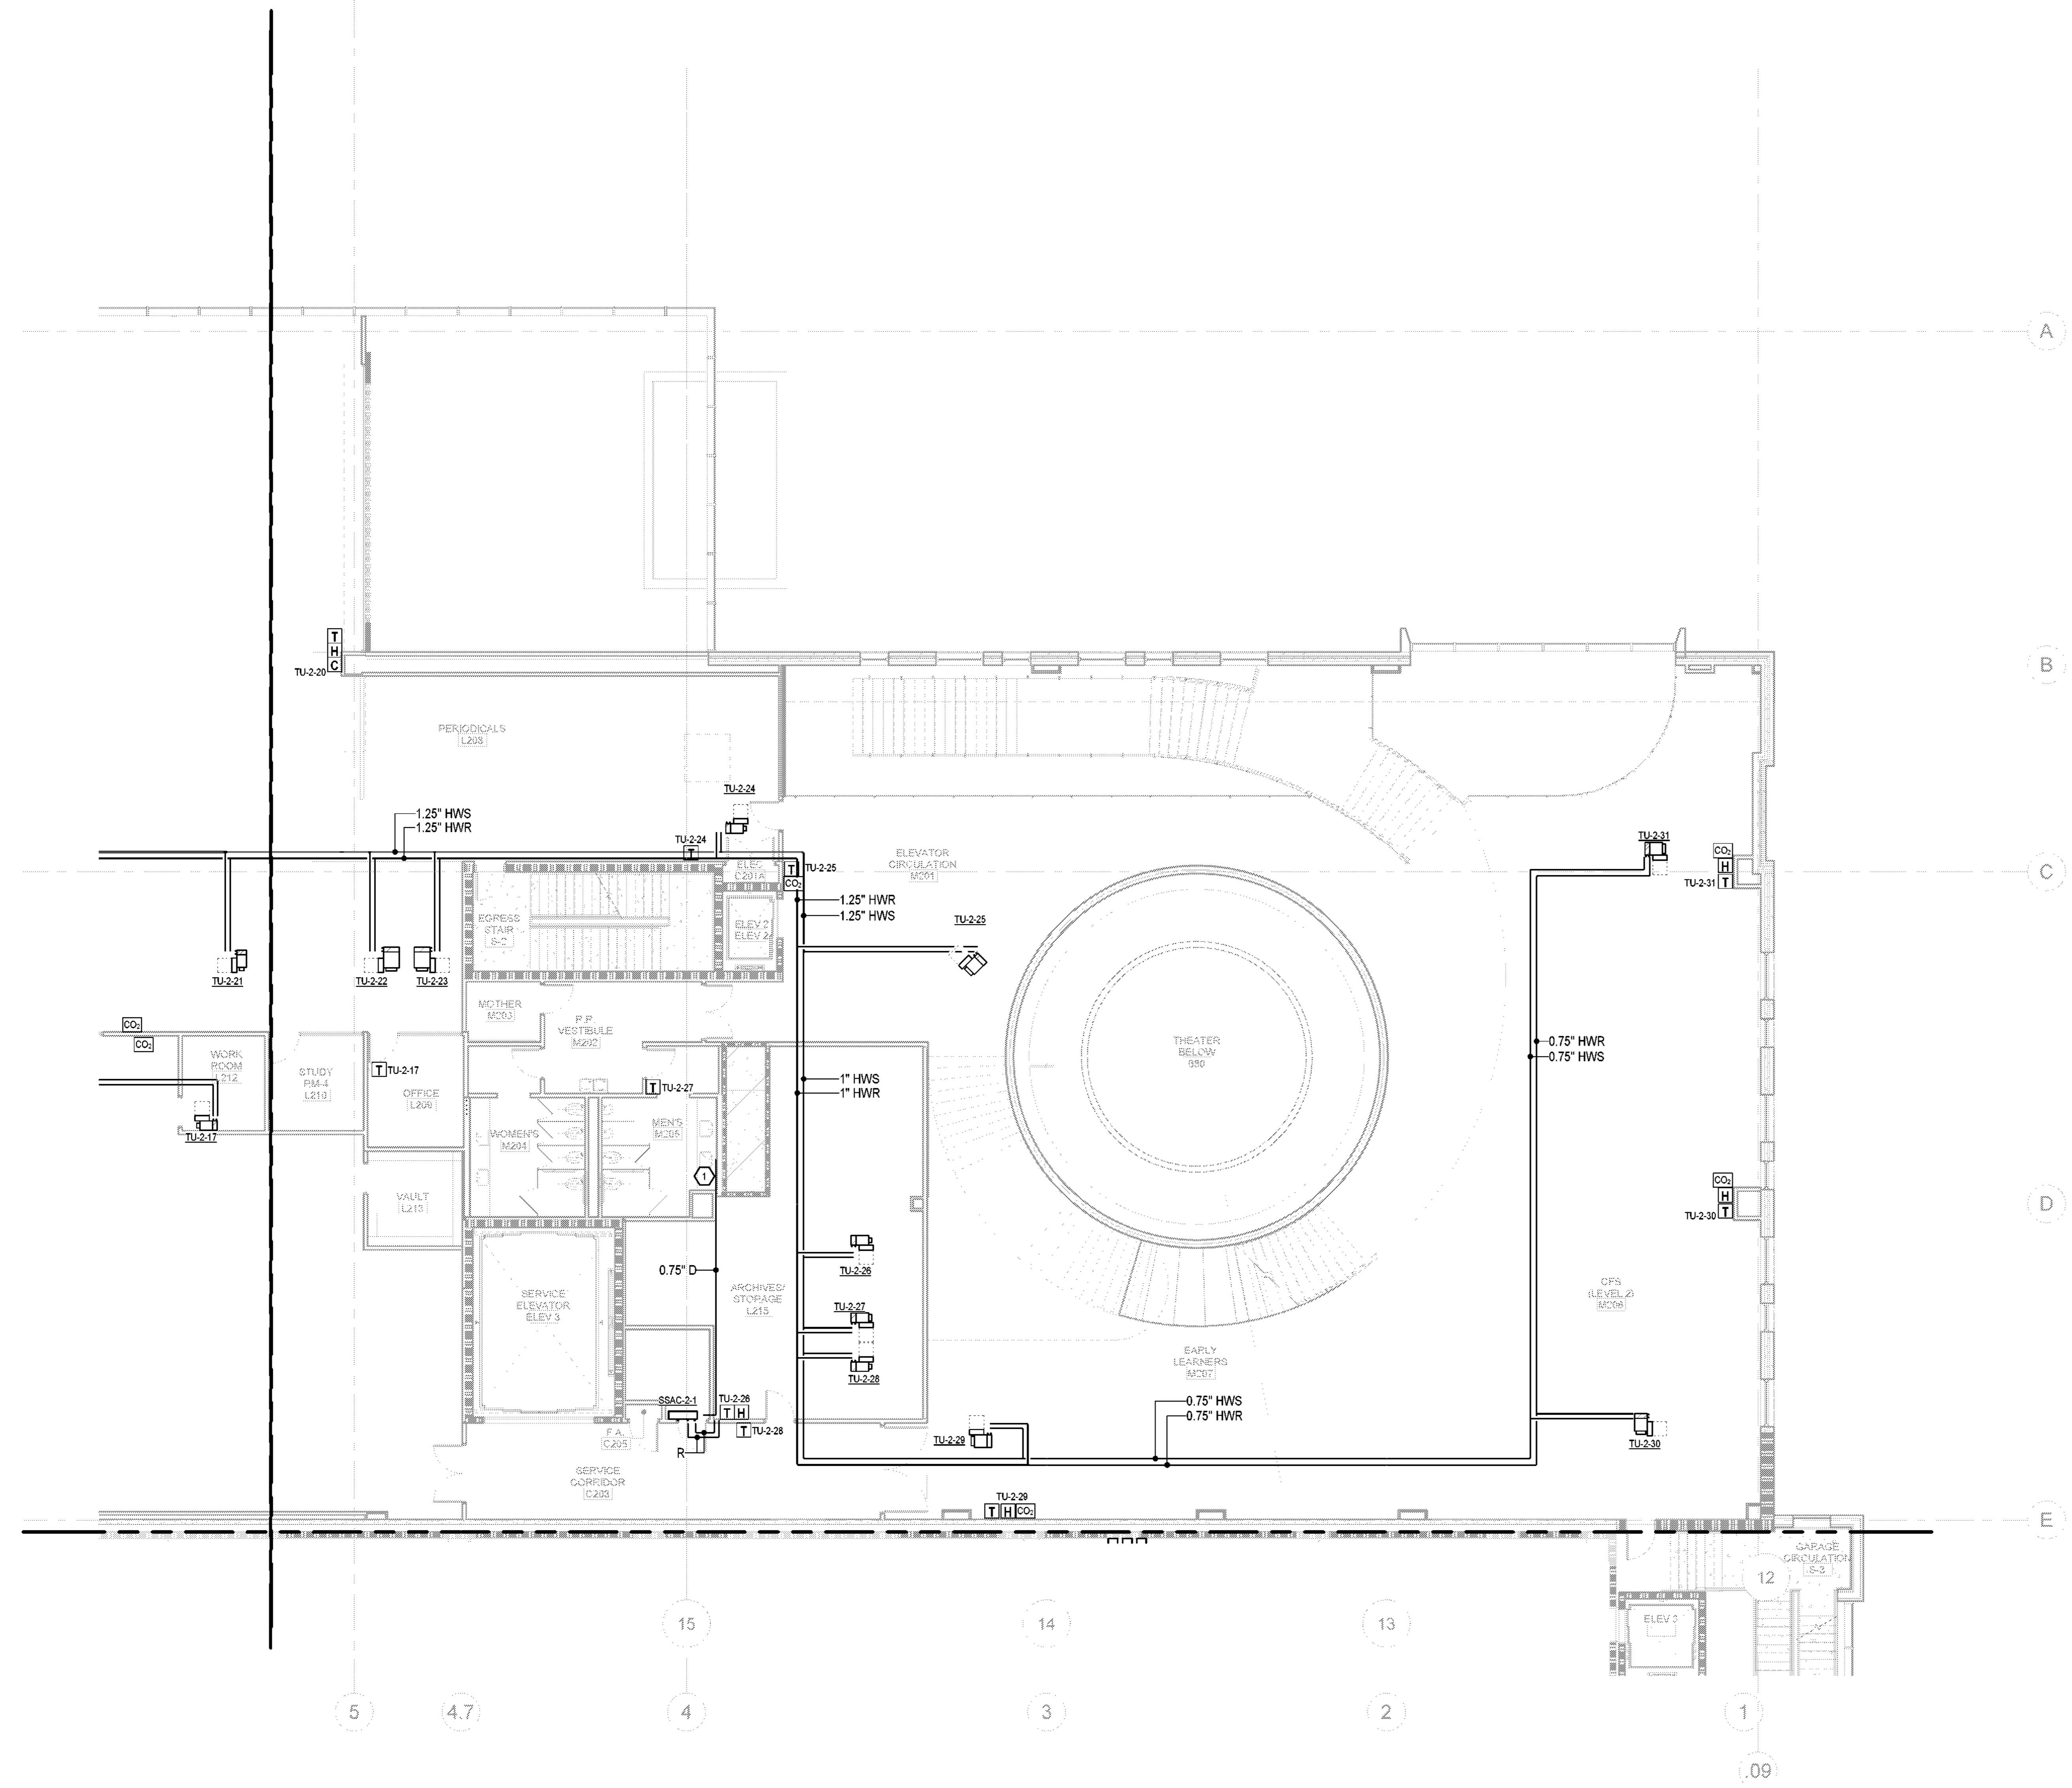
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**GENERAL NOTES:**

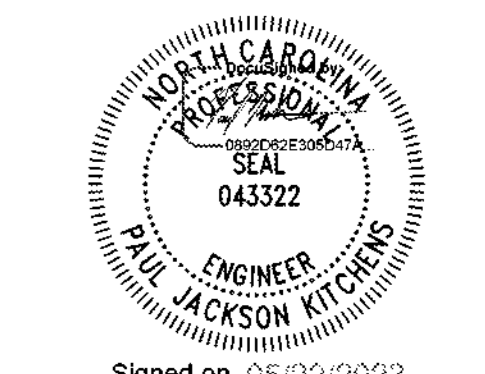- EXPOSED PIPING AND ALL ASSOCIATED APPURTENANCES, INCLUDING EQUIPMENT SHALL BE PAINTED BLACK TO MATCH THE CEILING. REFER TO ARCHITECTURAL PLANS AND SPECIFICATIONS FOR MORE INFORMATION.

**KEY NOTES:**

- CONDENSATE DRAIN PIPING TO TIE INTO SINK TAILPIECE




**CFD**  
Cape Fear Development

**LS3P**

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WILMINGTON, NORTH CAROLINA 28401  
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**NEWCOMB & BOYD**

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T 919.783.7812  
NB Contact: Brandon R. Nevin  
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**Project Grace**

Grace Street  
Wilmington, NC 28401  
LS3P PROJECT: 7701-177800
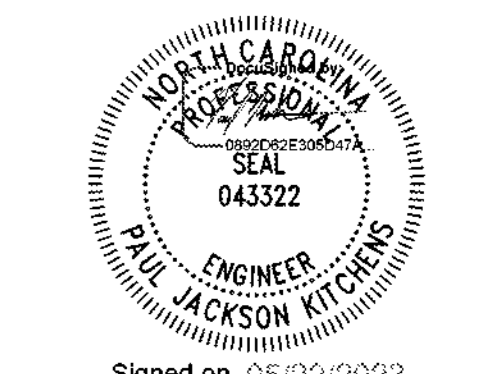
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**1 HVAC PIPING LEVEL 2 - AREA B**  
1/8" = 1'-0"

SHEET NAME:  
HVAC PIPING  
LEVEL 2 - AREA B

ORIG SUBMISSION: 2023.05.22

SHEET:  
**M-202B**

PERMIT SET






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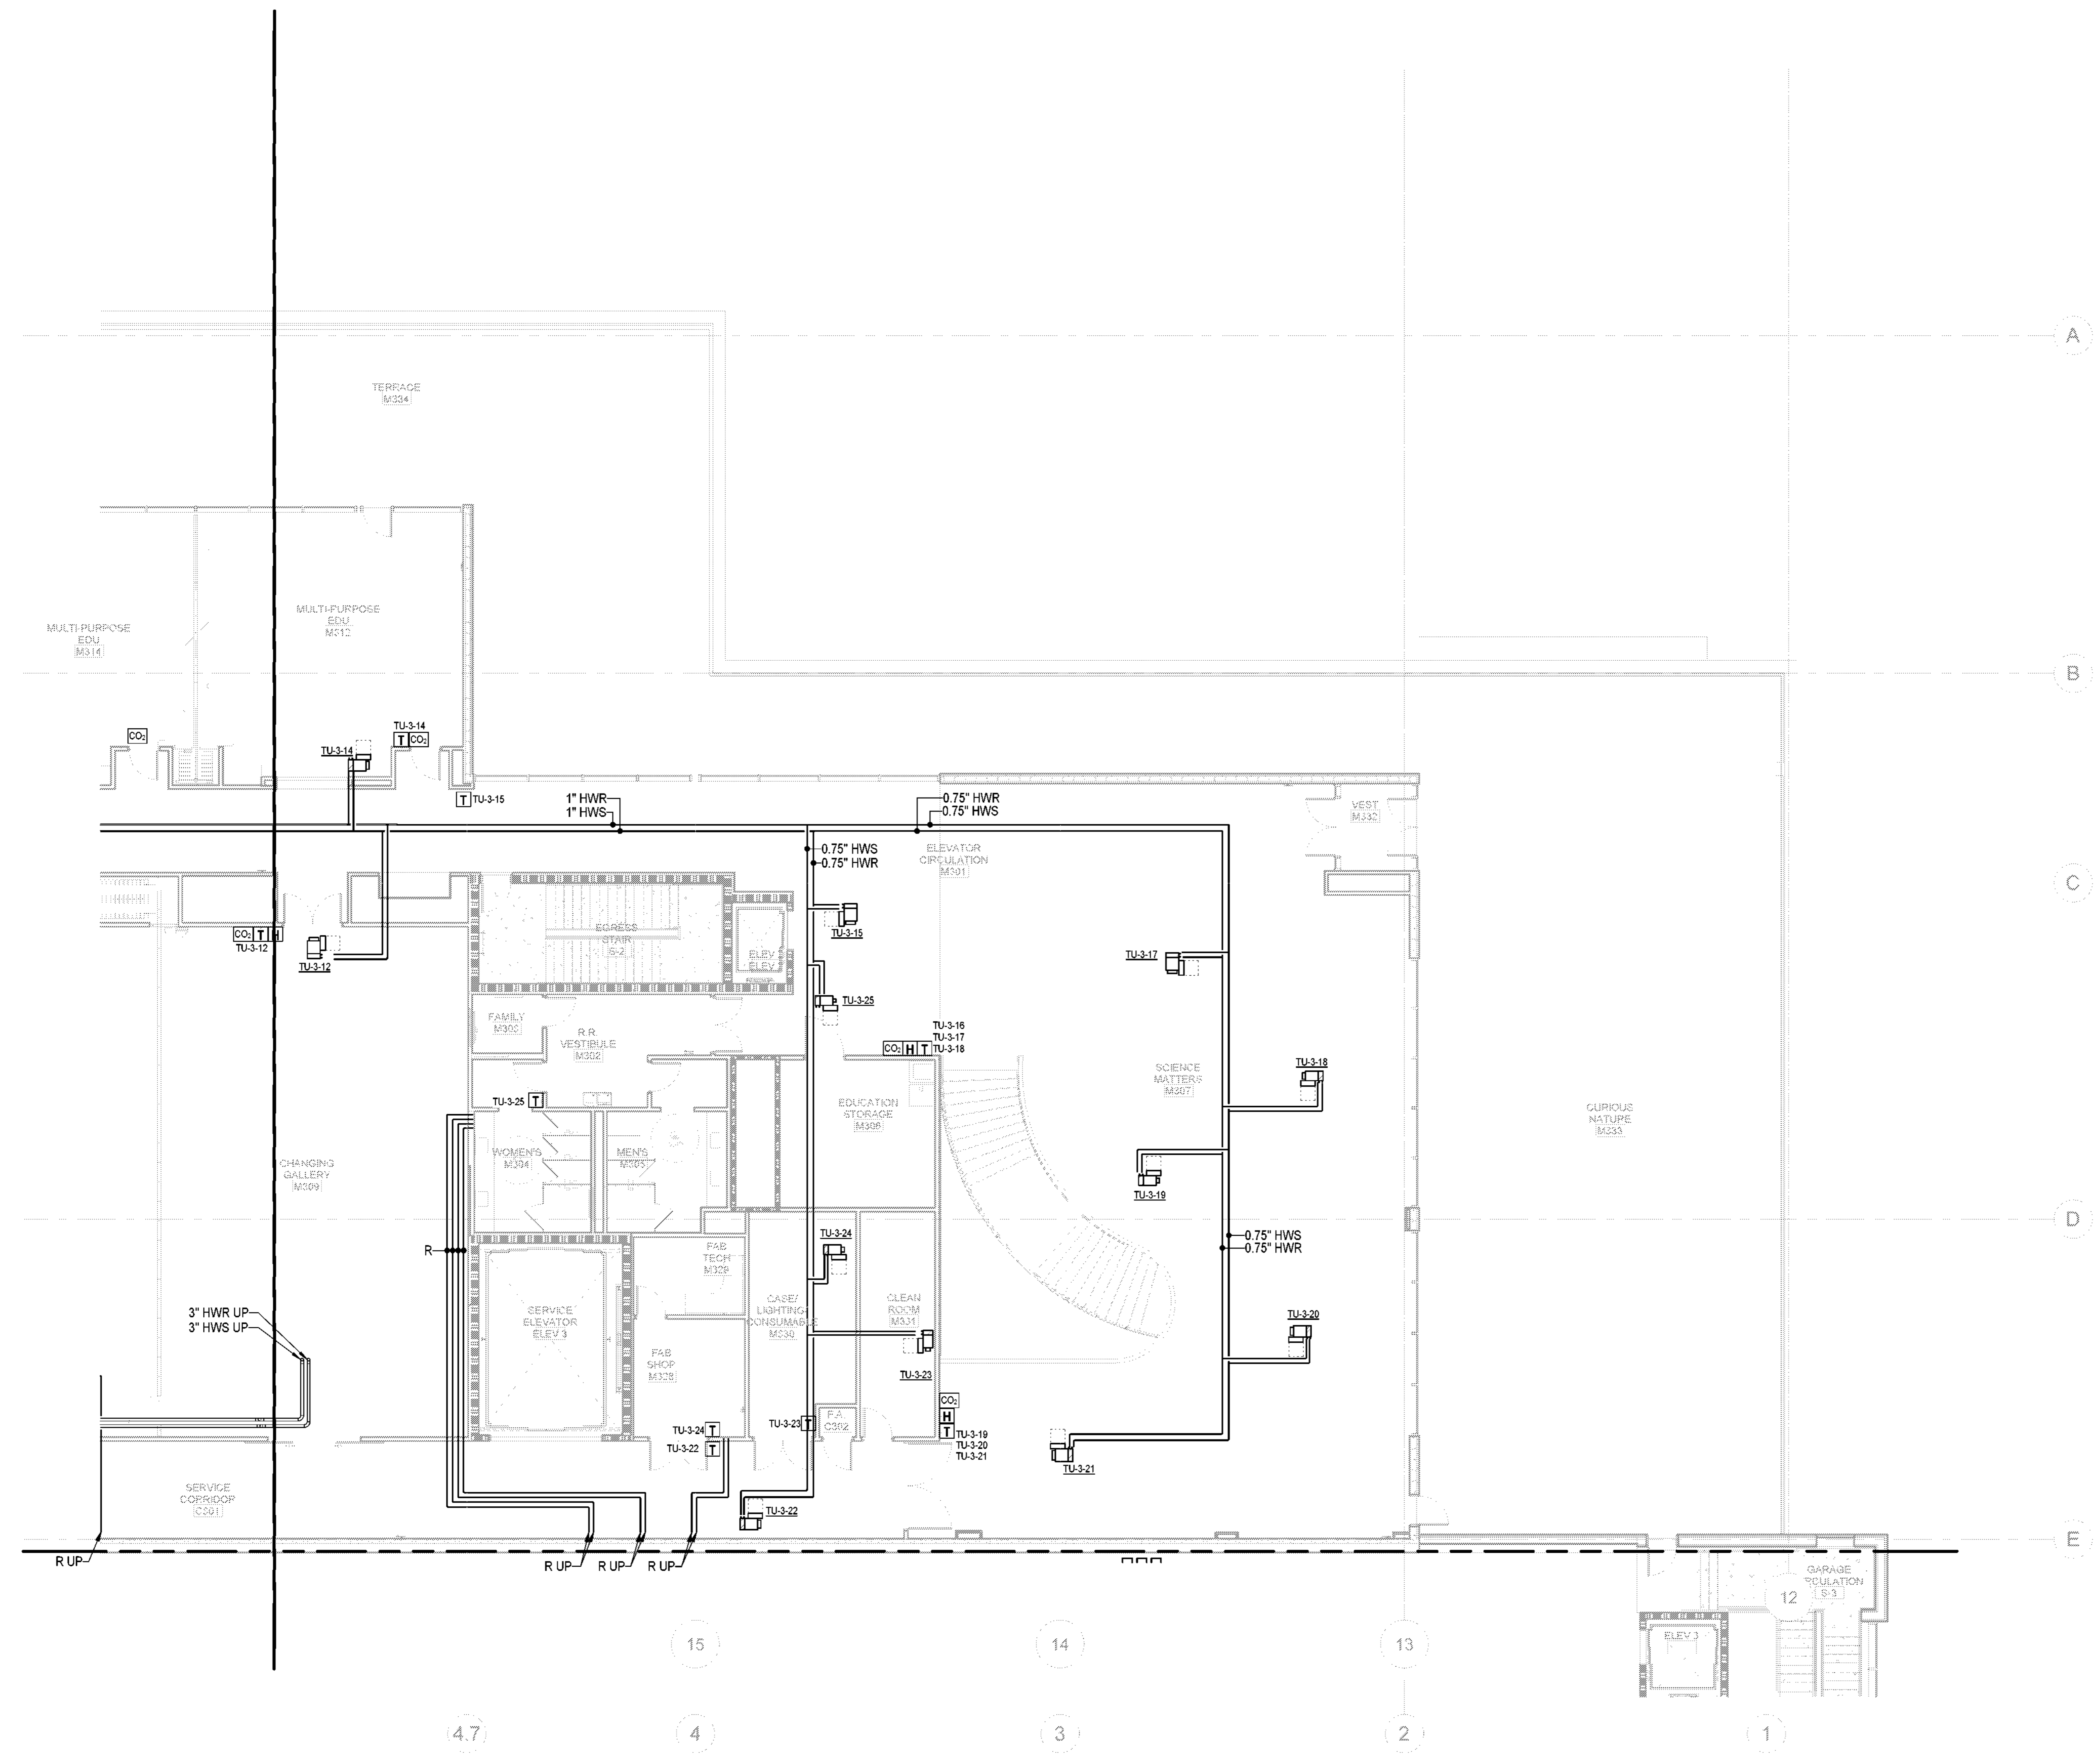
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**GENERAL NOTES:**

- 1. EXPOSED PIPING AND ALL ASSOCIATED APPURTENANCES, INCLUDING EQUIPMENT SHALL BE PAINTED BLACK TO MATCH THE CEILING. REFER TO ARCHITECTURAL PLANS AND SPECIFICATIONS FOR MORE INFORMATION.



**Project Grace**

Grace Street  
Wilmington, NC 28401

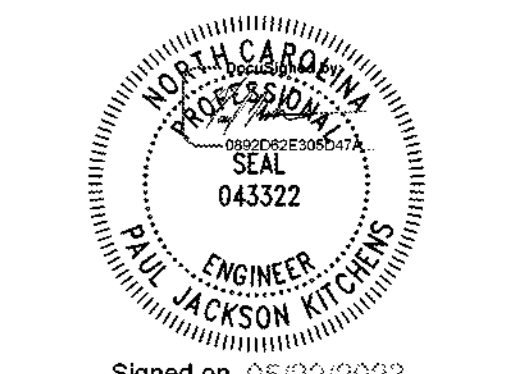LS3P PROJECT: 7701-177800

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SHEET NAME:  
HVAC PIPING  
LEVEL 3 - AREA B

ORIG SUBMISSION: 2023.05.22

SHEET:  
**M-203B**

PERMIT SET

**1 HVAC PIPING LEVEL 3 - AREA B**  
1/8" = 1'-0"




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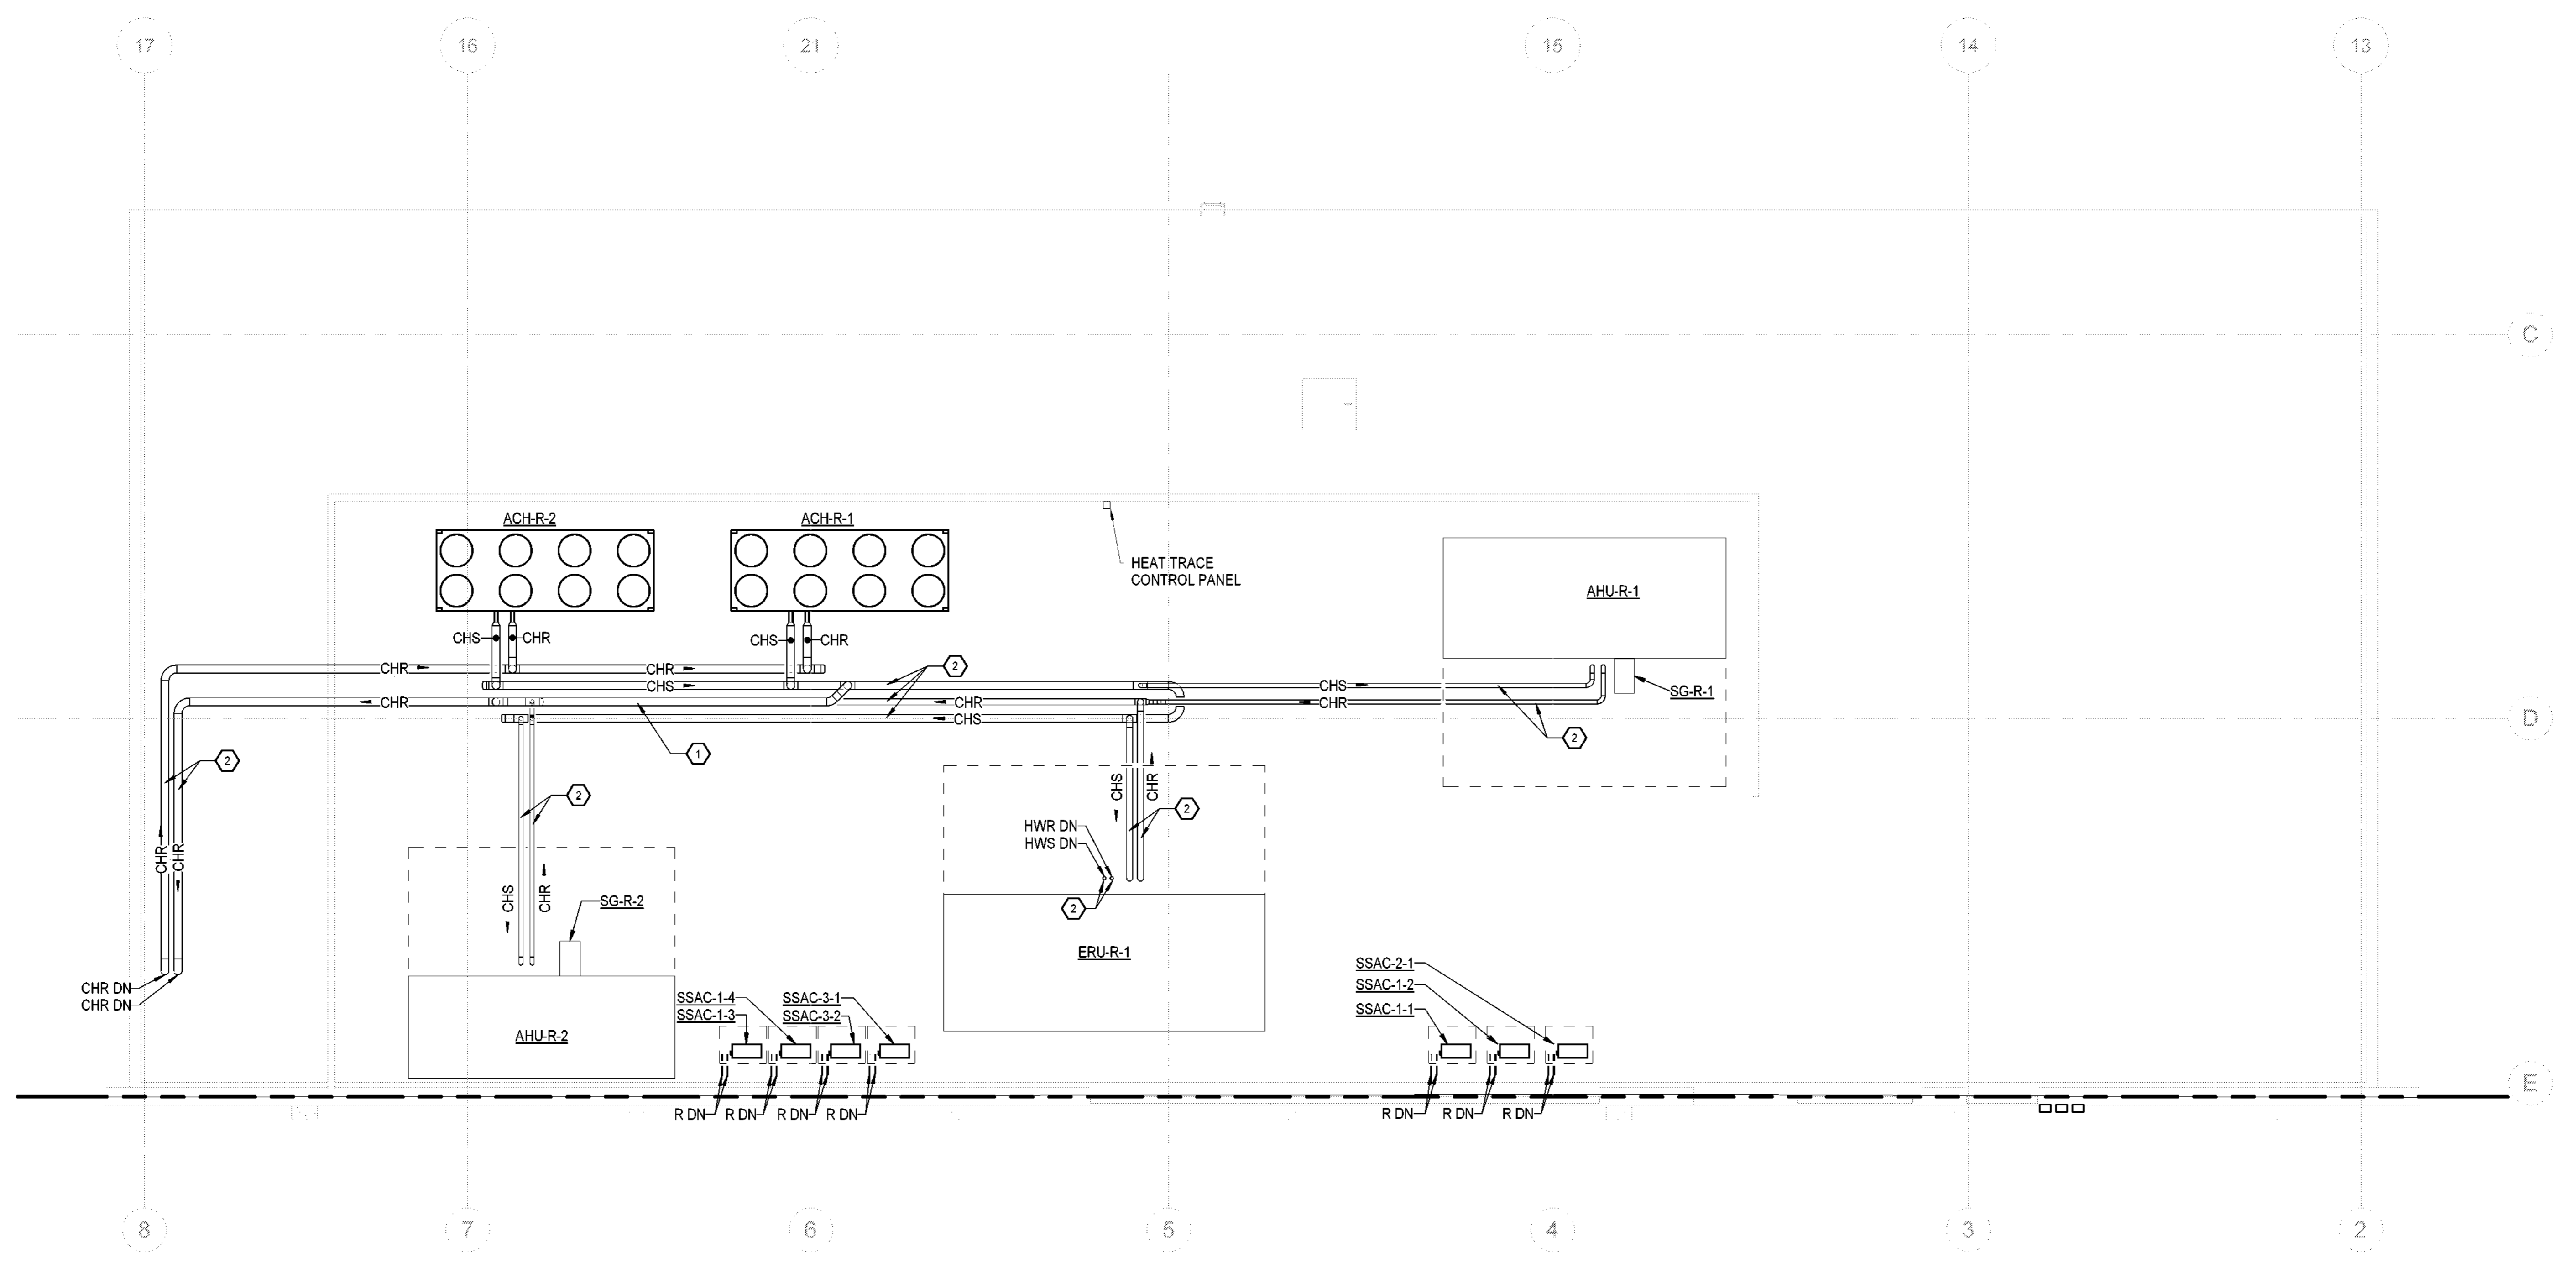
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**KEY NOTES:**

- 1. CHILLED WATER BYPASS PIPING. BYPASS PIPING ROUTED ABOVE CHILLED WATER RETURN PIPING. REFER TO 1M-401 AND 1M-703 FOR MORE INFORMATION.
- 2. PROVIDE HEAT TRACE FOR EXTERIOR HYDRONIC PIPING.



**Project Grace**

Grace Street  
Wilmington, NC 28401

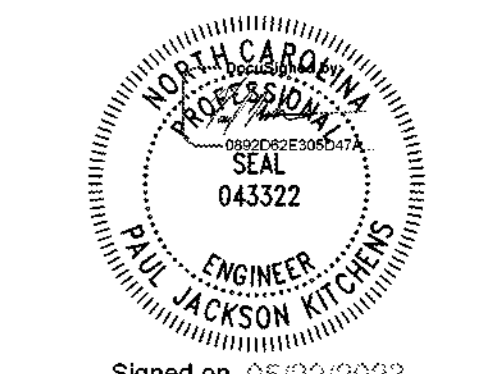LS3P PROJECT: 7701-177800

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**1 HVAC PIPING OVERALL ROOF**  
1/8" = 1'-0"


SHEET NAME:  
**HVAC PIPING  
OVERALL ROOF**

ORIG SUBMISSION: 2023.05.22


SHEET:  
**M-204**

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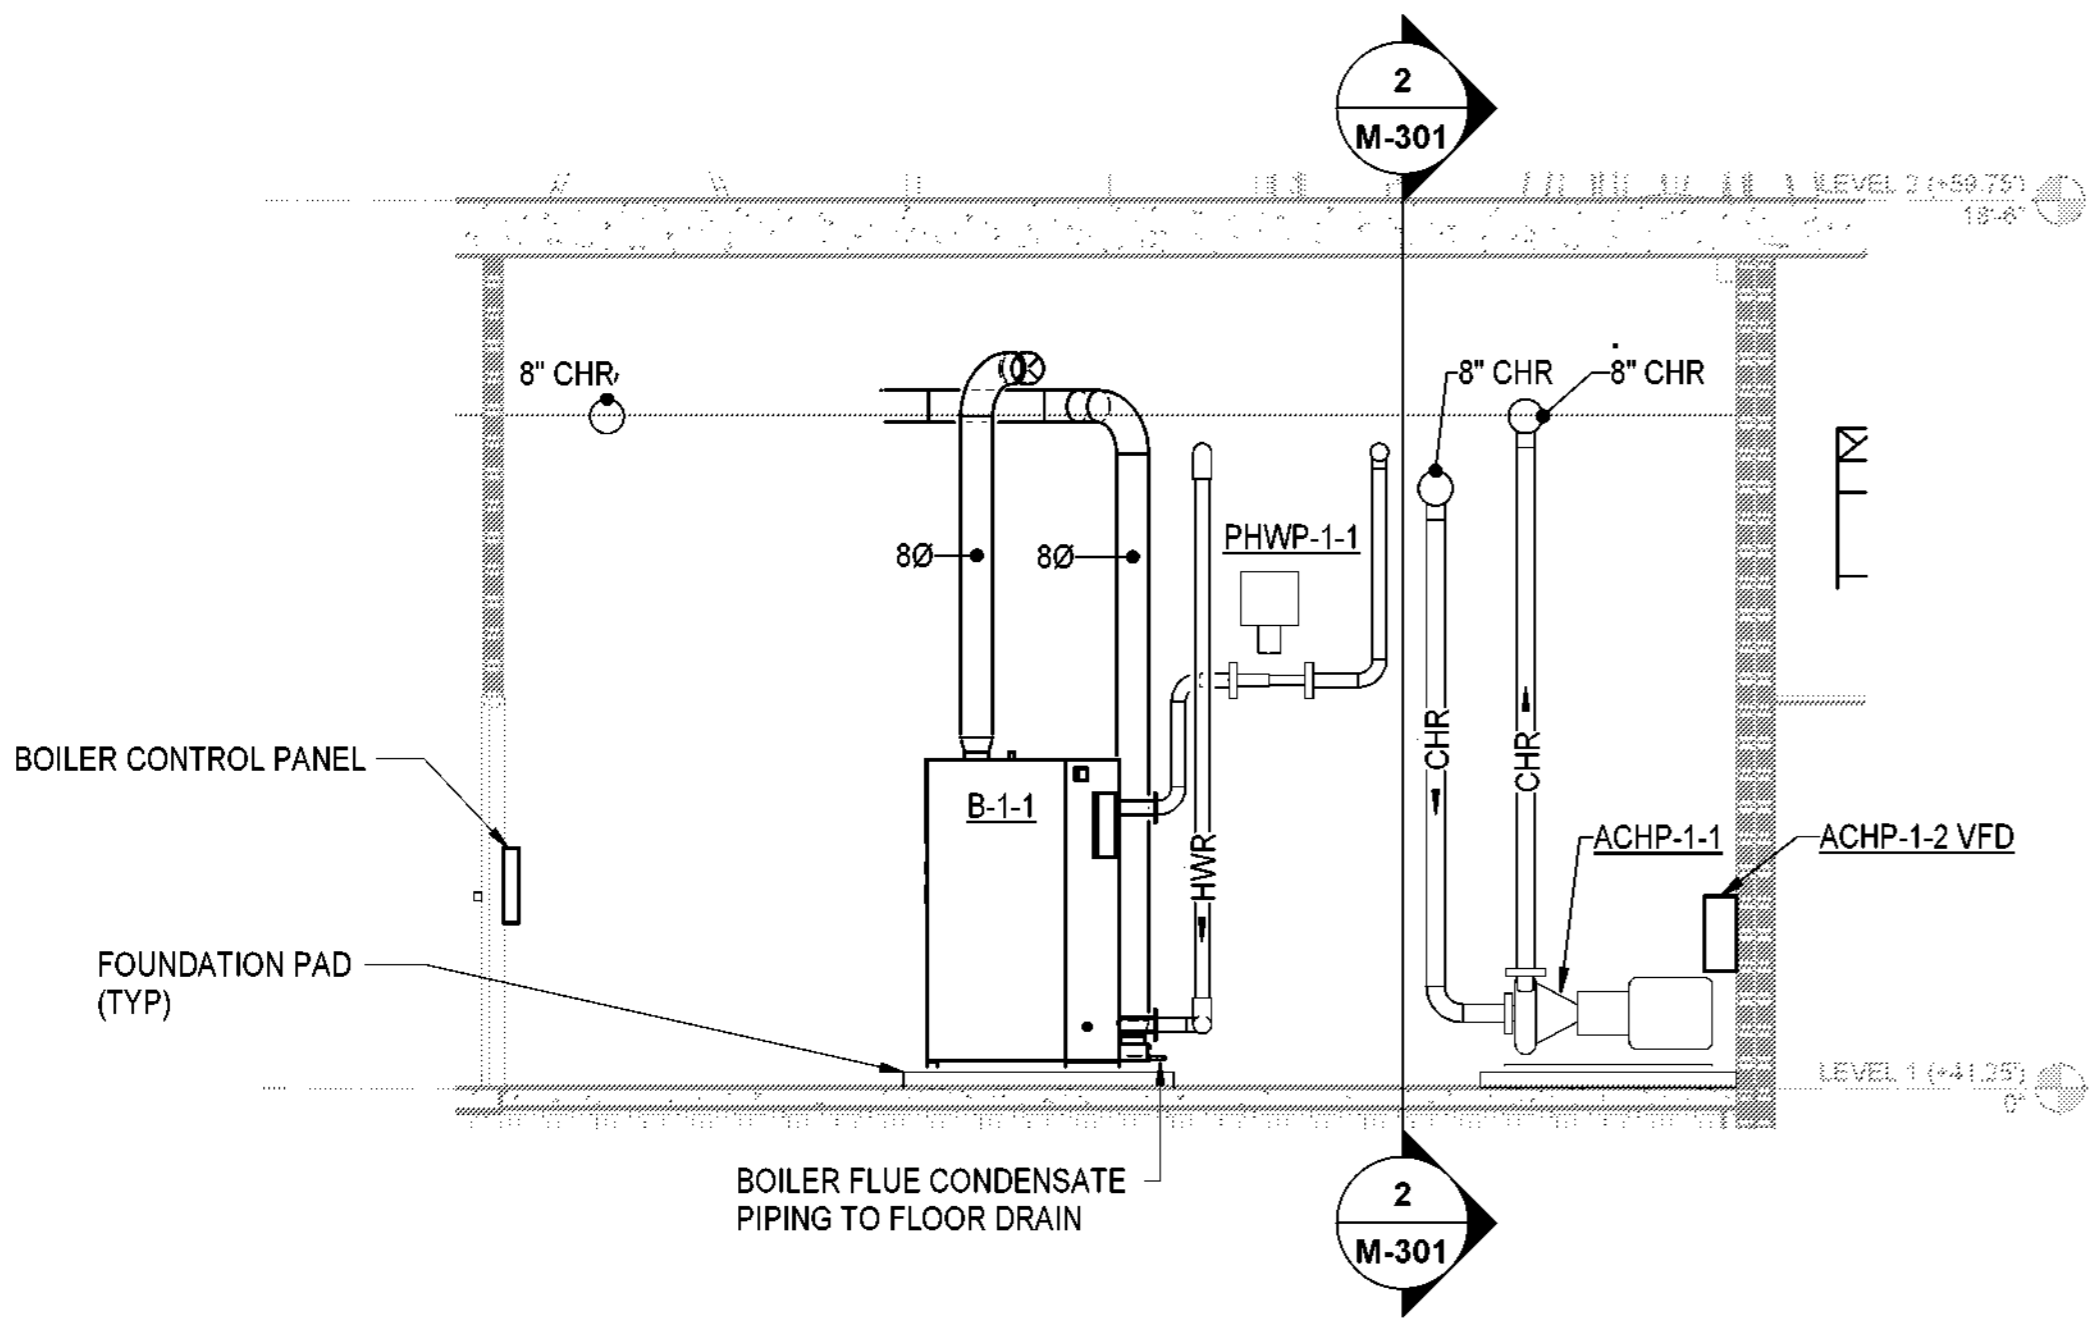


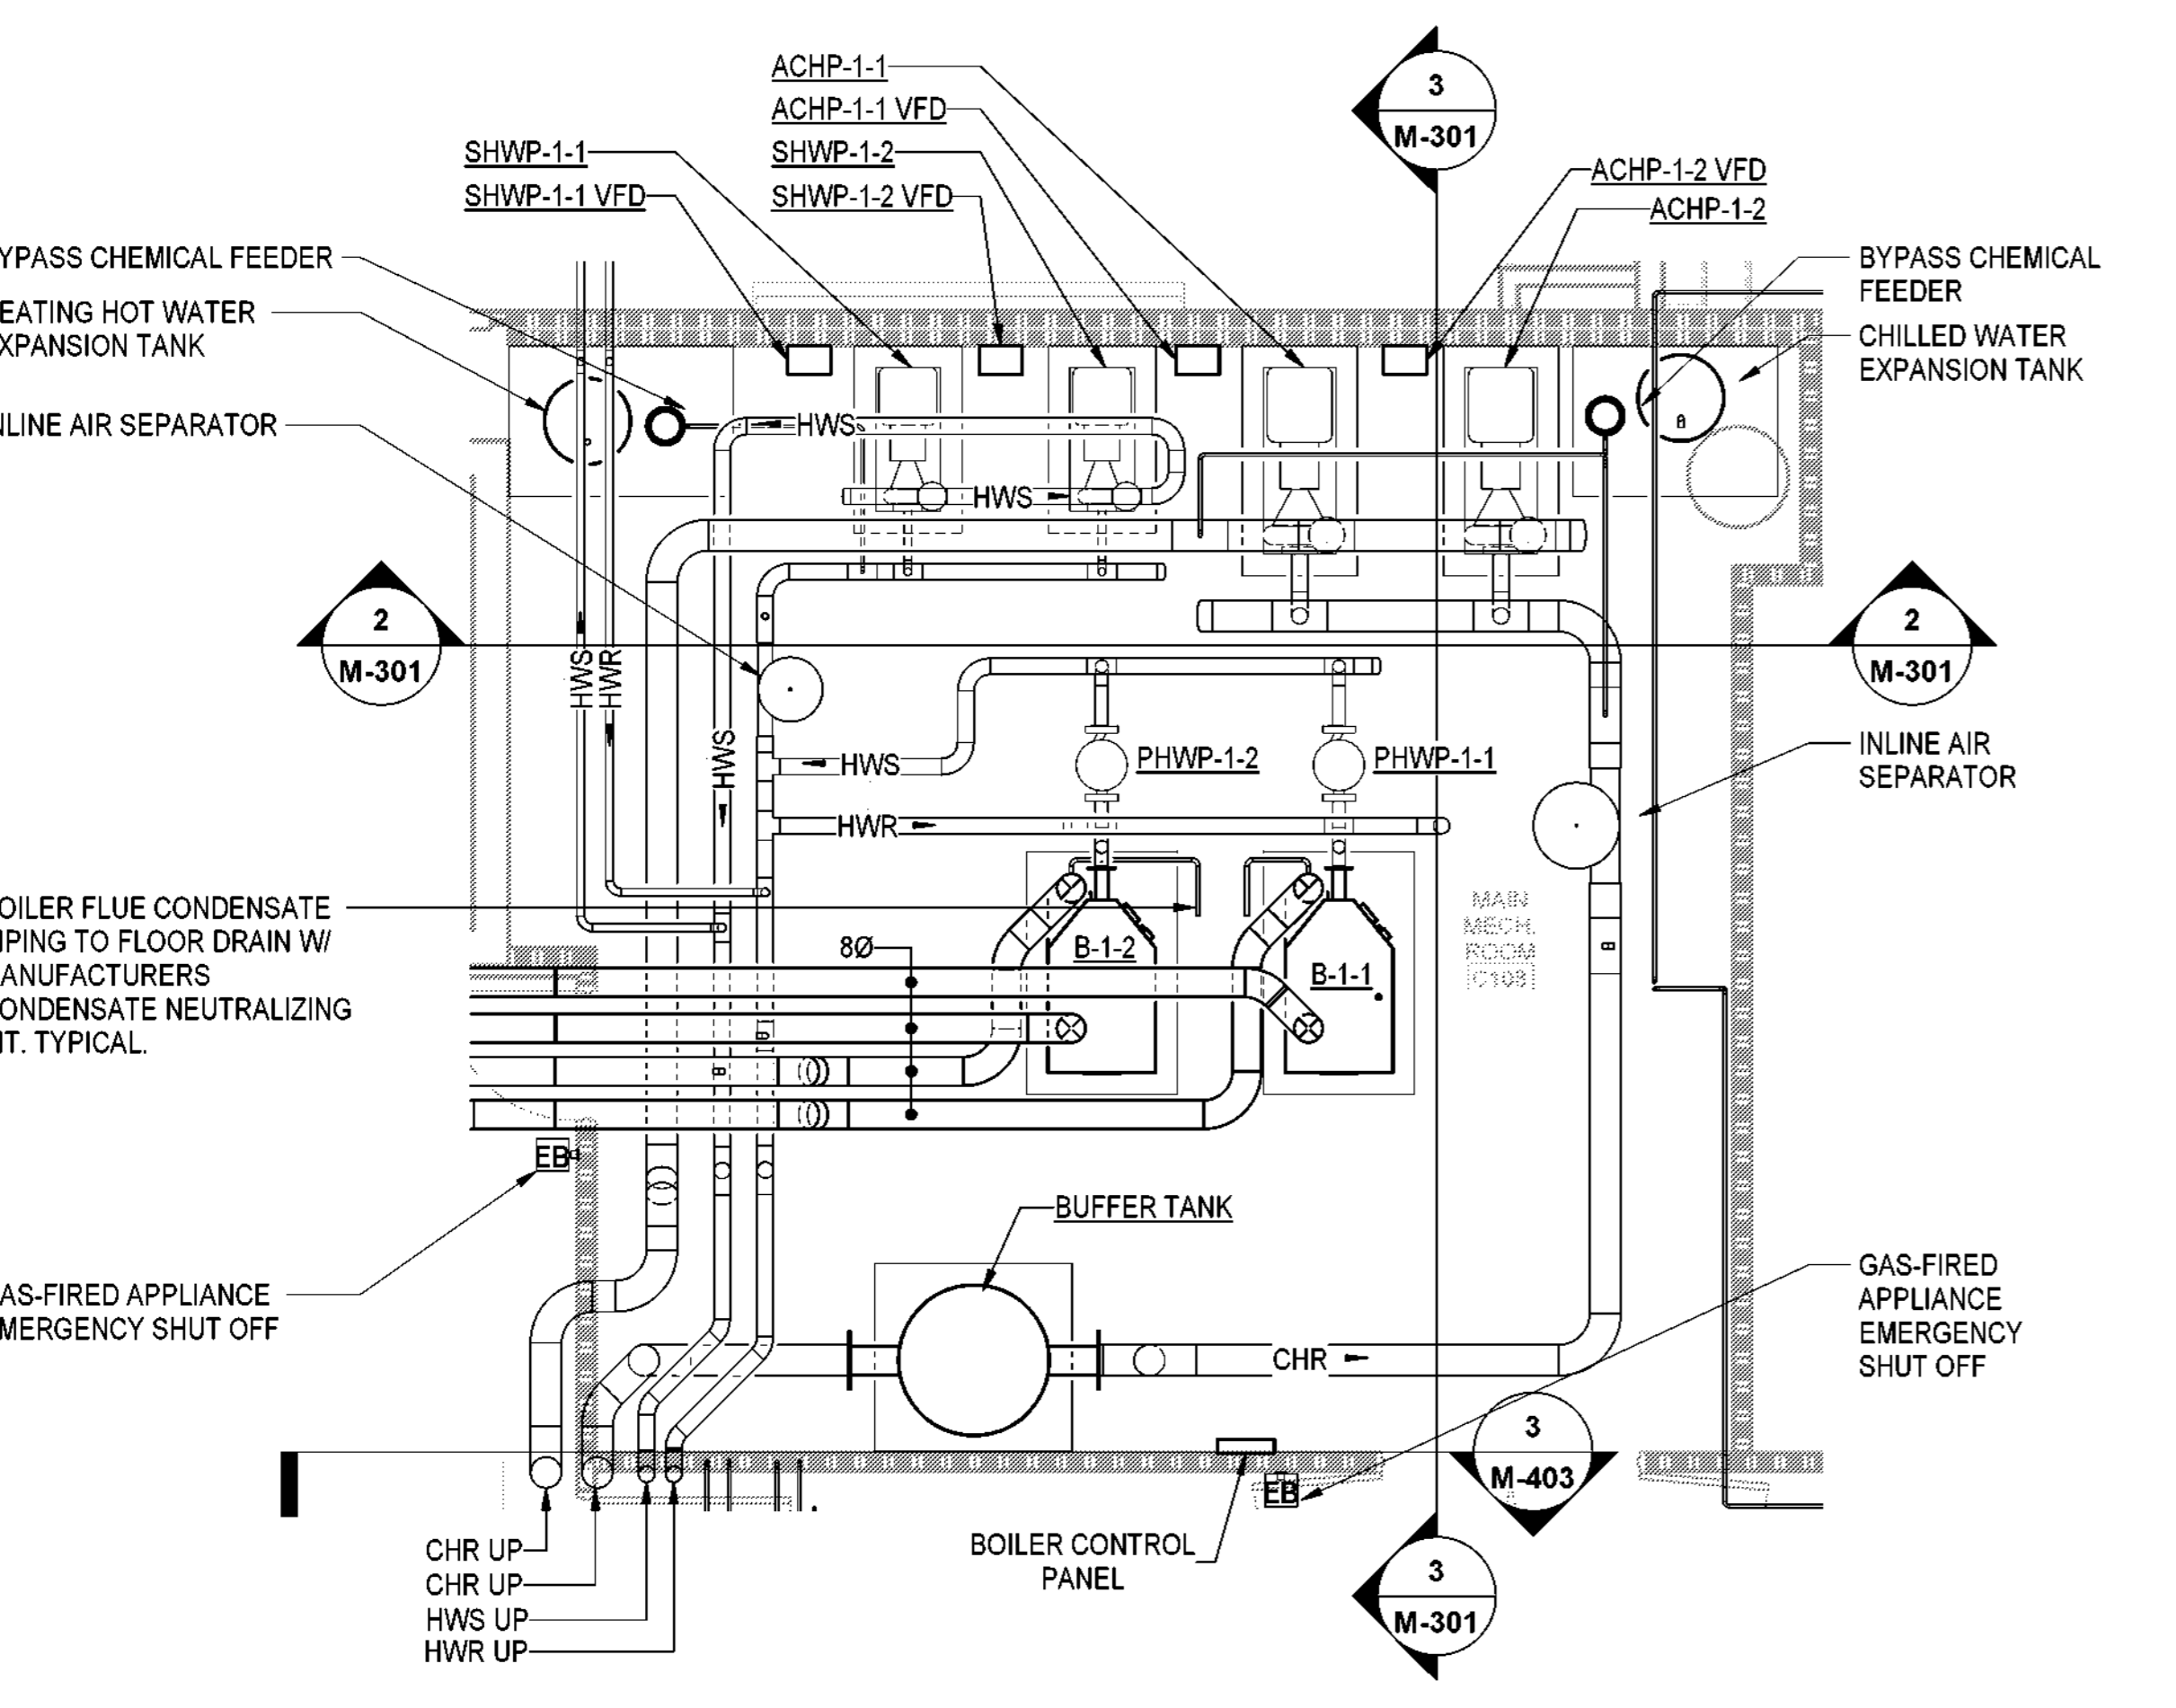


1 HVAC PART PLAN - MAIN MECHANICAL ROOM  
1/4" = 1'-0"

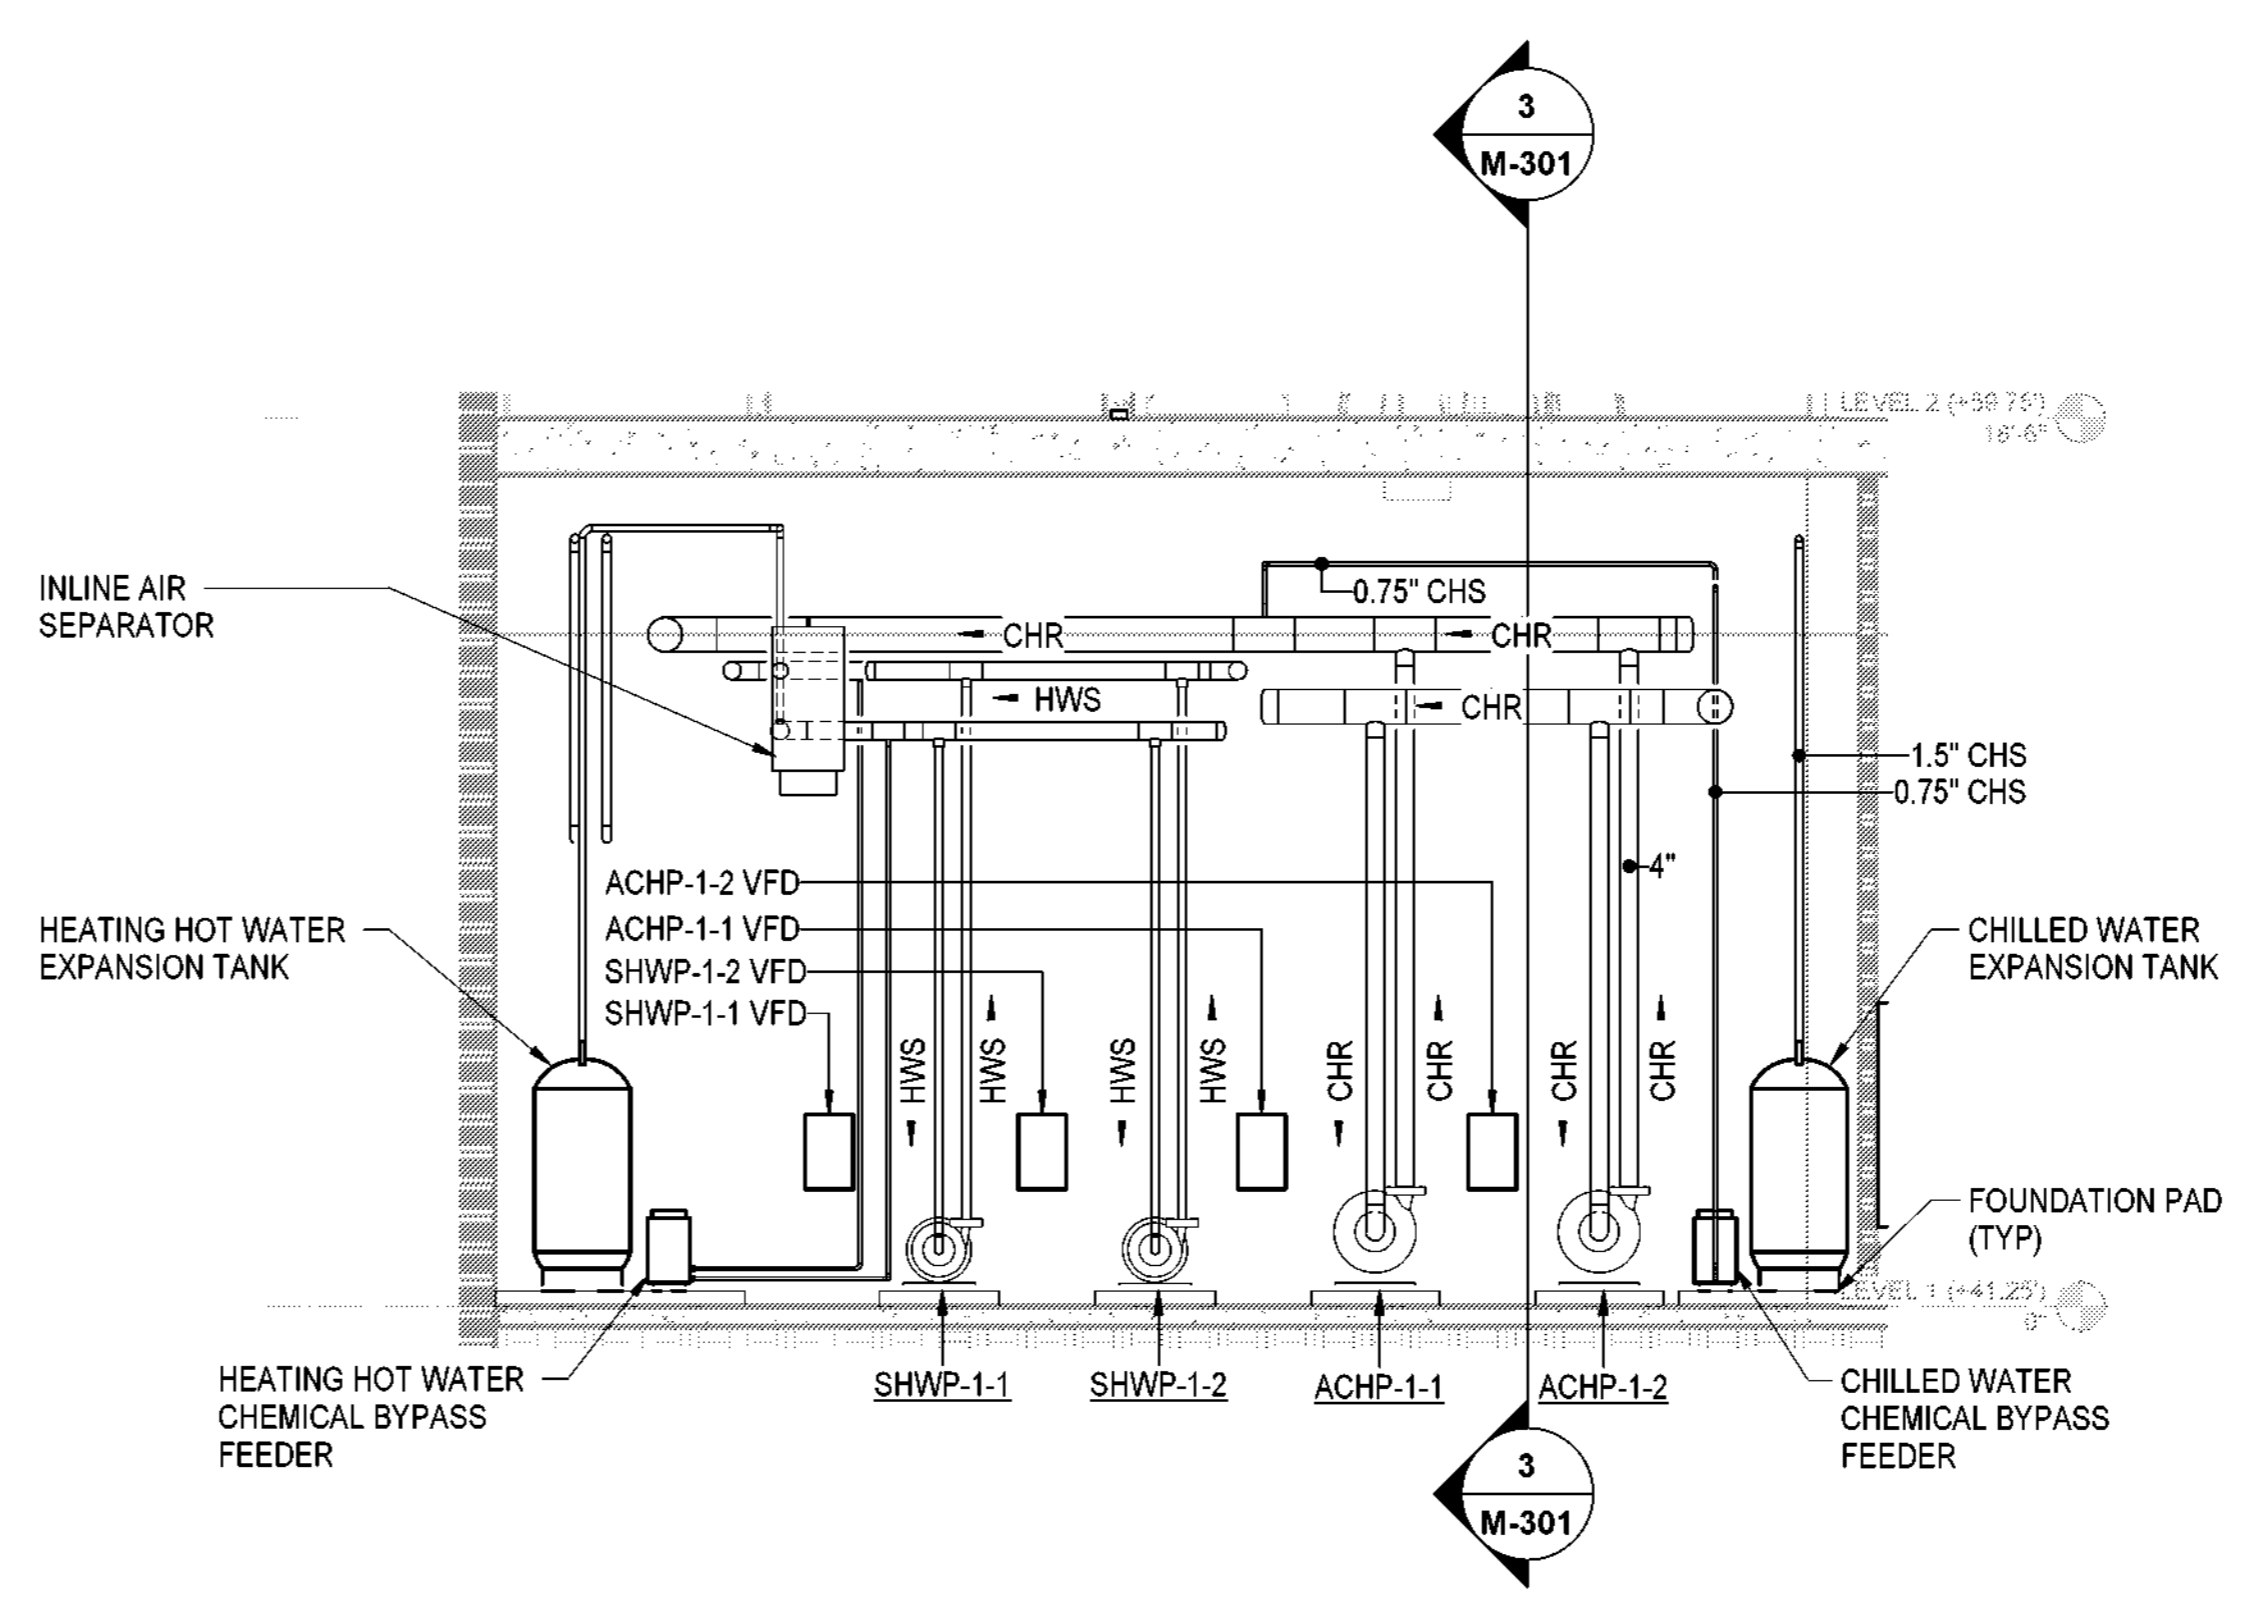

2 HVAC PART PLAN - MAIN MECHANICAL ROOM NORTH SECTION  
1/4" = 1'-0"



3 HVAC PART PLAN - MAIN MECHANICAL ROOM WEST SECTION  
1/4" = 1'-0"

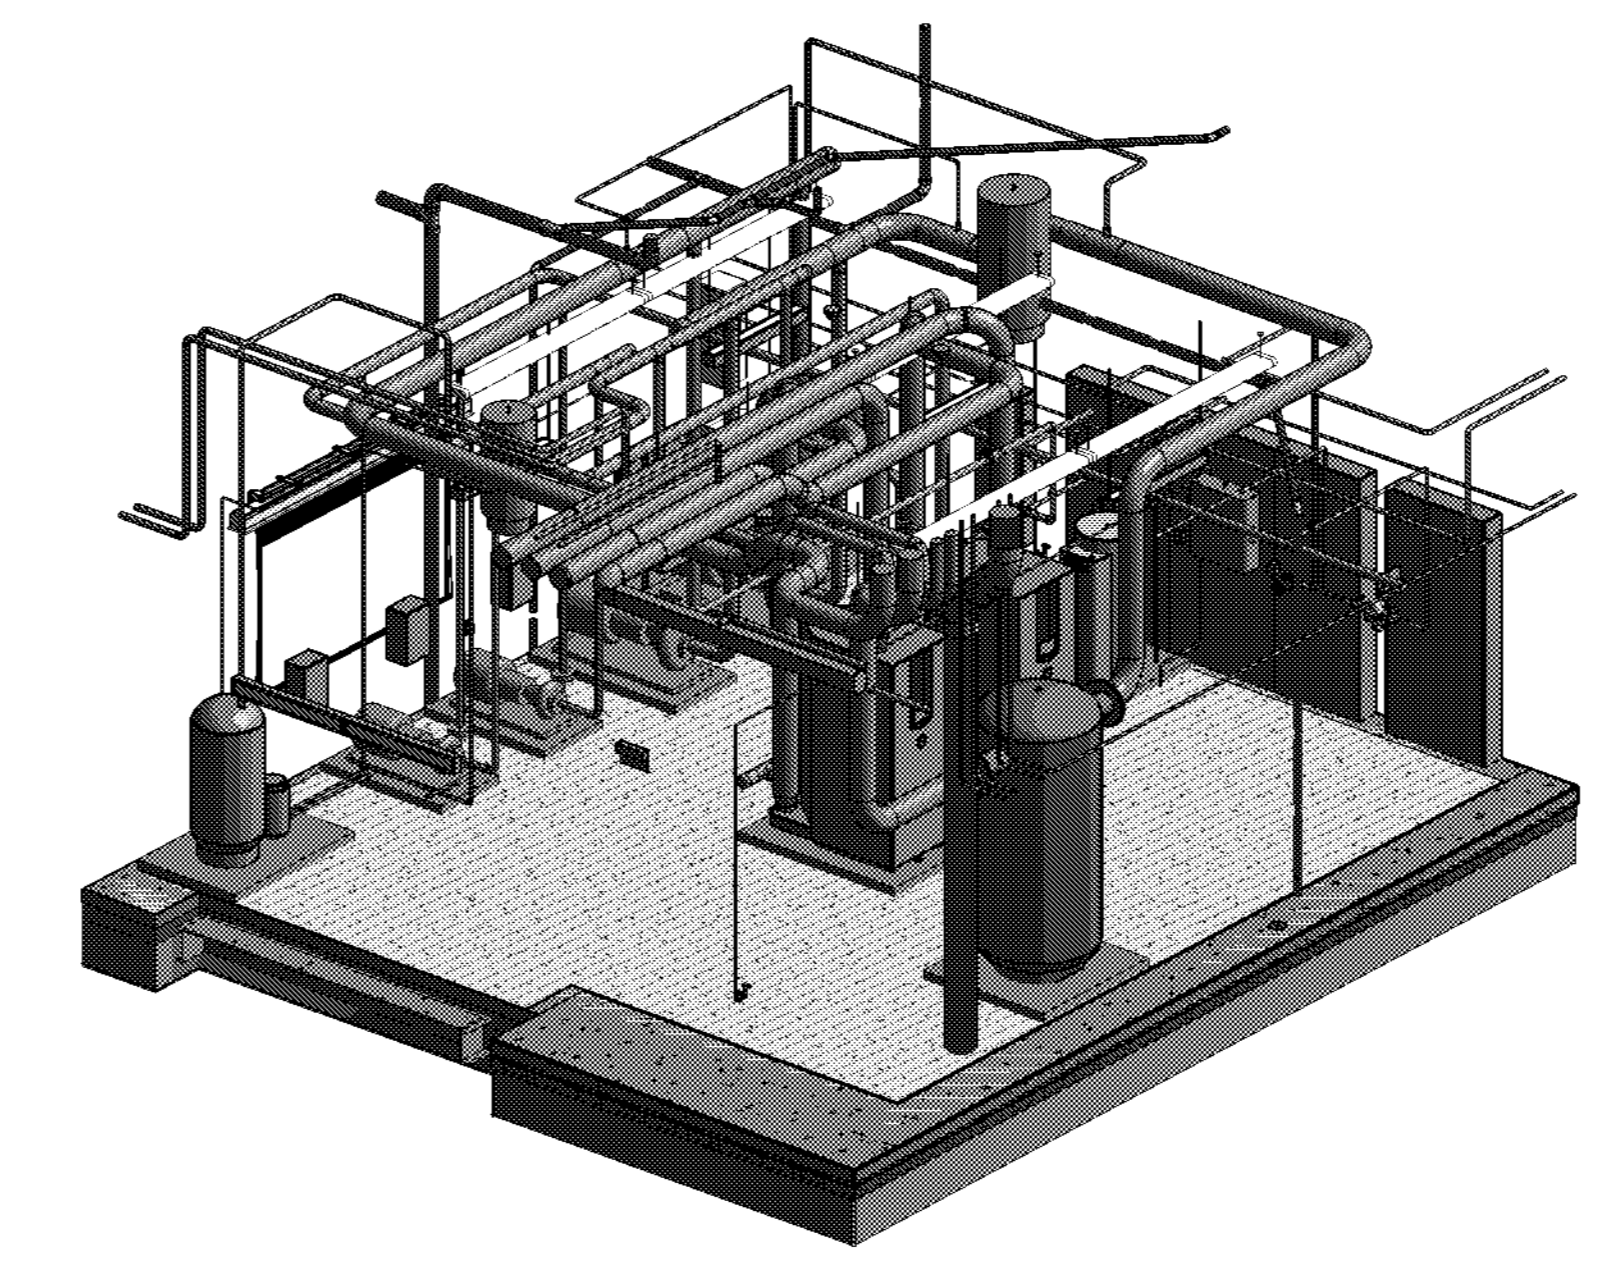


4 HVAC PART PLAN - MAIN MECHANICAL ROOM ISOMETRIC

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SHEET NAME:  
HVAC PART PLAN -  
MAIN MECHANICAL  
ROOM

ORIG: 2023.05.22  
SUBMISSION:

SHEET:  
**M-301**

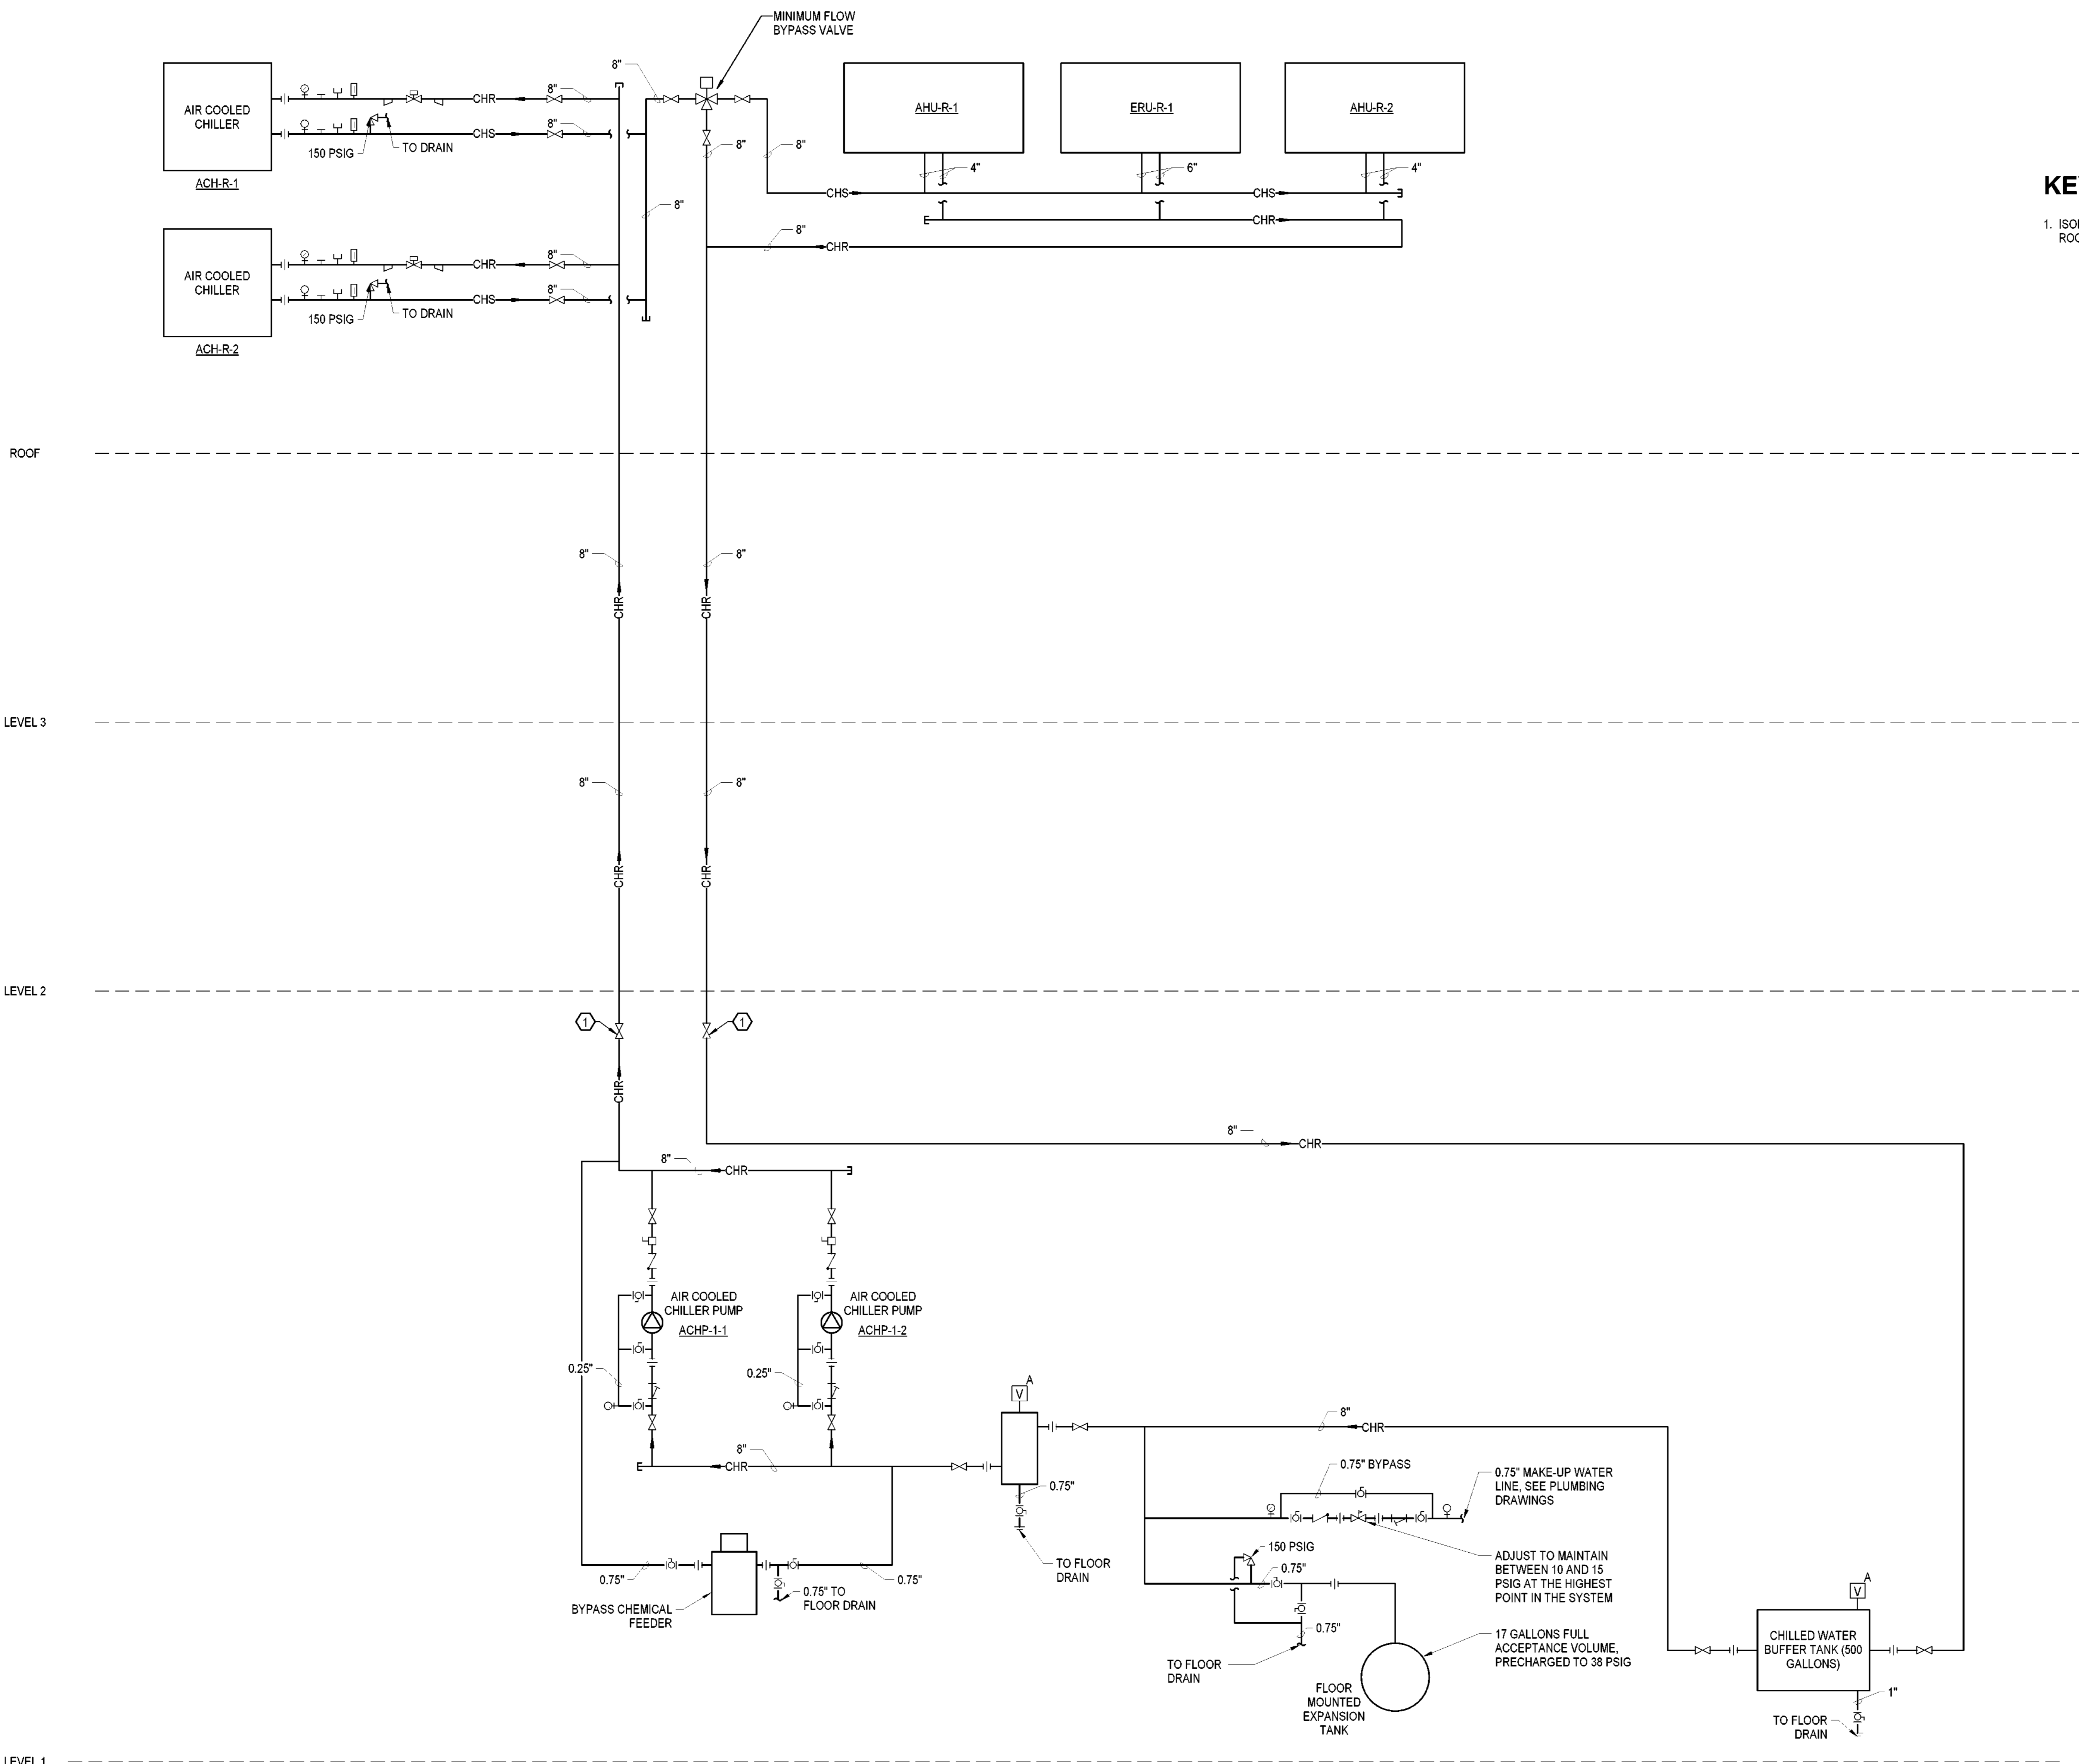

**KEY NOTES:**  
1. ISOLATION VALVES SHALL BE LOCATED IN MECHANICAL ROOM.




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**Project Grace**

Grace Street  
Wilmington, NC 28401  
LS3P PROJECT: 7701-177800

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**SHEET NAME:**  
HVAC CHILLED WATER FLOW SCHEMATIC

**ORIG SUBMISSION:** 2023.05.22

**SHEET:** M-401

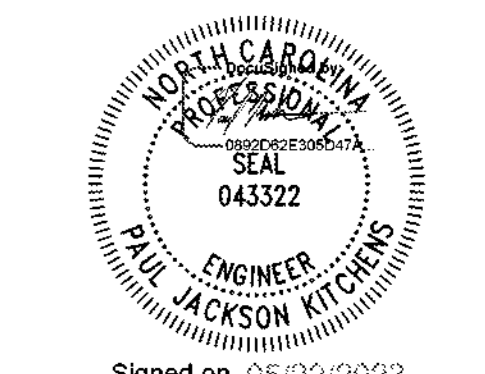**1 HVAC CHILLED WATER FLOW SCHEMATIC**  
NO SCALE



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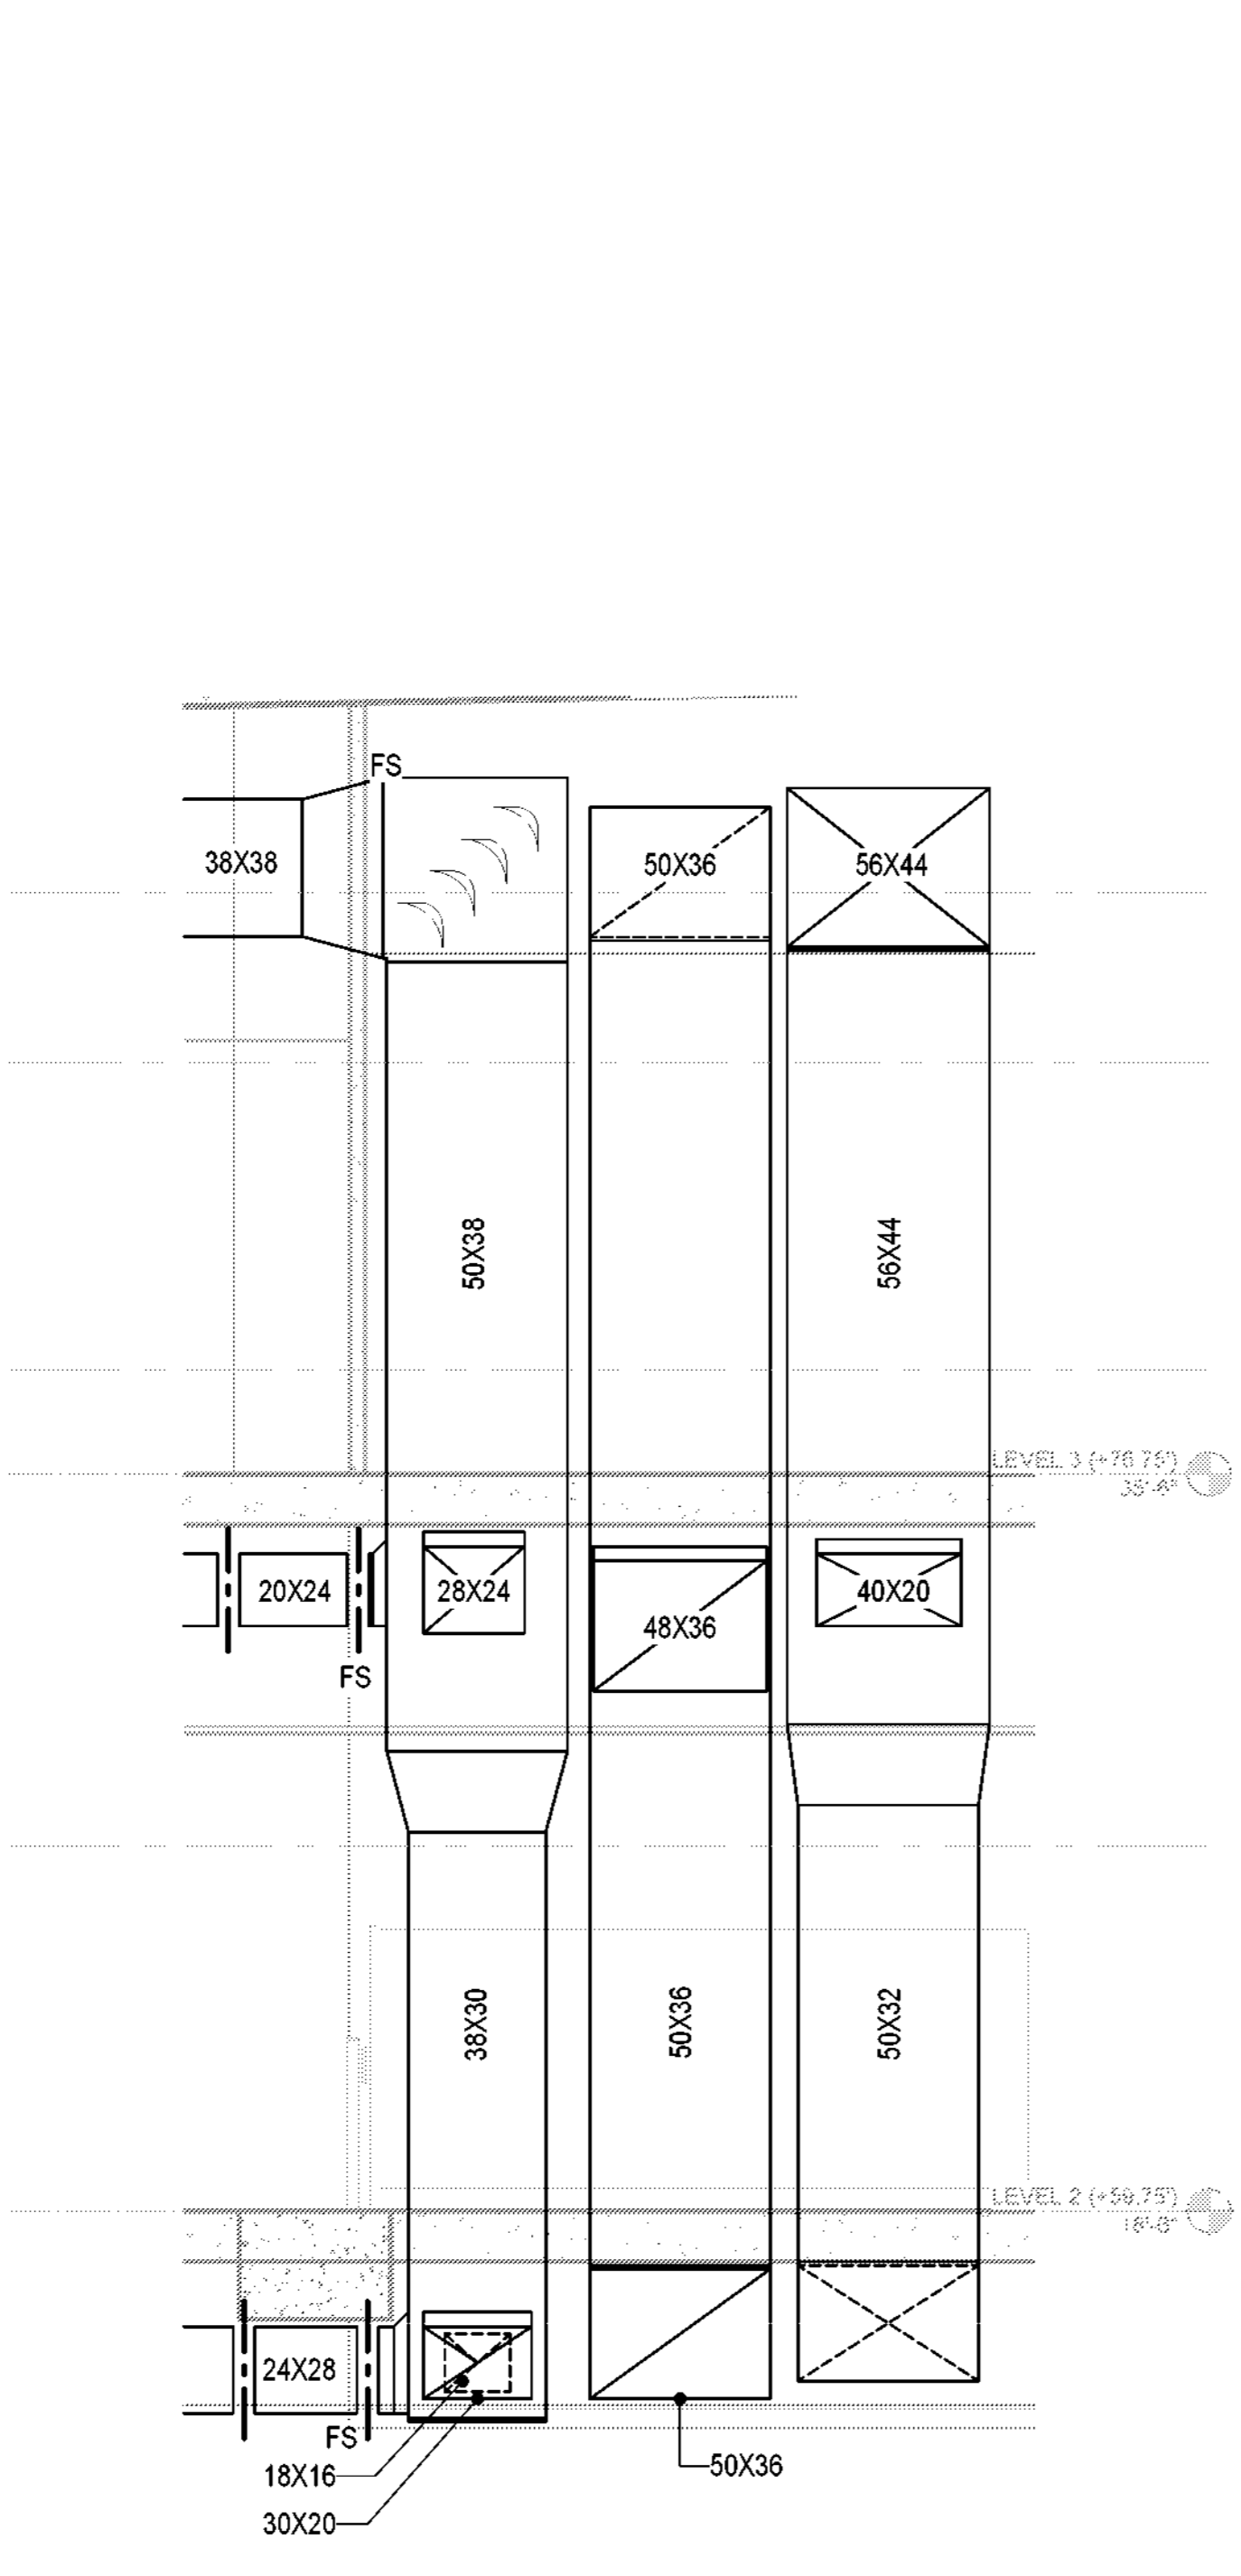
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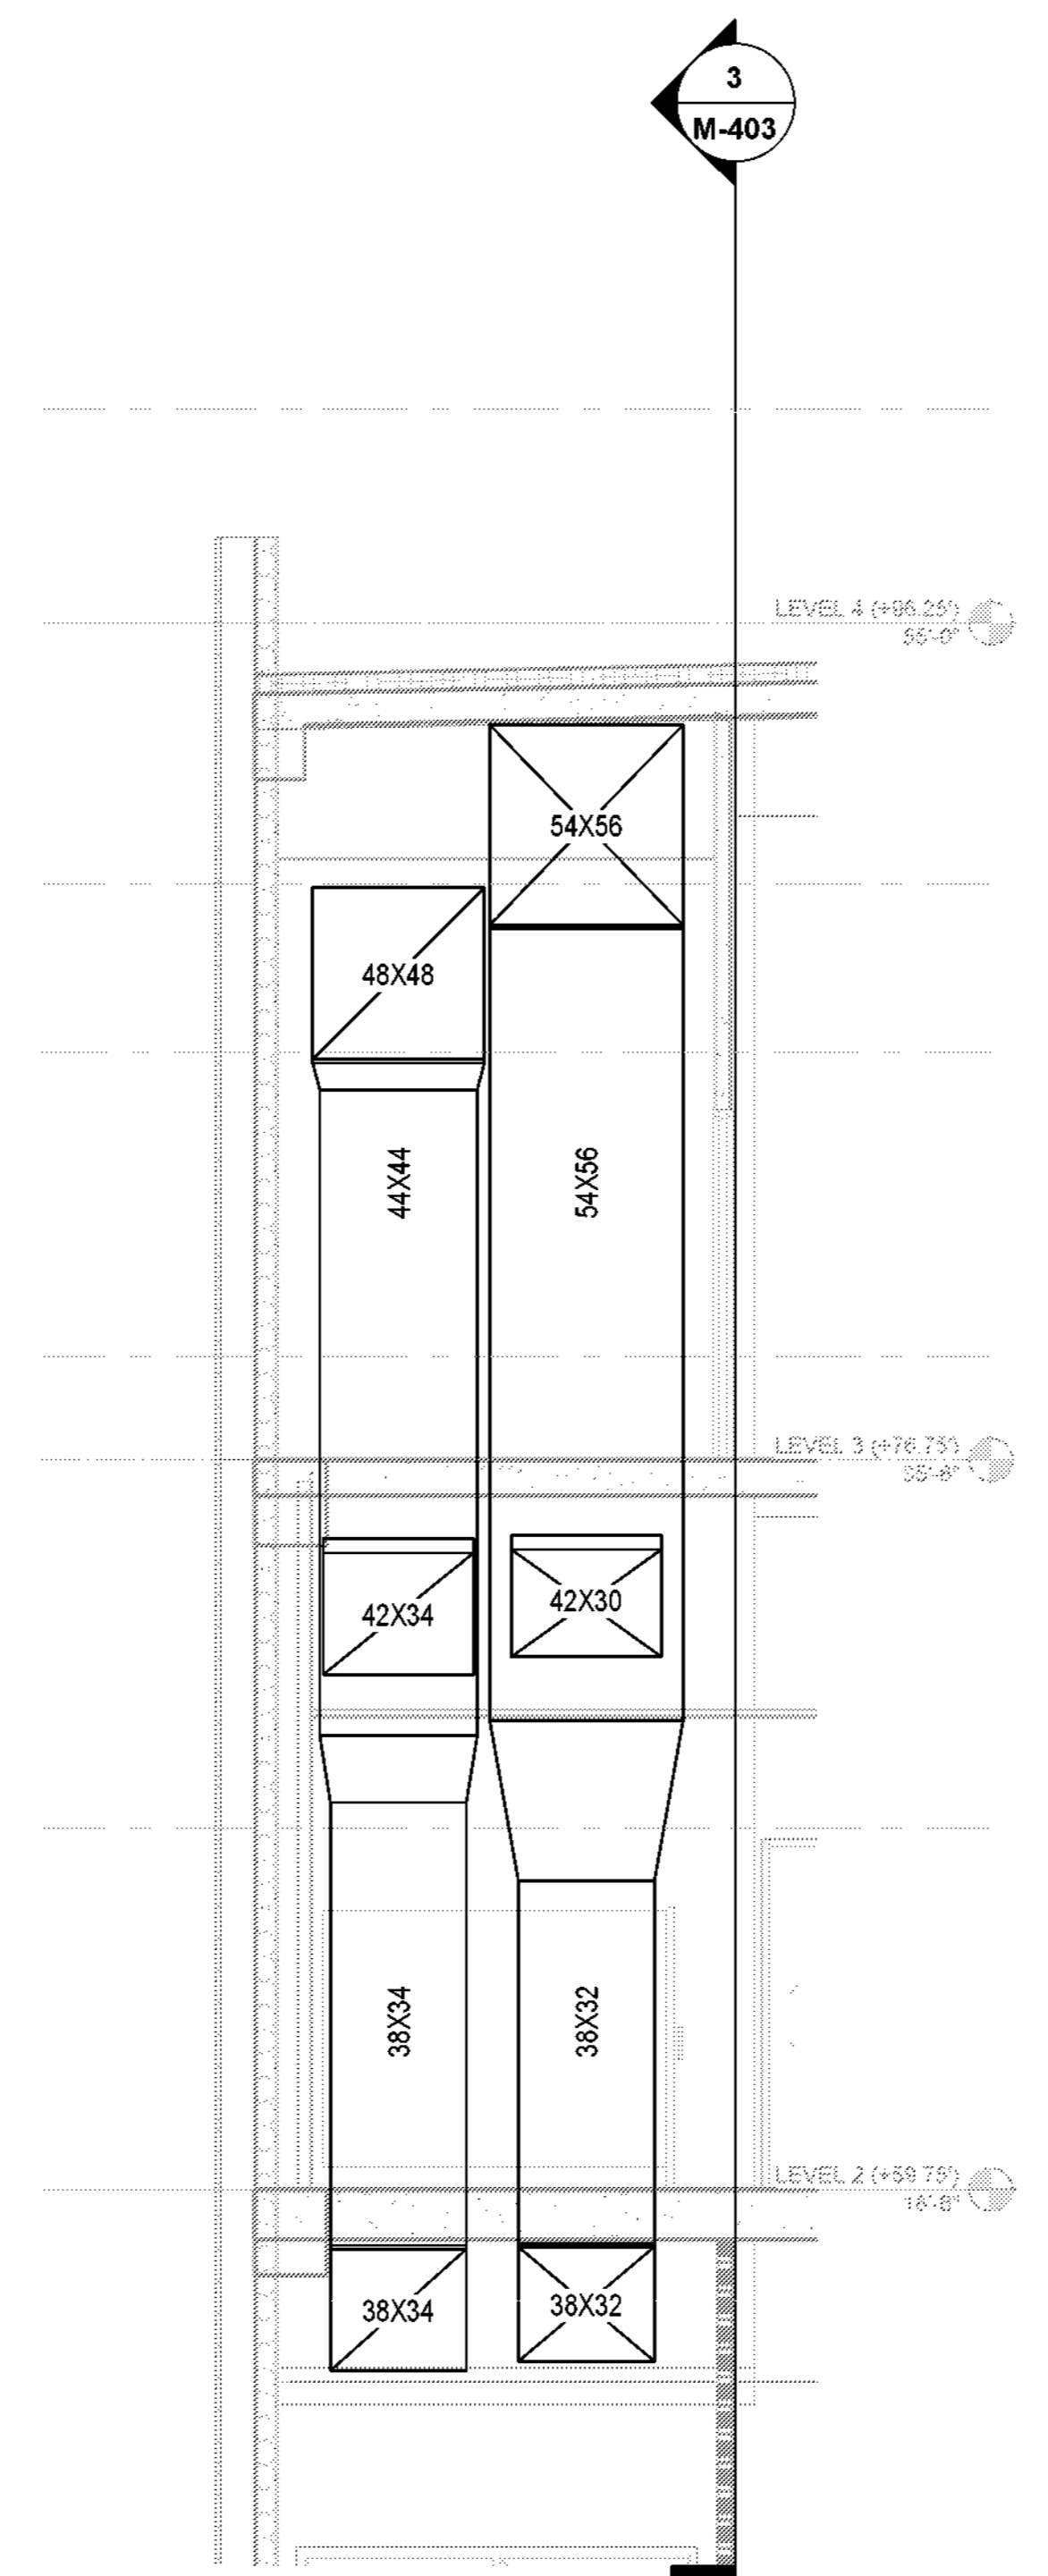
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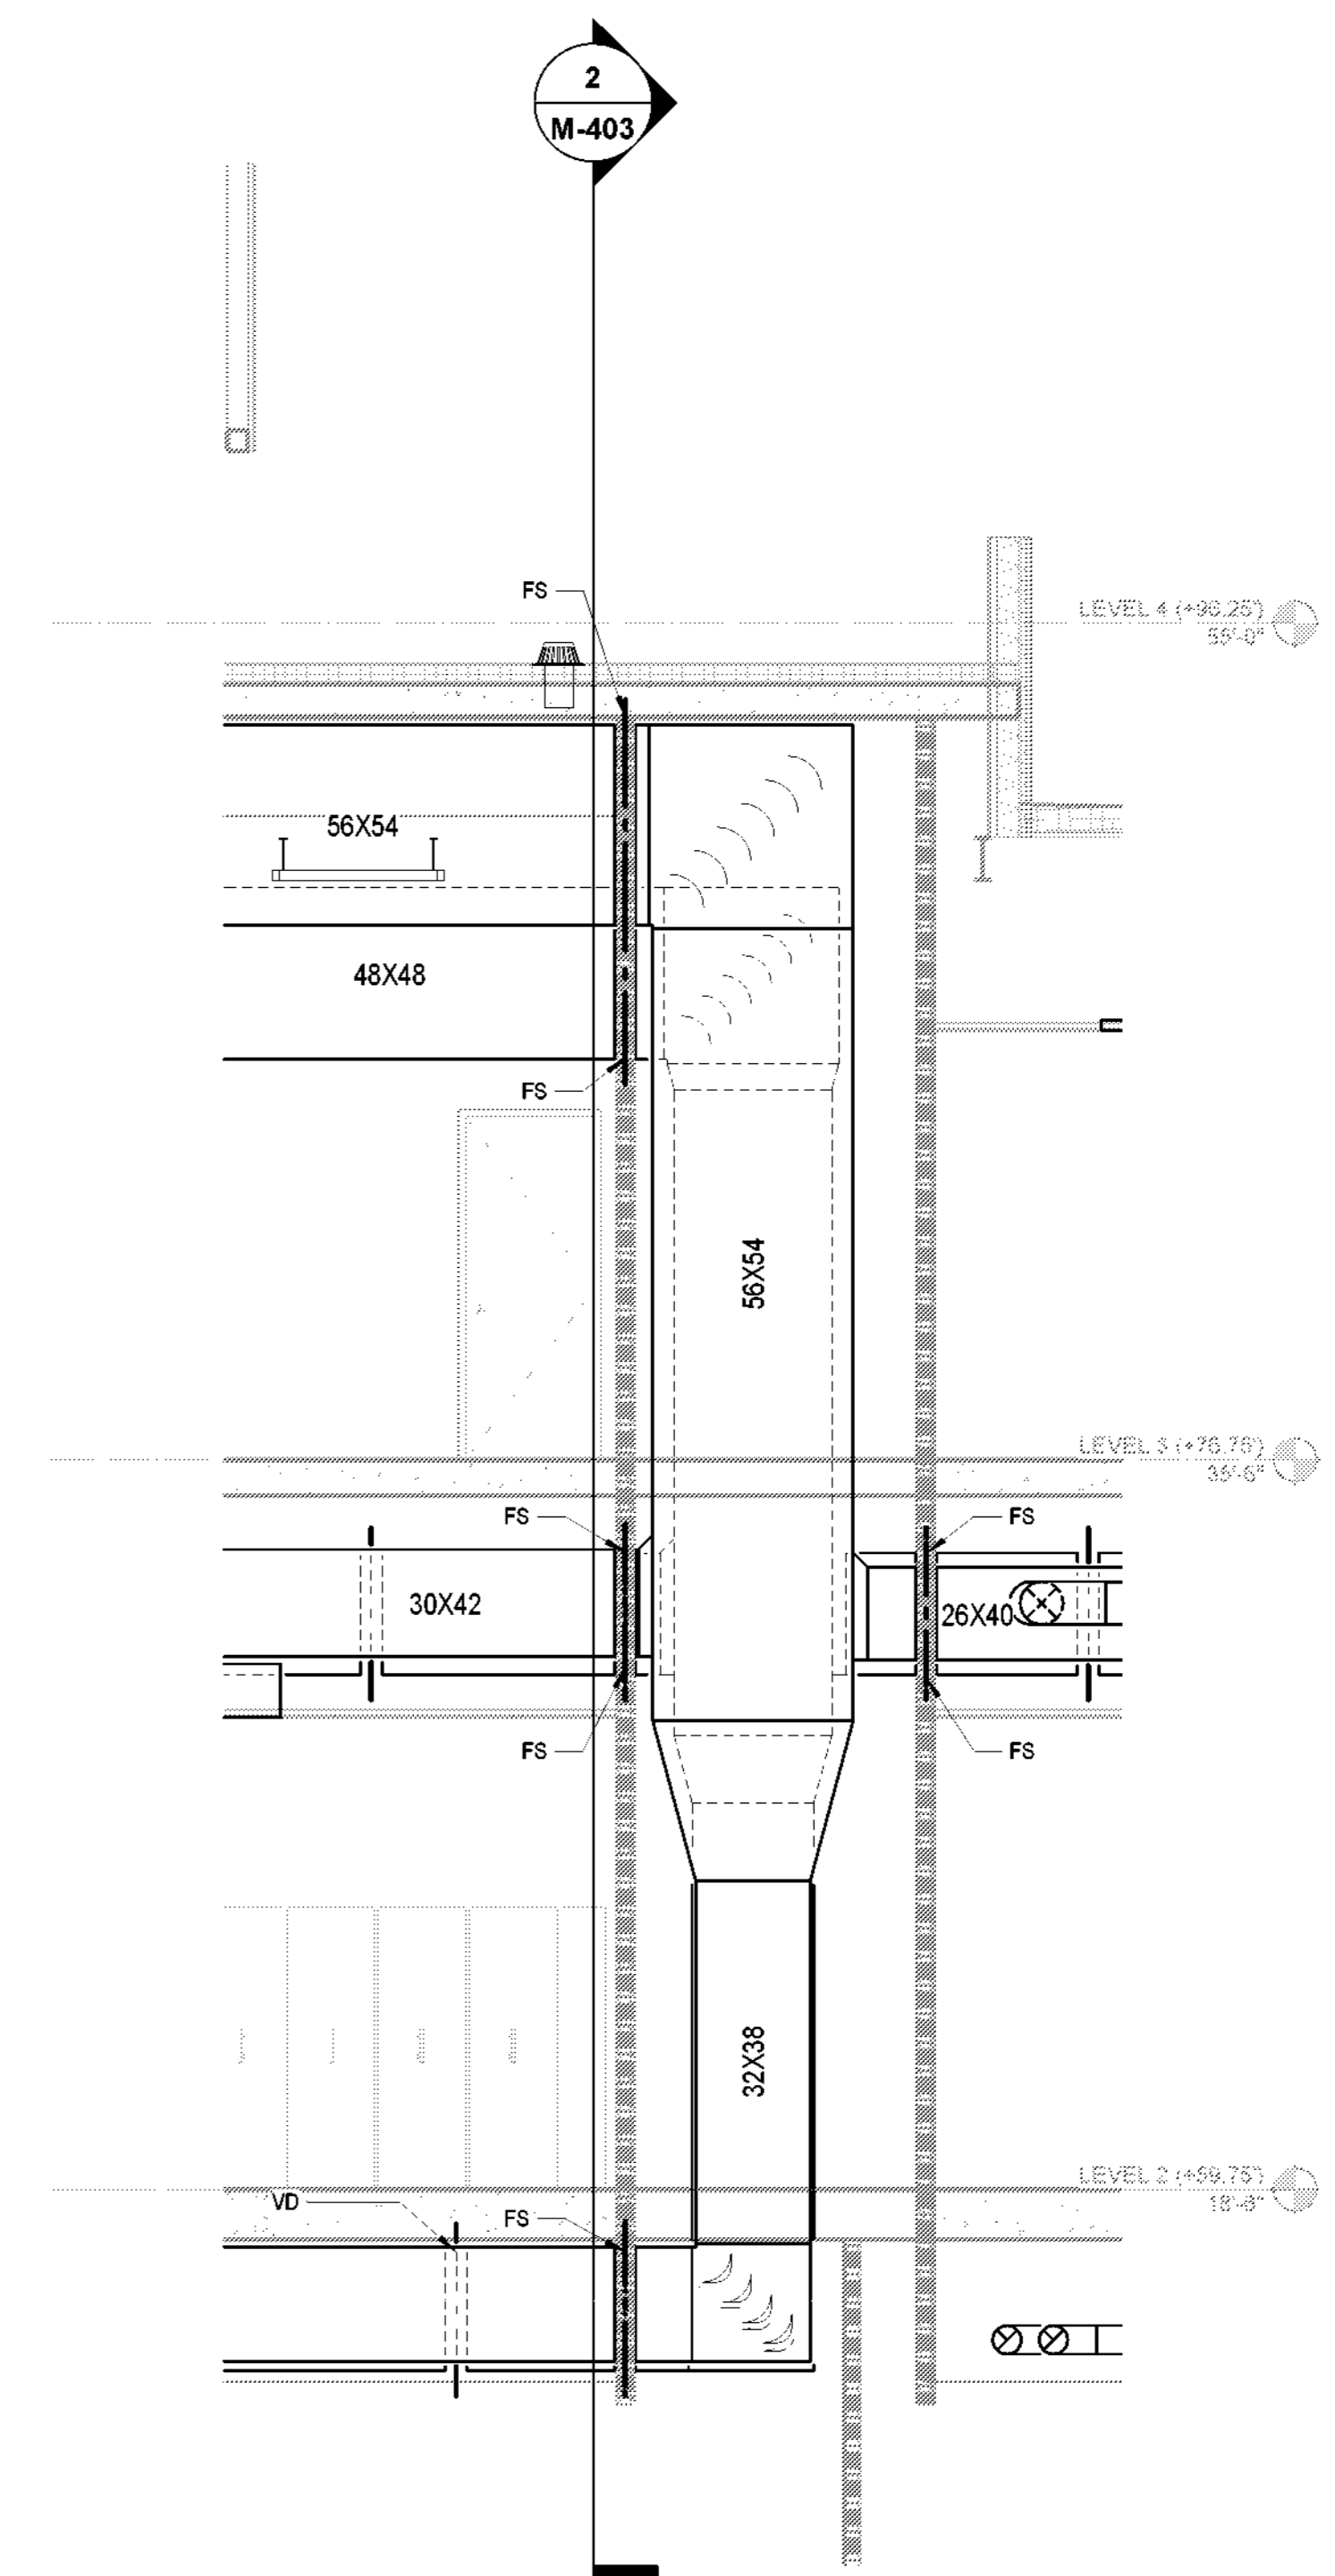
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**1 AHU-R-1 HVAC RISER**  
1/4" = 1'-0"



**2 AHU-R-2 HVAC RISER**  
1/4" = 1'-0"



**3 AHU-R-3 HVAC RISER**  
1/4" = 1'-0"




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**LSP**

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**Project Grace**

Grace Street  
Wilmington, NC 28401

LSP PROJECT: 7701-177800

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SHEET NAME:  
**HVAC RISER DIAGRAM**

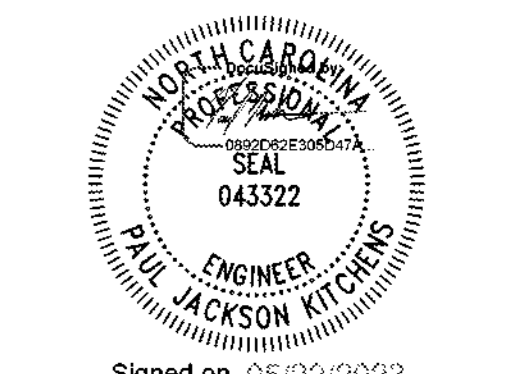ORIG SUBMISSION: 2023.05.22

SHEET:  
**M-403**

PERMIT SET




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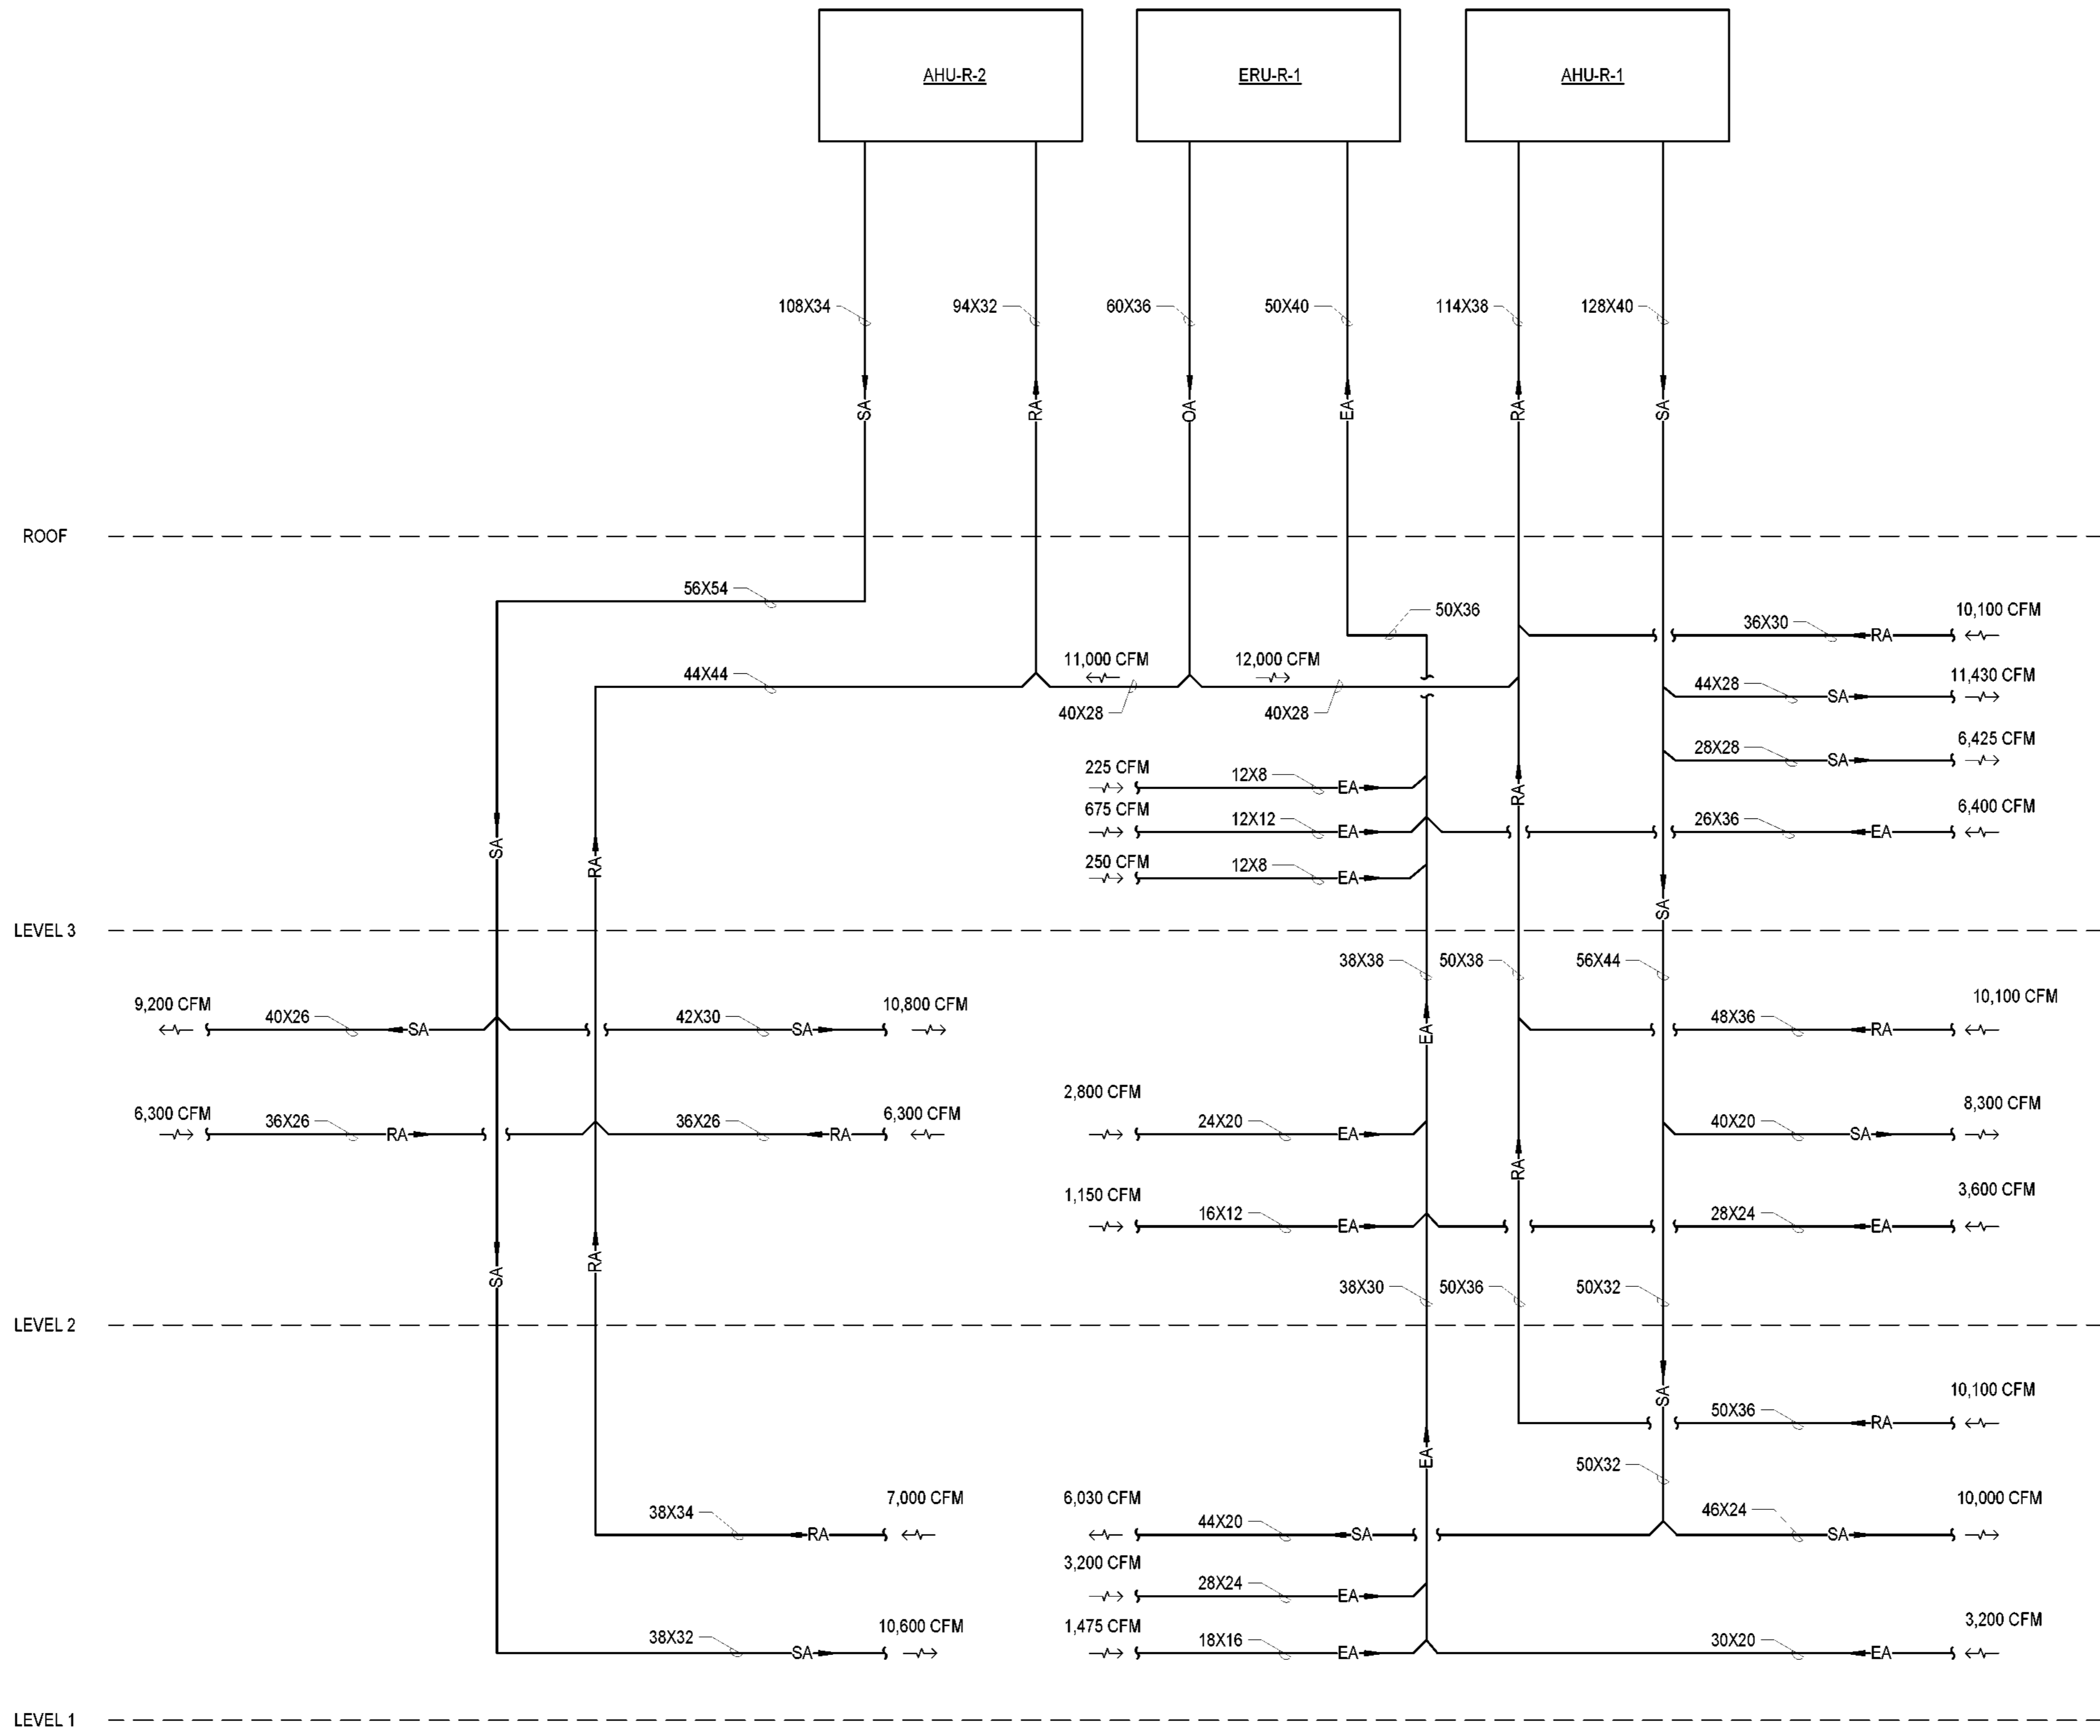
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**1 HVAC AIR FLOW SCHEMATIC**  
NO SCALE

**Project Grace**

Grace Street  
Wilmington, NC 28401

LS3P PROJECT: 7701-177800

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SHEET NAME:  
**HVAC AIR FLOW  
DIAGRAM**

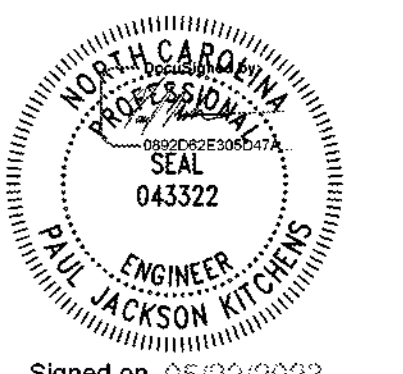ORIG SUBMISSION: 2023.05.22

SHEET:  
**M-404**

PERMIT SET

THEME: PROMOTIVE & QUALITY TO OBTAIN PERMIT

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ENERGY RECOVERY UNIT SCHEDULE

Table with columns for NO., CONDITIONS OF OPERATION, OUTSIDE AIR CONDITIONS, SUPPLY FAN (NOTE 14), FILTERS, ENERGY RECOVERY WHEEL (NOTE 4), COOLING COIL (NOTE 12), and HOT WATER HEATING COIL (NOTE 12).

ENERGY RECOVERY UNIT SCHEDULE CONTINUED

Table with columns for NO., CONDITIONS OF OPERATION, EXHAUST FAN (NOTE 14), FILTERS, ENERGY RECOVERY WHEEL (NOTE 9), and VIBRATION ISOLATION.

- 1. FAN TYPE: FAN: C/DWDI CENTRIFUGAL P PLUG M MIXED-FLOW. WHEEL: AF AIRFOIL FC FORWARD-CURVED BI BACKWARD-INCLINED. 3. FILTER TYPE: P PLEATED. 6. CHILLED WATER BASED ON 44°F EWT AND MAXIMUM 18' WPD. 10. MAXIMUM 0.20" WG APD. 11. HOT WATER BASED ON 140°F EWT AND MAXIMUM 6' WPD. 12. PROVIDE COOLING AND HEATING COIL CONNECTIONS THROUGH SIDE OF UNIT. 13. CFM DOES NOT INCLUDE PURGE FOR WHEEL. 14. PROVIDE VARIABLE FREQUENCY DRIVE FOR FAN MOTOR. 15. REFER TO THE ELECTRICAL DRAWINGS FOR THE EQUIPMENT ELECTRICAL CHARACTERISTICS.

AIR HANDLING UNIT SCHEDULE

Table with columns for NO., AREA SERVED (NOTE 1), TYPE (NOTE 2), FAN, MOTOR, COOLING COIL, HUMIDIFIER, and VIBRATION ISOLATION.

- 1. DESIGN CONDITIONS: OUTSIDE LIBRARY GALLERIES OFFICES ELECTRICAL ROOMS MECHANICAL SPACES COMMUNICATION ROOMS ELEVATOR MACHINE ROOMS. 3. FAN TYPE: P PLENUM. WHEEL: AF AIRFOIL. 4. EXTERNAL STATIC PRESSURE DOES NOT INCLUDE UNIT CASING, PLENUMS, DIFFUSER SECTION, OR UNIT MOUNTED HEATING AND COOLING COILS, BUT DOES INCLUDE FILTERS. 5. MAXIMUM FOR VARIABLE VOLUME UNITS: 550 FPM COIL FACE VELOCITY, .2" WG APD. 6. CHILLED WATER BASED ON 44°F EWT, 58°F LWT AND MAXIMUM 18' WPD. 7. CONTROL VALVE TYPE: 2 2-WAY. 8. TYPE: A ELECTRIC. 9. HUMIDIFIER SELECTION SHALL PROVIDE COMPLETE ABSORPTION OF STEAM INTO THE AIR-STREAM PRIOR TO CONTACT WITH DOWNSTREAM COMPONENTS. 10. PROVIDE OUTDOOR RATED ENCLOSURE FOR HUMIDIFIER. BASIS OF DESIGN IS DRISTEEM RX SERIES. 11. PROVIDE VARIABLE FREQUENCY DRIVES. 12. REFER TO THE ELECTRICAL DRAWINGS FOR EQUIPMENT ELECTRICAL CHARACTERISTICS. 13. PRE-FILTER: PLEATED, MERV 8. 14. FILTER: VARICAL VXL CARTRIDGE, MERV 14.

PUMP SCHEDULE

Table with columns for NO., SERVICE, TYPE (NOTE 1), GPM, TOTAL DYNAMIC HEAD, FT. WG, MINIMUM EFFICIENCY, %, RPM, MOTOR, and VIBRATION ISOLATION.

- 1. TYPE: I INLINE E END-SUCTION. 2. PROVIDE VARIABLE FREQUENCY DRIVE. 3. REFER TO THE ELECTRICAL DRAWINGS FOR THE EQUIPMENT ELECTRICAL CHARACTERISTICS.

AIR-COOLED CHILLER SCHEDULE

Table with columns for NO., CAPACITY, TONS (NOTES 1 & 2), MAXIMUM POWER INPUT KW AT FULL LOAD, MINIMUM EER, MINIMUM IPLV, EVAPORATOR, and VIBRATION ISOLATION.

- 1. CAPACITY BASED ON 95°F AMBIENT TEMPERATURE. 2. PROVIDE LOW AMBIENT OPERATION DOWN TO 30°F. 3. REFER TO THE ELECTRICAL DRAWINGS FOR EQUIPMENT ELECTRICAL CHARACTERISTICS.

BOILER SCHEDULE

Table with columns for NO., TYPE (NOTE 1), OUTPUT, MBH, OPERATING PRESSURE, PSIG, TURNDOWN RATIO, MINIMUM EFFICIENCY, %, HOT WATER, and NOTES.


- 1. TYPE: C CONDENSING - H HOT WATER. 2. PER THE TEST PROCEDURES AND CONDITIONS REQUIRED IN THE NORTH CAROLINA ENERGY CONSERVATION CODE-2018. 3. REFER TO THE ELECTRICAL DRAWINGS FOR THE EQUIPMENT ELECTRICAL CHARACTERISTICS. 4. GAS PRESSURE 4-14" W.G. 5. WATER PRESSURE DROP: 3 PSIG @ 100 GPM.



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Project Grace

Grace Street Wilmington, NC 28401

LS3P PROJECT: 7701-177800

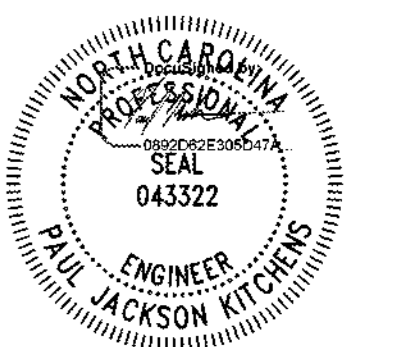Table with columns for DATE and DESCRIPTION, showing 0 2023.05.22 PERMIT SET.

SHEET NAME: HVAC SCHEDULES

ORIG SUBMISSION: 2023.05.22

SHEET: M-501

PERMIT SET

THEME PROGNOSTIC B. QUALITY... E D C B A 1 2 3 4 5 6

FAN SCHEDULE table with columns: NO., AREA SERVED, TYPE (NOTES 1 & 2), CFM, STATIC PRESSURE, IN.WG, MAXIMUM RPM, MOTOR (MINIMUM HP, MAXIMUM BRAKE HP, DRIVE (NOTE 2)), VIBRATION ISOLATION (TYPE, MINIMUM STATIC DEFLECTION, IN., VIBRATION BASE), NOTES.

- NOTES: 1. TYPE: I INLINE AXIAL, A AXIAL. 2. DRIVE: D DIRECT. 3. PROVIDE VARIABLE FREQUENCY DRIVE. 4. REFER TO THE ELECTRICAL DRAWINGS FOR THE EQUIPMENT ELECTRICAL CHARACTERISTICS.

DUCTLESS SPLIT SYSTEM SCHEDULE table with columns: NO., AREA SERVED, TYPE (NOTE 2), INDOOR UNIT NOMINAL CFM (NOTE 3), COOLING (NOTE 4) (SENSIBLE CAPACITY, MBH; TOTAL CAPACITY, MBH; MINIMUM EER), NOTES.

- NOTES: 1. DESIGN CONDITIONS: SUMMER, OUTSIDE 93.7°F DB, 76.3°F WB; MECHANICAL SPACES 80°F DB; ELEVATOR MACHINE ROOMS 80°F DB. 2. TYPE: AC COOLING ONLY. 3. INDOOR UNIT CFM BASED ON MEDIUM FAN SPEED. 4. INTEGRAL CONDENSATE PUMP. 5. REFER TO THE ELECTRICAL DRAWINGS FOR EQUIPMENT ELECTRICAL CHARACTERISTICS. 6. MAXIMUM REFRIGERANT PIPE LENGTH OF 492FT.

AIR CURTAIN SCHEDULE table with columns: NO., AREA SERVED, NORMAL CFM, MINIMUM MOTOR HP, MOUNTING HEIGHT (FT), UNIT WIDTH (FT), NOTES.

- NOTES: 1. REFER TO ELECTRICAL DRAWINGS FOR THE EQUIPMENT ELECTRICAL CHARACTERISTICS. 2. PROVIDE CONTACTOR SWITCH AT EXTERIOR DOOR THAT SHALL ENERGIZE AIR CURTAIN FAN WHEN OPEN.

ELECTRIC FLOOR HEATER SCHEDULE table with columns: NO., TYPE (NOTE 1), MINIMUM ACTIVE LENGTH (FT.), MINIMUM CAPACITY (kW), NOTES.

- NOTES: 1. TYPE: W RECESSED FLOOR HEATER. 2. PROVIDE WITH INTEGRAL DISCONNECT. 3. REFER TO THE ELECTRICAL DRAWINGS FOR THE EQUIPMENT ELECTRICAL CHARACTERISTICS.

ELECTRIC UNIT HEATER SCHEDULE table with columns: NO., AREA SERVED, TYPE (NOTE 1), CAPACITY, kW (NOTE 2), NOMINAL CFM, NOTES.

- NOTES: 1. TYPE: W WALL. 2. BASED ON 60°F EAT. 3. REFER TO THE ELECTRICAL DRAWINGS FOR EQUIPMENT ELECTRICAL CHARACTERISTICS.

HYDRONIC UNIT HEATER SCHEDULE table with columns: NO., AREA SERVED, TYPE (NOTE 1), CAPACITY, MBH (NOTE 2), GPM, NOMINAL CFM, NOTES.

- NOTES: 1. TYPE: CH CEILING HUNG. 2. BASED ON 60°F EAT. 3. REFER TO THE ELECTRICAL DRAWINGS FOR EQUIPMENT ELECTRICAL CHARACTERISTICS.

TERMINAL UNIT SCHEDULE - SUPPLY table with columns: NO., TYPE (NOTE 1), SYSTEM, PRIMARY CFM (COOLING MAXIMUM, MINIMUM, HEATING MAXIMUM), HOT WATER COIL (CAPACITY MBH (NOTE 2), GPM (NOTE 3)), PIPE RUNOUT SIZE, IN., NOTES.

- NOTES: 1. TYPE: VV VARIABLE VOLUME, CV CONSTANT VOLUME, R REHEAT, D DUAL MAX. 2. CAPACITY BASED ON 55°F EAT FOR VV-R UNITS. 3. HOT WATER BASED ON 140°F EWT, 110°F LWT, AND MAXIMUM 3' WPD. 4. SEE SPECIFICATIONS FOR AHRI TESTING/CERTIFICATION REQUIREMENTS AND SUPPLEMENTAL SOUND ATTENUATION REQUIREMENTS. FOR TERMINAL UNITS WHERE THE SOUND POWER LEVEL FIELDS OF THE SCHEDULE ABOVE ARE LEFT BLANK, THE MAXIMUM ALLOWABLE SOUND POWER LEVELS IN dB @ 10 pW, SHALL BE OF THE FOLLOWING LEVELS:


OCTAVE BAND table with columns: Capacity (Casing Radiated, Discharge) for 2, 3, 4 octave bands.

TERMINAL UNIT SCHEDULE - EXHAUST table with columns: NO., TYPE (NOTE 1), PRIMARY CFM, MINIMUM.



CFD Cape Fear Development logo and LSP logo. Address: 101 NORTH THIRD STREET, SUITE 500 WILMINGTON, NORTH CAROLINA 28401. TEL. 910.790.3111 FAX. 910.790.9901 WWW.LSP.COM

NEWCOMB & BOYD logo. Address: 5425 Page Road, Suite 215, Durham, NC 27703. Tel: 919 783 7812. NB Contact: Brandon R. Nevin. N&B PROJECT: 21N185. Newcomb & Boyd, LLP, Firm Lic. # F-0512.

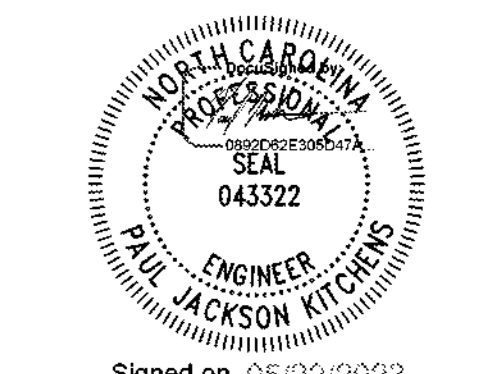

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Project Grace logo. Address: Grace Street, Wilmington, NC 28401. LSP PROJECT: 7701-177800.

Revision table with columns: NO., DATE, DESCRIPTION. Row 0: 2023.05.22 PERMIT SET.

SHEET NAME: HVAC SCHEDULES

ORIG SUBMISSION: 2023.05.22

SHEET: M-502

PERMIT SET

THEME: PERFORMANCE IS EQUALITY  
COURTESY: COMMUNITY PARTNERSHIP

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### SEISMIC AND WIND LOAD DESIGN REQUIREMENTS FOR MECHANICAL SYSTEMS

- A. EQUIPMENT, APPLIANCES AND SUPPORTS (INCLUDING ROOF CURBS AND ROOF RAILS) EXPOSED TO WIND SHALL BE DESIGNED AND INSTALLED TO RESIST THE WIND PRESSURES DETERMINED IN ACCORDANCE WITH THE INTERNATIONAL BUILDING CODE. WHERE SEISMIC RESTRAINT IS REQUIRED, THE MORE DEMANDING FORCE OF WIND AND SEISMIC MUST BE USED. SEE SEISMIC INFORMATION CONTAINED IN THE STRUCTURAL DRAWINGS FOR SITE SPECIFIC INFORMATION ON SEISMIC DESIGN CATEGORY AND ADDITIONAL SUPPORTING INFORMATION.
- B. SEE COMPONENT/SYSTEM SCHEDULE BELOW FOR SPECIFIC COMPONENT IMPORTANCE FACTOR DESIGNATIONS AND SEISMIC DESIGN CRITERIA.
- C. USE SEISMIC DESIGN CATEGORY TABLE BELOW TO DETERMINE SEISMIC RESTRAINT REQUIREMENTS FOR EACH COMPONENT/SYSTEM.
- D. FOR ALL COMPONENTS/SYSTEMS REQUIRING SEISMIC AND/OR WIND RESTRAINT, THE COMPONENT SUPPORTS AND ATTACHMENTS SHALL BE DESIGNED (CALCULATIONS AND INSTALLATION DETAILS) AND STAMPED BY A REGISTERED PROFESSIONAL ENGINEER (SEISMIC AND/OR STRUCTURAL ENGINEER) WITH AT LEAST FIVE YEARS OF SEISMIC DESIGN EXPERIENCE, LICENSED IN THE STATE OF THE JOB LOCATION. ALL RESTRAINING DEVICES SHALL HAVE A PREAPPROVAL NUMBER FROM CALIFORNIA OSHPD OR SOME OTHER RECOGNIZED GOVERNMENT AGENCY SHOWING MAXIMUM RESTRAINT RATINGS.
- E. WHERE SEISMIC RESTRAINT IS REQUIRED, FOUNDATION PADS NEEDED FOR INSTALLATION OF EQUIPMENT UNDER THIS CONTRACT MUST BE DESIGNED AND STAMPED BY THE SEISMIC ENGINEER. DO NOT POUR ANY FOUNDATION PADS PRIOR TO THE RECEIPT OF AN APPROVED SEISMIC SUBMITTAL FROM THE ENGINEER OF RECORD. ALL FOUNDATION PADS DESIGNED AS EXPANSIONS TO EXISTING PADS OR INSTALLED ON TOP OF EXISTING CONCRETE FLOOR SYSTEMS SHALL BE DOVELEDED INTO THE EXISTING SYSTEMS.
- F. SEISMIC RESTRAINTS FOR DUCTWORK AND PIPING MUST BE SHOWN ON LAYOUT DRAWINGS SHOWING SPECIFIC RESTRAINT LOCATIONS ALONG WITH ACCOMPANYING DETAILS AND CALCULATIONS PER THE SEISMIC ENGINEER.
- G. AFTER INSTALLATION, MANUFACTURER'S TRAINED REPRESENTATIVE SHALL VERIFY THAT SEISMIC AND WIND RESTRAINTS ARE INSTALLED AND OPERATING PROPERLY AND SHALL SUBMIT A CERTIFICATE SO STATING.
- H. REFER TO ASCE 7-10 FOR SEISMIC INSTALLATION GUIDELINES.
- J. CABLE RESTRAINTS SHALL BE INSTALLED SLIGHTLY SLACK SUCH THAT THEY DO NOT SHORT CIRCUIT VIBRATION ISOLATORS DURING NORMAL OPERATION. SOLID, BRACKET SWAY BRACES SHOULD BE AVOIDED UNLESS PROPERLY COORDINATED WITH VIBRATION ISOLATORS TO AVOID SHORT CIRCUITING.

#### COMPONENT/SYSTEM IMPORTANCE FACTOR (I<sub>p</sub>) SCHEDULE AND SEISMIC DESIGN INFORMATION

|                      |   |
|----------------------|---|
| I <sub>p</sub> = 1.0 | [ALL SYSTEMS] [AND COMPONENTS UNLESS NOTED OTHERWISE]                         |
| I <sub>p</sub> = 1.5 | SYSTEMS AND COMPONENTS AS DESCRIBED IN THE ASCE 7 EDITION REQUIRED BY THE AHJ |

#### SEISMIC DESIGN INFORMATION:

- 1. SITE CLASSIFICATION = D
- 2. RISK CATEGORY = III
- 3. SEISMIC DESIGN CATEGORY = B
- 4. SHORT PERIOD DESIGN SPECTRAL ACCELERATION (SD1) = 0.11
- 5. LONG PERIOD DESIGN SPECTRAL ACCELERATION (SDS) = 0.167

### AIR DISTRIBUTION SCHEDULE

#### PRODUCT SPECIFICATIONS:

- 1. ACTION SUBMITTALS - PRODUCT DATA: FOR EACH TYPE OF PRODUCT.
  - a. DATA SHEET: INDICATE MATERIALS OF CONSTRUCTION, FINISH, AND MOUNTING DETAILS; AND PERFORMANCE DATA INCLUDING THROW AND DROP, STATIC-PRESSURE DROP, AND NOISE RATINGS.
- 2. SELECTION OF GRILLES, REGISTERS AND DIFFUSERS SHALL BE BASED ON AIR INTRODUCED AT A 20°F TEMPERATURE DIFFERENTIAL.
- 3. GRILLES AND REGISTERS WITH BORDERS SHALL HAVE FELT OR RUBBER GASKETS CEMENTED TO THE BACK FACE AND HOLDING SCREWS NOT OVER 18" ON CENTER AROUND THE PERIMETER.
- 4. WALL-MOUNTED GRILLES AND REGISTERS LOCATED LESS THAN 7' ABOVE FINISHED FLOOR SHALL BE HEAVY DUTY, IMPACT-RESISTANT TYPE.
- 5. DIFFUSERS IN LAY-IN CEILINGS SHALL LAY IN A NOMINAL 24" X 24" GRID OPENING AND SHALL BE FURNISHED WITHOUT EXPOSED FLANGES.
- 6. INTERNAL PARTS OF DIFFUSERS SHALL BE DESIGNED SO THEY CAN BE ADJUSTED, REMOVED, AND ASSEMBLED WITHOUT SPECIAL TOOLS.
- 7. DIFFUSERS SHALL HAVE ROUND NECKS OR SHALL BE PROVIDED WITH SQUARE-TO-ROUND COLLARS WHERE CONNECTED TO ROUND OR FLEXIBLE DUCT.
- 8. FINISHES, UNLESS OTHERWISE SPECIFIED HEREIN:
  - a. ALUMINUM DIFFUSERS, GRILLES, AND REGISTERS: WHITE BAKED ENAMEL.
  - b. DIFFUSER FACES AND FRAMES: BAKED ENAMEL, COLOR SELECTED BY ARCHITECT.
  - c. DIFFUSERS INTERIOR: SAME AS FACE AND FRAME.
  - e. T-BAR SLOT DIFFUSERS: BAKED ENAMEL, COLOR SELECTED BY ARCHITECT. INTERIOR - FLAT BLACK.
- 9. GRILLES, REGISTERS AND DIFFUSERS SHALL BE PROVIDED WITH FRAMES, BORDERS, AND MOUNTING ATTACHMENTS FOR INSTALLATION IN THE ACTUAL WALL, SOFFIT, AND CEILING CONSTRUCTION IN WHICH INSTALLED.
- 10. WALL RETURN AND RELIEF GRILLES INSTALLED ABOVE EYE LEVEL SHALL BE INSTALLED WITH BLADES ANGLED SO THE INSIDE OF THE DUCT OR THE ADJACENT SPACE WILL NOT BE VISIBLE THROUGH THE GRILLES.
- 11. EXAMINATION
  - a. EXAMINE AREAS WHERE DIFFUSERS ARE INSTALLED FOR COMPLIANCE WITH REQUIREMENTS FOR INSTALLATION TOLERANCES AND OTHER CONDITIONS AFFECTING PERFORMANCE OF EQUIPMENT.
  - b. PROCEED WITH INSTALLATION ONLY AFTER UNSATISFACTORY CONDITIONS HAVE BEEN CORRECTED.
- 12. INSTALLATION
  - a. INSTALL DIFFUSERS LEVEL AND PLUMB.
  - b. OUTLETS AND INLETS: DRAWINGS INDICATE GENERAL ARRANGEMENT OF DUCTS, FITTINGS, AND ACCESSORIES. AIR OUTLET AND INLET LOCATIONS HAVE BEEN INDICATED TO ACHIEVE DESIGN REQUIREMENTS FOR AIR VOLUME, NOISE CRITERIA, AIRFLOW PATTERN, THROW, AND PRESSURE DROP. MAKE FINAL LOCATIONS WHERE INDICATED, AS MUCH AS PRACTICAL. FOR UNITS INSTALLED IN LAY-IN CEILING PANELS, LOCATE UNITS IN THE CENTER OF PANEL. WHERE ARCHITECTURAL FEATURES OR OTHER ITEMS CONFLICT WITH INSTALLATION, NOTIFY ARCHITECT AND ENGINEER. FOR A DETERMINATION OF FINAL LOCATION.
  - c. INSTALL DIFFUSERS WITH AIRTIGHT CONNECTIONS TO DUCTS AND TO ALLOW SERVICE AND MAINTENANCE OF DAMPERS, AIR EXTRACTORS, AND FIRE DAMPERS.
  - d. INSTALL REGISTERS AND GRILLES WITH AIRTIGHT CONNECTIONS TO DUCTS AND TO ALLOW SERVICE AND MAINTENANCE OF DAMPERS, AIR EXTRACTORS, AND FIRE DAMPERS.
- 13. AFTER INSTALLATION, ADJUST DIFFUSERS TO AIR PATTERNS INDICATED, OR AS DIRECTED, BEFORE STARTING AIR BALANCING.

| TYPE   | CHARACTERISTICS            |             |            |                          |       | MANUFACTURER | DESCRIPTION  |
|--------|----------------------------|-------------|------------|--------------------------|-------|--------------|--|
| S-PF   | SIZE<br>24"X24"<br>12"X12" | ---         | ---        | ---                      | ---   | NOTE 1       | SQUARE PLATE FACE DIFFUSER TYPE WITH SINGLE SQUARE AIR DIFFUSION PANEL. DIFFUSERS SHALL HAVE AN 18" X 18" ALUMINUM FACE PANEL MOUNTED ON AN AERODYNAMICALLY SHAPED, ONE-PIECE, SEAMLESS 24" X 24" BACKPAN. EXPOSED SURFACES OF FACE PANELS SHALL BE SMOOTH, FLAT, AND FREE OF VISIBLE FASTENERS.   |
| S-LF   | ---                        | ---         | ---        | ---                      | ---   | NOTE 1       | SQUARE LOUVERED FACE DIFFUSER TYPE, 24" X 24" FACE, WITH MITERED CORNERS, AND HORIZONTAL/VERTICAL PATTERN ADJUSTMENT DEVICE. ALUMINUM CONSTRUCTION.  |
| S-SG   | ---                        | ---         | ---        | ---                      | ---   | NOTE 1       | SIDEWALL SUPPLY GRILLE, DOUBLE-DEFLECTION TYPE WITH VERTICAL FRONT BLADES AND HORIZONTAL REAR BLADES. ALUMINUM CONSTRUCTION.   |
| S-LB   | BAR THICKNESS ON CENTER    | BAR SPACING | DEFLECTION | MEMBER SPACING ON CENTER | WIDTH | NOTE 1       | LINEAR BAR DIFFUSER, EXTRUDED ALUMINUM, CONTINUOUS MULTIPLE-BAR FOR FLOOR INSTALLATION. WHERE INDICATED ON THE DRAWINGS, BARS SHALL BE 0.25" THICK, 15" DEFLECTION, 0.25" ON CENTER; SUPPORT MEMBERS SHALL NOT EXCEED 18" ON CENTER AND WIDTH SHALL BE 10". DIFFUSERS SHALL BE CONTINUOUS WHERE INDICATED ON THE DRAWINGS. PROVIDE BLANK-OFF SECTIONS, MITERED CORNERS, AND VERTICAL PATTERN CONTROL DAMPERS. FINISH AS DIRECTED BY ARCHITECT. |
| S-LB-1 | 0.250"                     | 0.50"       | 15"        | 9"                       | 10"   |              |  |
| S-LB-2 | 0.250"                     | 0.50"       | 15"        | 9"                       | 10"   |              |  |
| S-LD   | NUMBER OF SLOTS            | SLOT WIDTH  | ---        | ---                      | ---   | NOTE 1       | LINEAR DIFFUSER, EXTRUDED ALUMINUM TYPE, WITH 1" WIDE SLOTS WITH INTEGRAL VOLUME CONTROL AND PATTERN ADJUSTMENT AND CONCEALED MOUNTING FRAME. FINISH IN BAKED ENAMEL WITH WHITE FACE, AND INTERIOR COMPONENTS VISIBLE AFTER INSTALLATION FINISHED FLAT BLACK.  |
| S-LD-1 | 2                          | 0.5"        |            |                          |       |              |  |
| R-LG   | ---                        | ---         | ---        | ---                      | ---   | NOTE 1       | LINEAR RETURN GRILLE, EXTRUDED ALUMINUM 1" SLOT TYPE WITH CONCEALED MOUNTING FRAME, FINISH IN BAKED ENAMEL WITH WHITE FACE AND INTERIOR COMPONENTS VISIBLE AFTER INTALLATION, FINISHED WITH COLOR SELECTED BY ARCHITECT.   |
| R-RP   | ---                        | ---         | ---        | ---                      | ---   | NOTE 1       | PERFORATED PLATE GRILLE. ALUMINUM CONSTRUCTION.  |
| R-SG   | ---                        | ---         | ---        | ---                      | ---   | NOTE 1       | SIDEWALL GRILLE, SINGLE-DEFLECTION, 35° FIXED POSITION, 0.5" ON CENTER, HORIZONTAL BLADES. ALUMINUM CONSTRUCTION.  |
| E-PP   | ---                        | ---         | ---        | ---                      | ---   | NOTE 1       | PERFORATED PLATE GRILLE. ALUMINUM CONSTRUCTION.  |

#### NOTES:

- 1. MANUFACTURER: NAILOR, E.H. PRICE, OR TITUS.




**CFD**  
Cape Fear Development

**LS3P**

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**Project Grace**

Grace Street  
Wilmington, NC 28401

LS3P PROJECT: 7701-177800
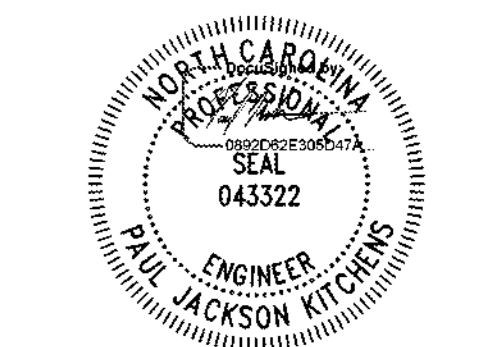
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HVAC SCHEDULES

ORIG SUBMISSION: 2023.05.22

SHEET: **M-503**

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THESE DIMENSIONS & QUANTITIES SHALL BE MAINTAINED UNLESS OTHERWISE NOTED


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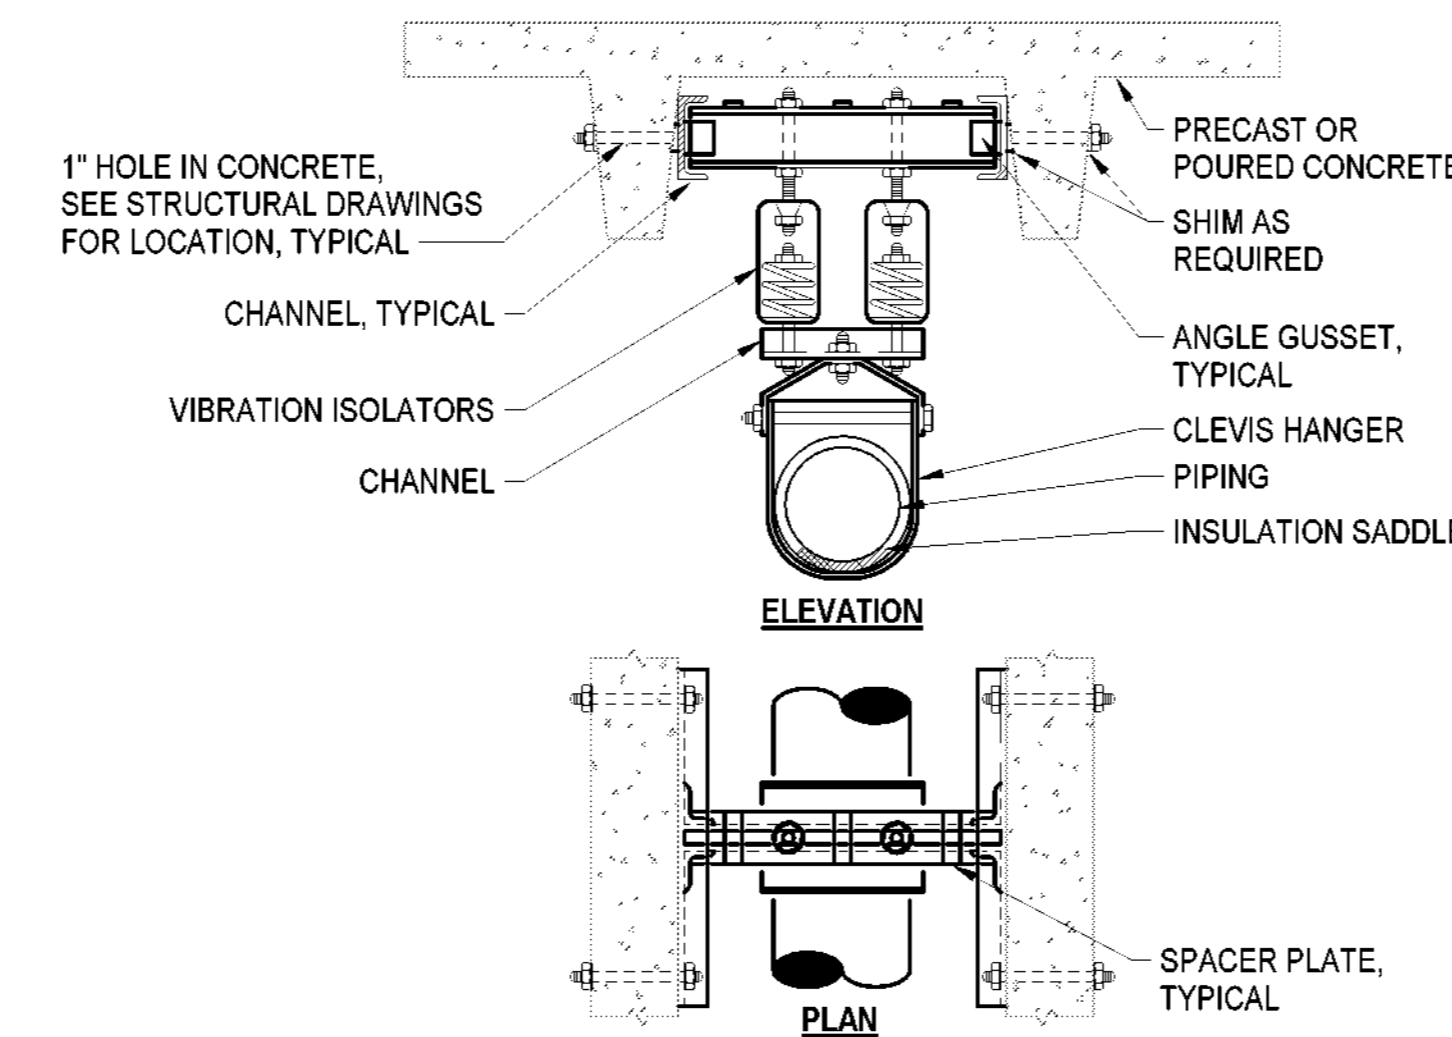
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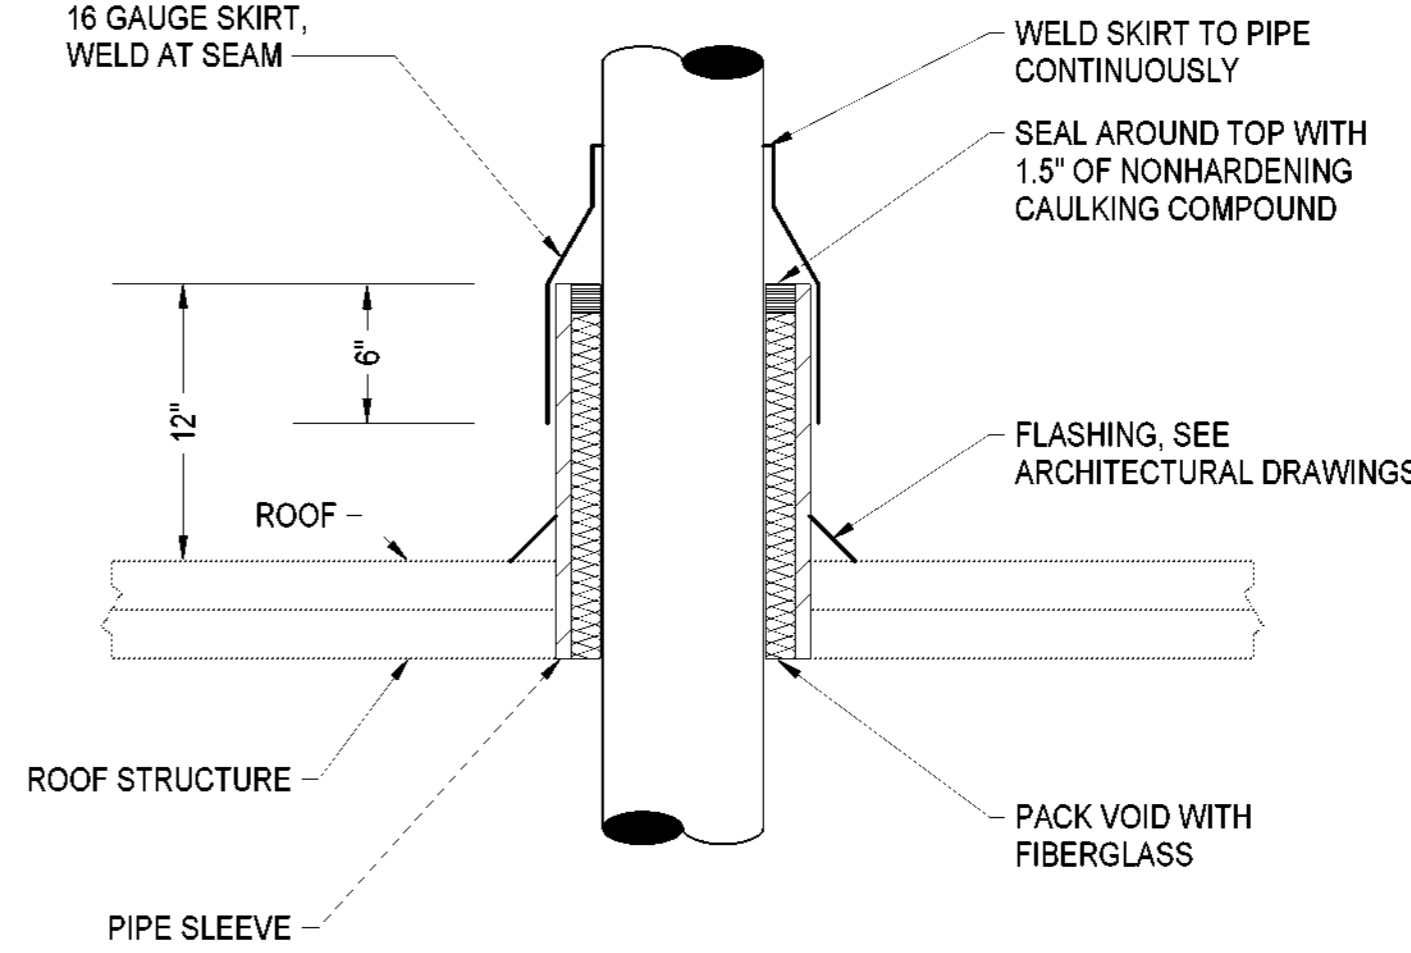
- NOTES:
1. PIPING SHALL BE FULL SIZE OF DRAIN CONNECTION.
  2. EXTEND DRAIN PIPING AS INDICATED ON THE DRAWINGS OR TO THE NEAREST ROOF RECEPTOR ADJACENT TO EQUIPMENT.
  3. WHERE SUPPORTED, ISOLATE DRAIN PIPING FROM CLAMPS WITH TYPE PI ISOLATORS.

**1 CONDENSATE DRAIN FOR DRAW THROUGH COOLING COILS**  
NO SCALE




- NOTES:
1. SIZE STRUCTURAL MEMBERS FOR THE LOAD TO BE SUPPORTED, WITH A MINIMUM 2:1 SAFETY FACTOR.
  2. PAINT ENTIRE ASSEMBLY AS SPECIFIED.
  3. ANGLE AND PLATE CONNECTIONS SHALL BE MADE WITH CONTINUOUS WELDS.
  4. SEE SPECIFICATIONS FOR VIBRATION ISOLATION REQUIREMENTS.

**2 PIPING SUPPORTS**  
NO SCALE

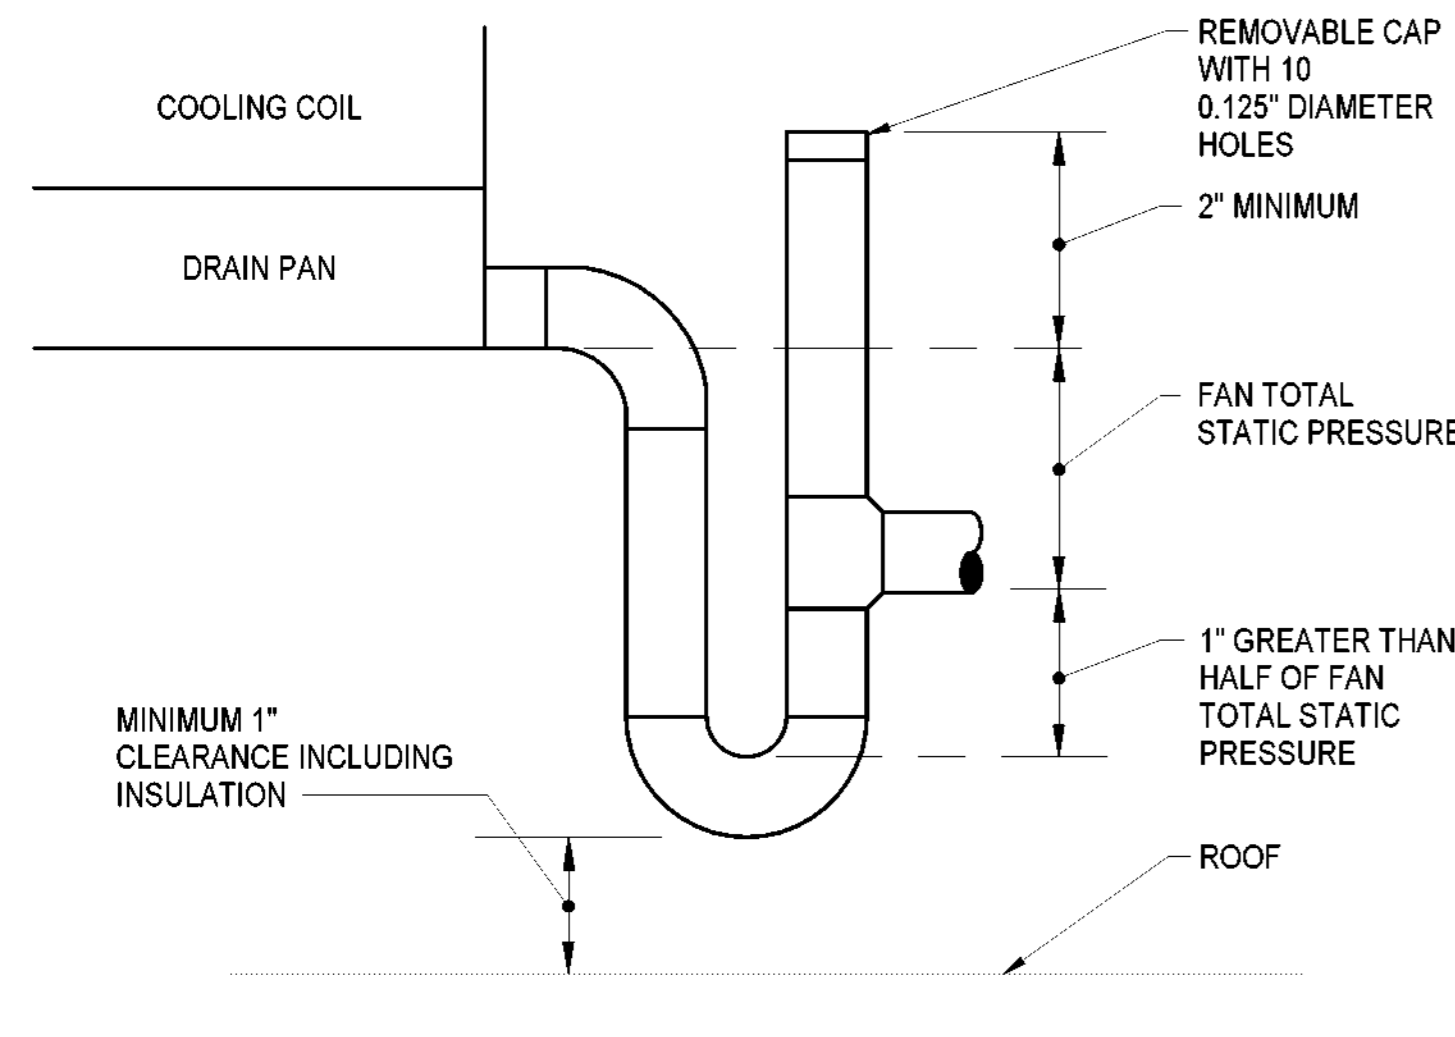


**3 PIPING ROOF PENETRATIONS**  
NO SCALE

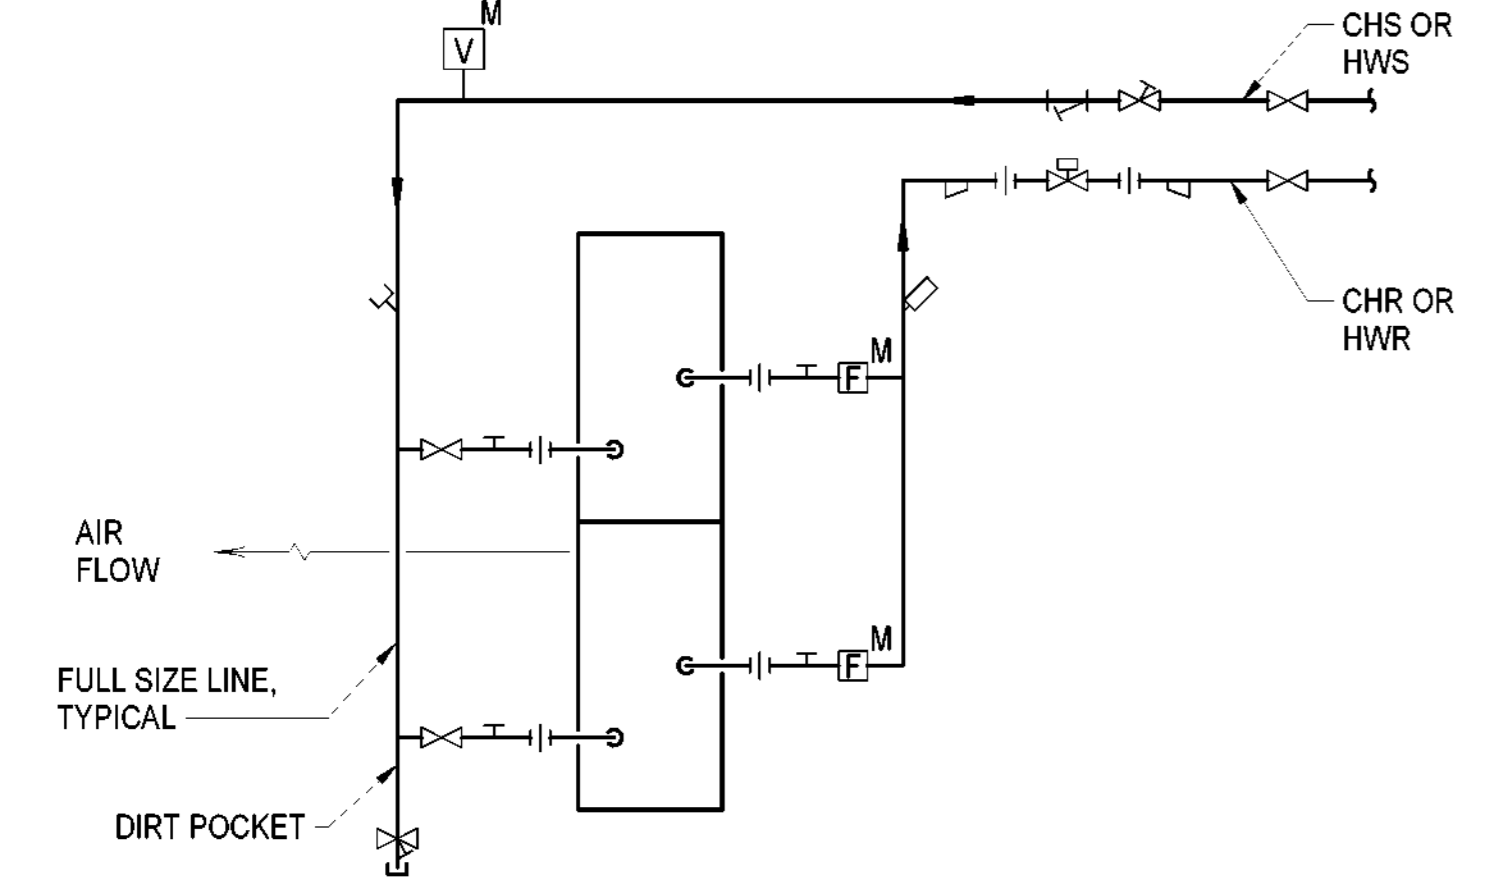


- NOTES:
1. COIL CONNECTIONS SHALL BE ARRANGED TO ACCOMMODATE COIL PULL AND TO ISOLATE COIL PIPING FROM SYSTEM.
  2. PROVIDE MEANS OF DRAINING AND VENTING EACH COIL.
  3. DELETE INDIVIDUAL COIL ISOLATION VALVES IN SINGLE COIL APPLICATIONS.


**4 WATER COILS WITH 2-WAY VALVES IN AHUs**  
NO SCALE

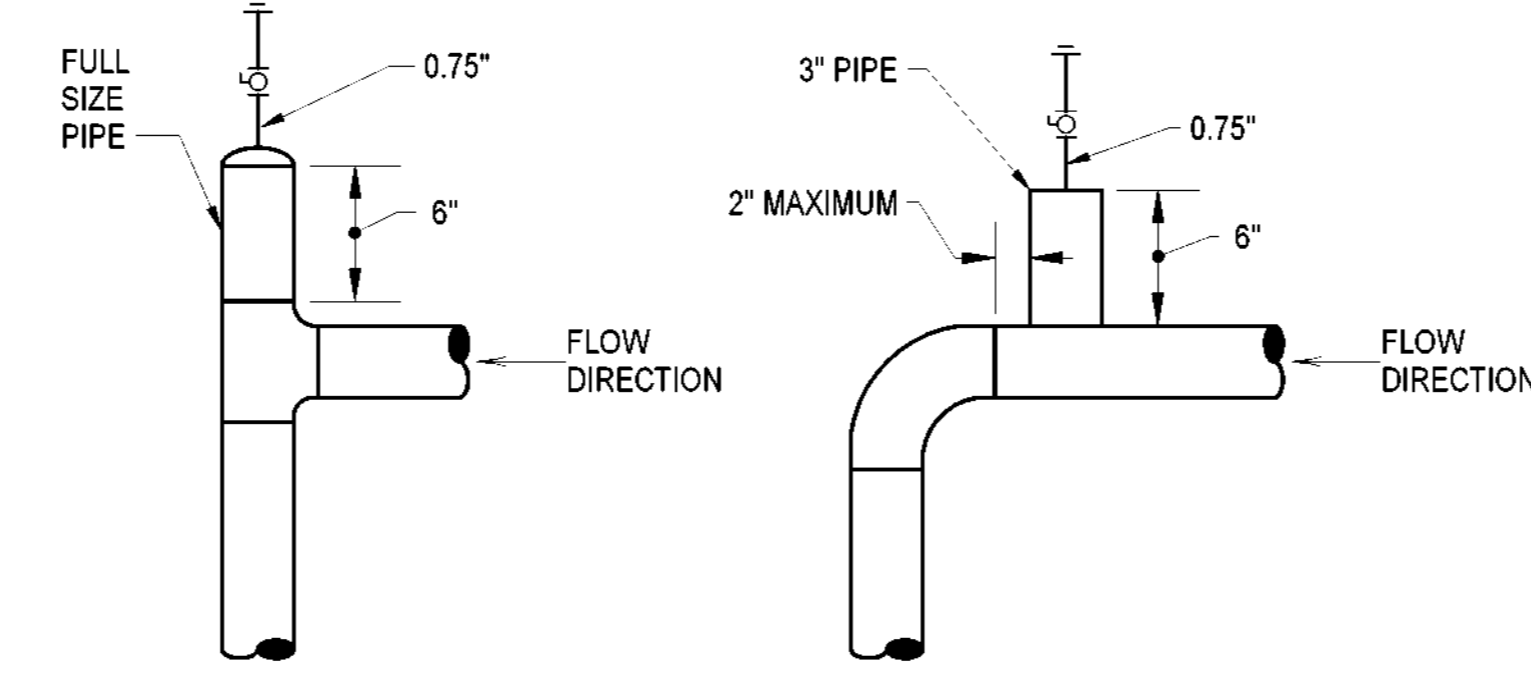

**5 MANUAL AIR VENTS**  
NO SCALE

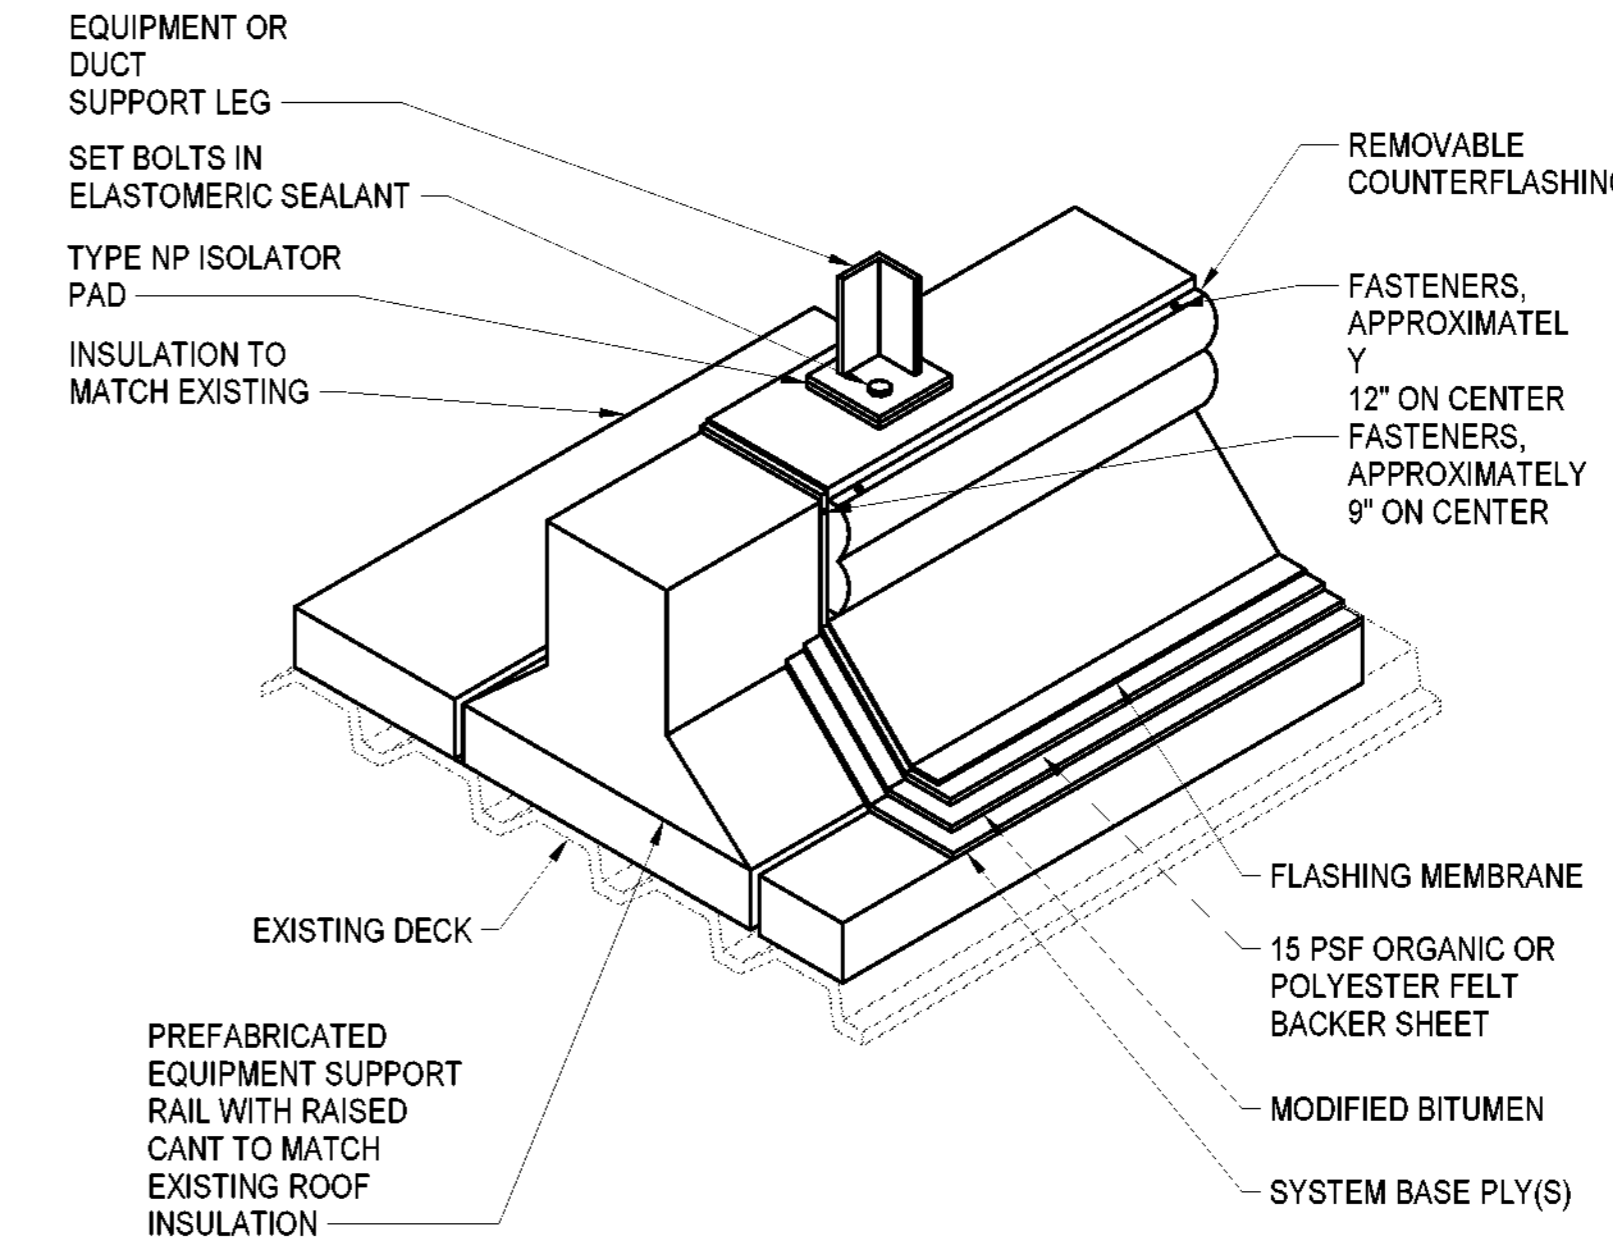


**6 EQUIPMENT SUPPORT RAILS**  
NO SCALE

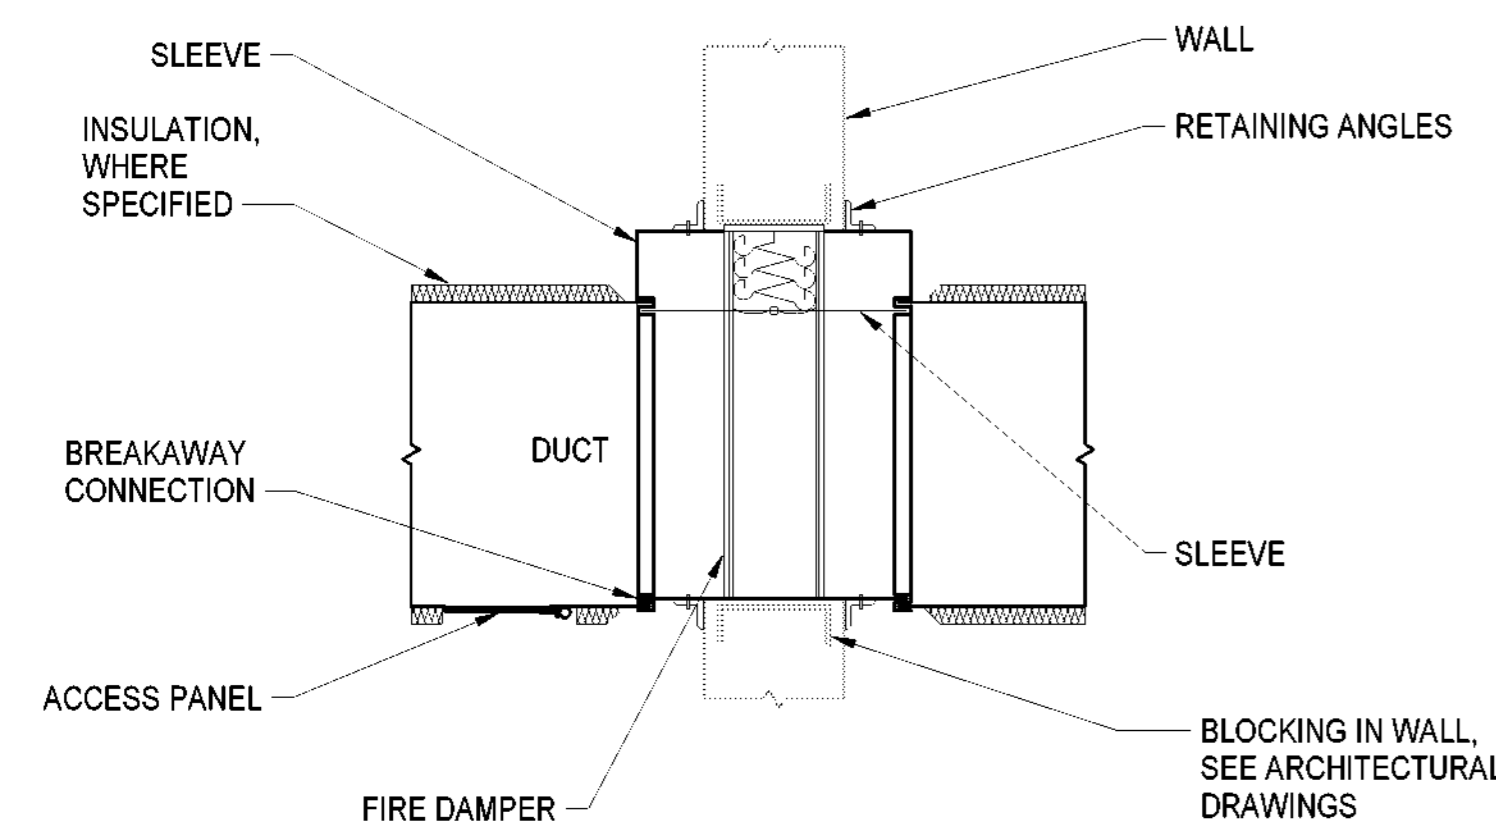


- NOTES:
1. INSTALL DAMPERS IN ACCORDANCE WITH MANUFACTURER'S REQUIREMENTS.
  2. TAPE INSULATION TO DUCT AT BREAKAWAY CONNECTIONS. BREAKAWAY CONNECTIONS AND RETAINING ANGLES SHALL BE VISIBLE.
  3. TYPE B FIRE DAMPER SHOWN. DO NOT FURNISH TYPE A AND TYPE C DAMPERS.
  4. INSTALLATION SIMILAR FOR COMBINATION FIRE/SMOKE DAMPERS.
  5. SEAL BREAKAWAY CONNECTIONS.
  6. LOCATE ACCESS PANEL ON SIDE OF WALL WITH NO CEILING, OR OVER CORRIDOR CEILING, WHERE APPLICABLE.

**7 DUCT WALL PENETRATIONS WITH FIRE DAMPER**  
NO SCALE

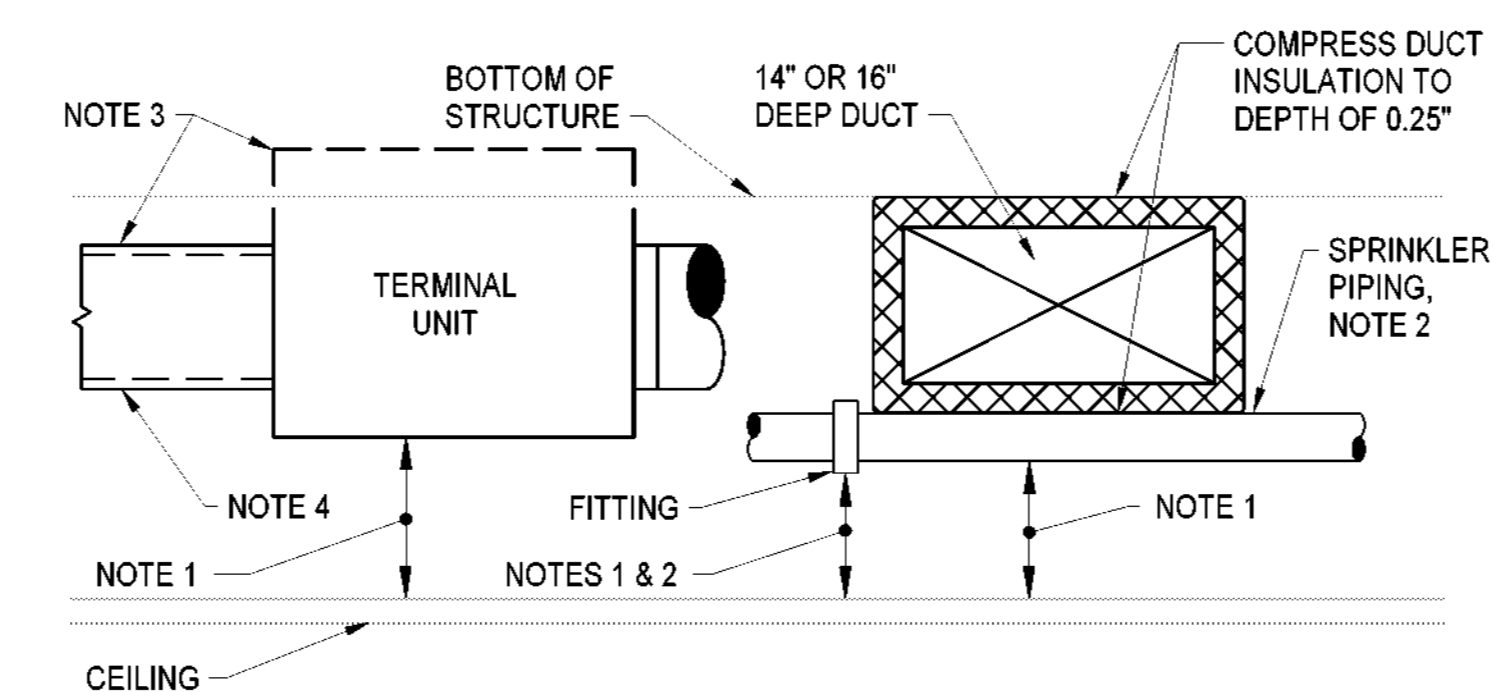

- NOTES:
1. MAINTAIN MINIMUM 7" HIGH CLEARANCE FROM BOTTOM OF CEILING FOR LUMINAIRES.
  2. DO NOT LOCATE SPRINKLER PIPE FITTINGS UNDER DUCTWORK. DUCTWORK FLANGES OR TERMINAL UNITS UNLESS 7" CLEARANCE CAN BE MAINTAINED.
  3. OFFSET TERMINAL UNITS AND CONNECTING DUCTWORK UP INTO STRUCTURE OR BETWEEN JOISTS TO MAINTAIN 7" CLEARANCE WHERE UNITS HAVE A DEPTH GREATER THAN 16".
  4. OFFSET DUCTWORK AND RUNOUTS TO PASS BETWEEN LUMINAIRES TALLER THAN 6.75".
  5. OFFSET PIPING, DUCTWORK AND EQUIPMENT TO ACCOMMODATE CEILING COVES AND FRAMING.

**8 DUCTWORK INSTALLATION AND COORDINATION**  
NO SCALE

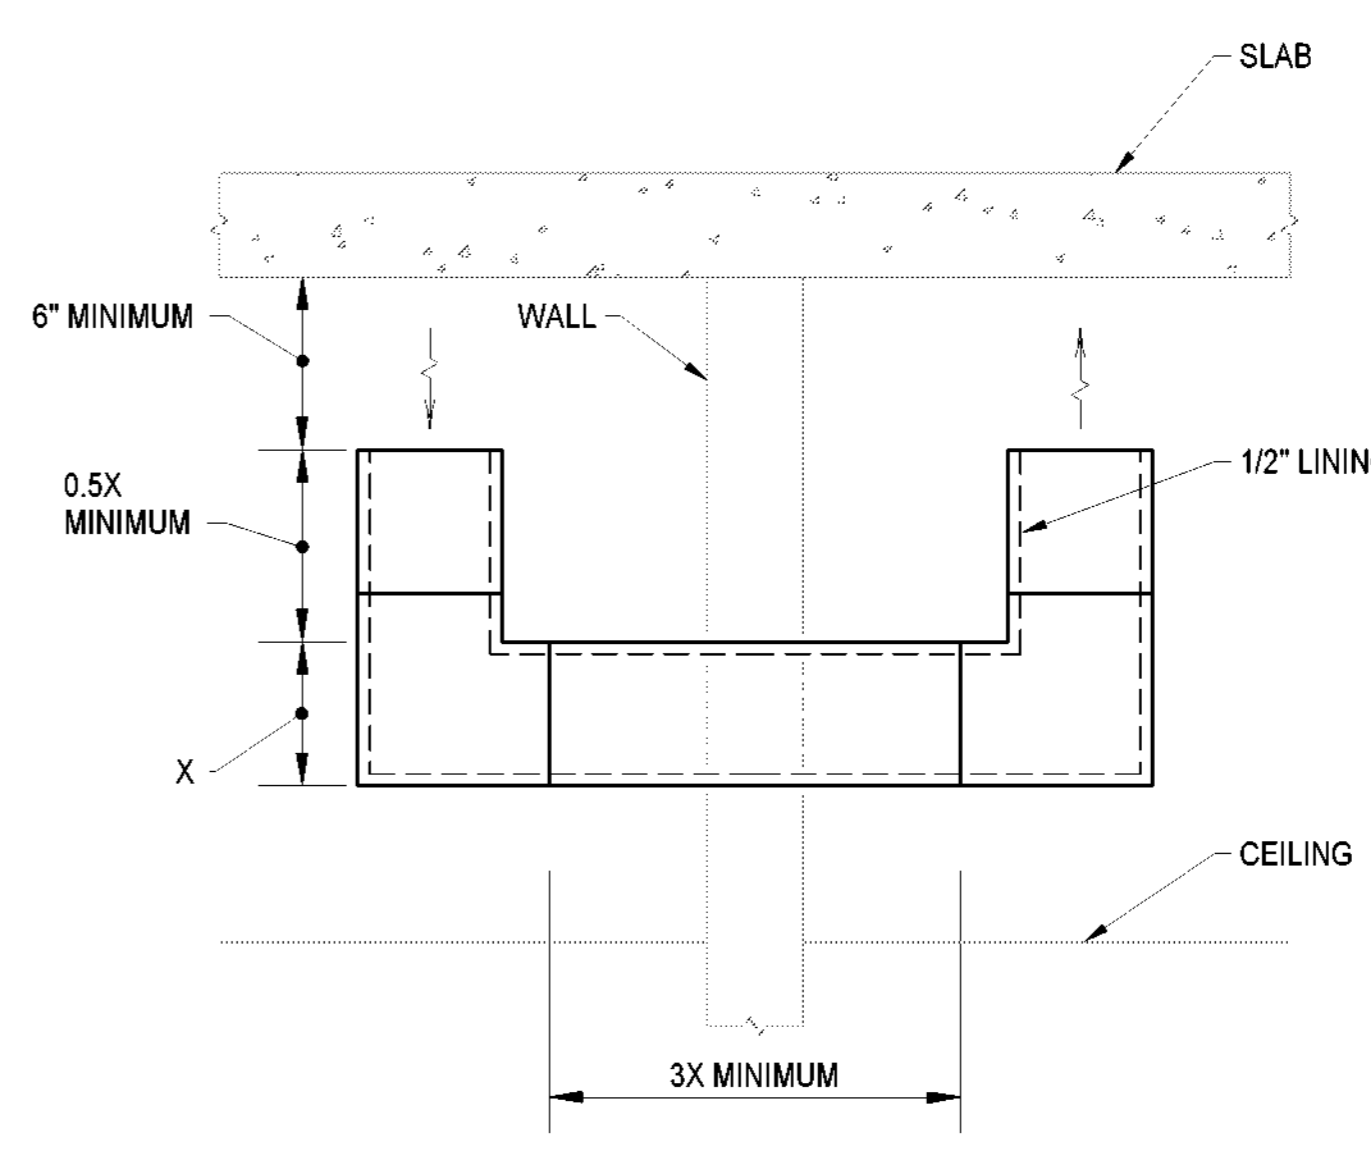

- NOTES:
1. SEAL WALL PENETRATION AIRTIGHT.
  2. DUCTS SHALL BE MINIMUM 22 GAUGE SHEET METAL.
  3. SEE FLOOR PLANS FOR DUCT SIZES. DUCT SIZE ON PLAN REFERS TO FREE SPACE.
  4. 8x6 UNLESS SHOWN OTHERWISE

**9 TRANSFER DUCTS**  
NO SCALE




**CFD**  
Cape Fear Development

**LS3P**

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**Project Grace**

Grace Street  
Wilmington, NC 28401

LS3P PROJECT: 7701-177800
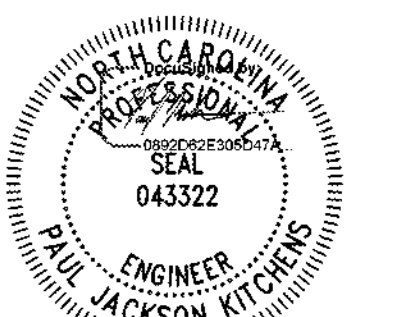
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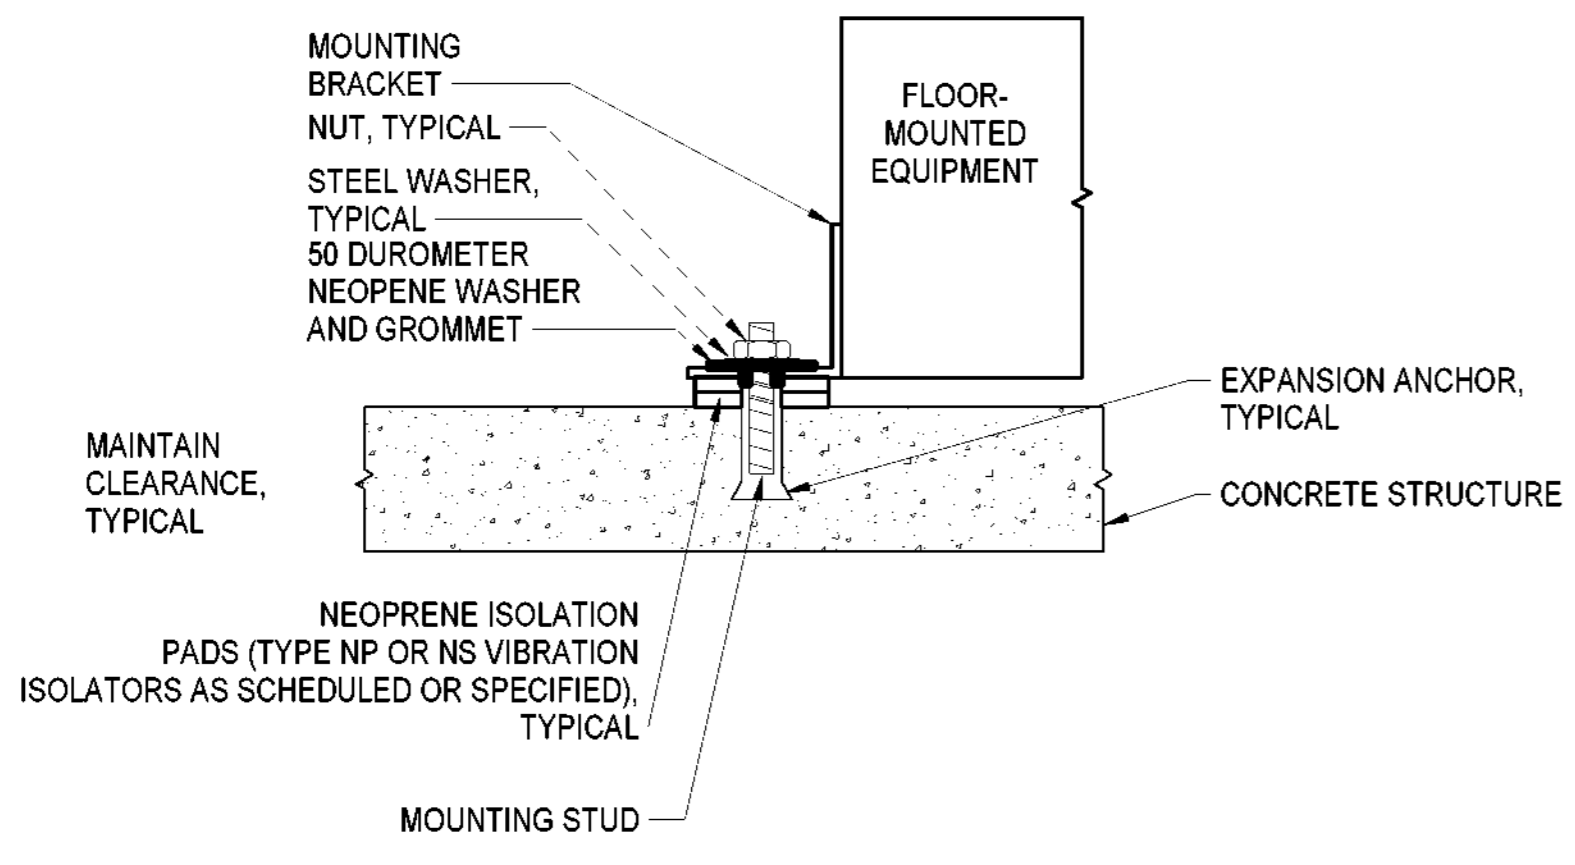
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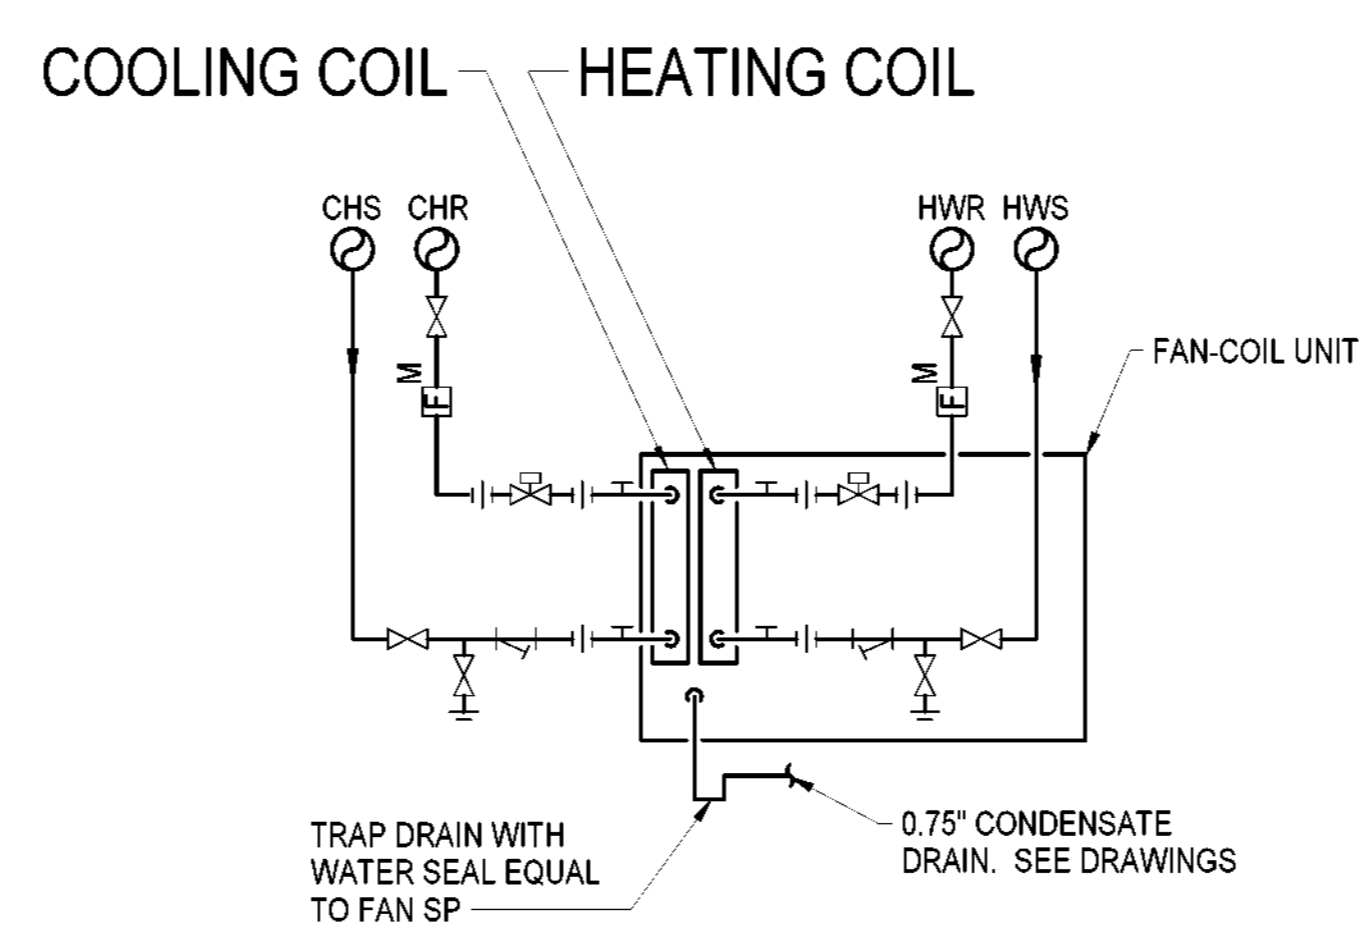
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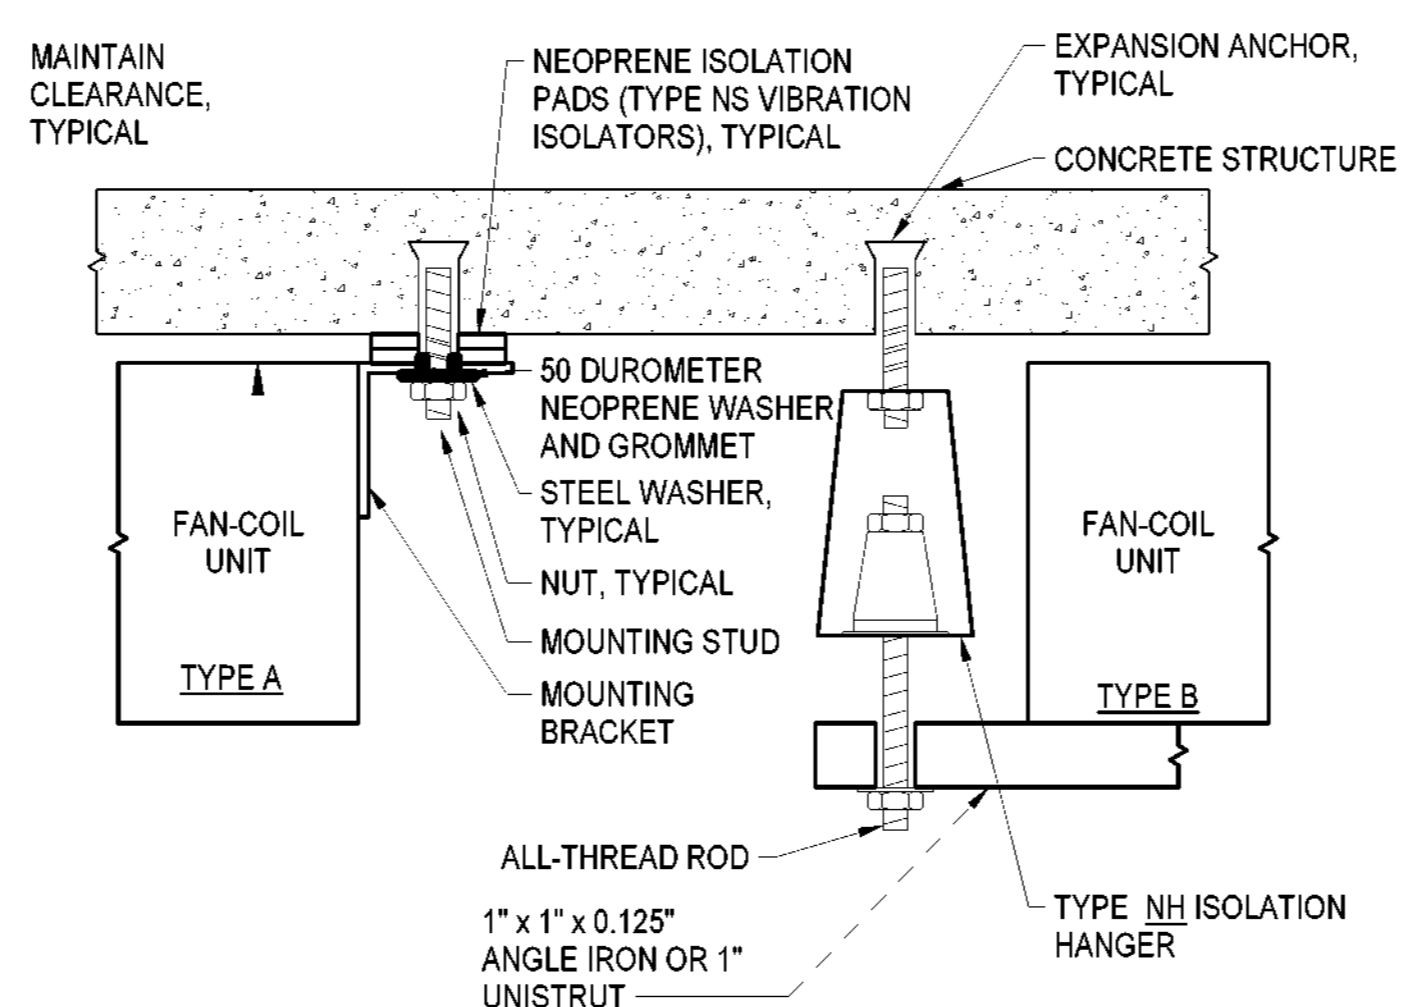
**1 FLOOR MOUNTED EQUIPMENT WITH VIBRATION ISOLATION**  
 NO SCALE

NOTES:  
 1. MOUNTING STUDS AND ALL-THREAD RODS SHALL BE MINIMUM 0.25" DIAMETER.




**2 FAN-COIL UNIT WATER COILS**  
 NO SCALE

NOTES:  
 1. FACTORY-INSTALLED WATER CONTROL PACKAGES ARE ACCEPTABLE. ALL COMPONENTS SHALL MEET THE SPECIFICATION REQUIREMENTS.  
 2. PROVIDE SWING JOINTS AT HOT WATER SUPPLY AND RETURN CONNECTIONS TO MAINS WHERE COIL RUNOUTS ARE LESS THAN 5'-0" LONG.




**4 FAN COIL UNIT MOUNTINGS WITH VIBRATION ISOLATION**  
 NO SCALE

NOTES:  
 1. TYPE B MOUNTING ARRANGEMENT SHALL BE USED EXCEPT WHERE SPACE CONSTRAINTS REQUIRE TYPE A MOUNTING.  
 2. MOUNTING STUDS AND ALL-THREAD RODS SHALL BE MINIMUM 0.25" DIAMETER.

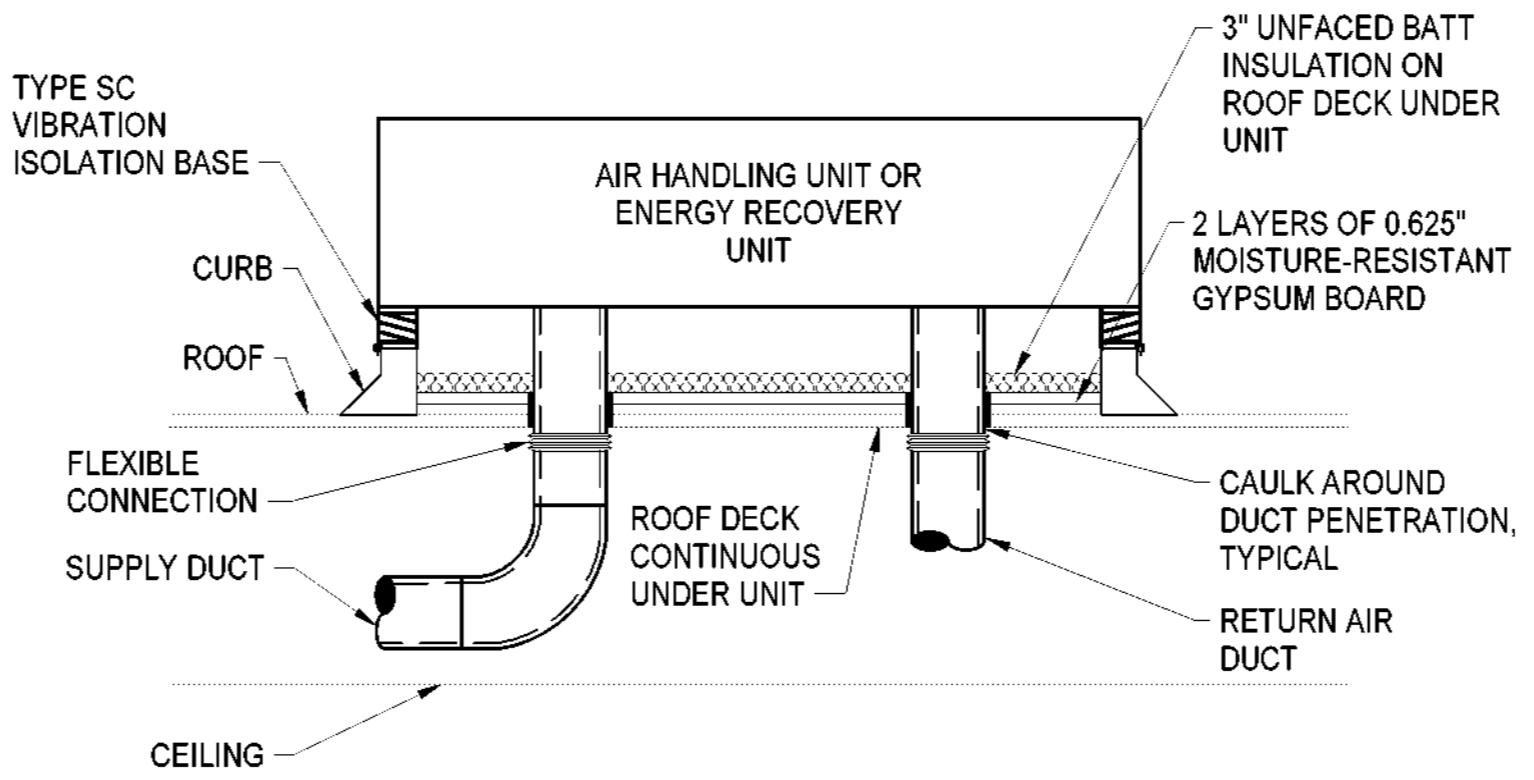

**6 OUTDOOR AIR HANDLING UNITS**  
 NO SCALE

NOTES:  
 1. SEE DETAIL FOR CONDENSATE DRAIN PIPING.  
 2. GYPSUM BOARD JOINTS SHALL BE STAGGERED AND TAPED AND SEALED.

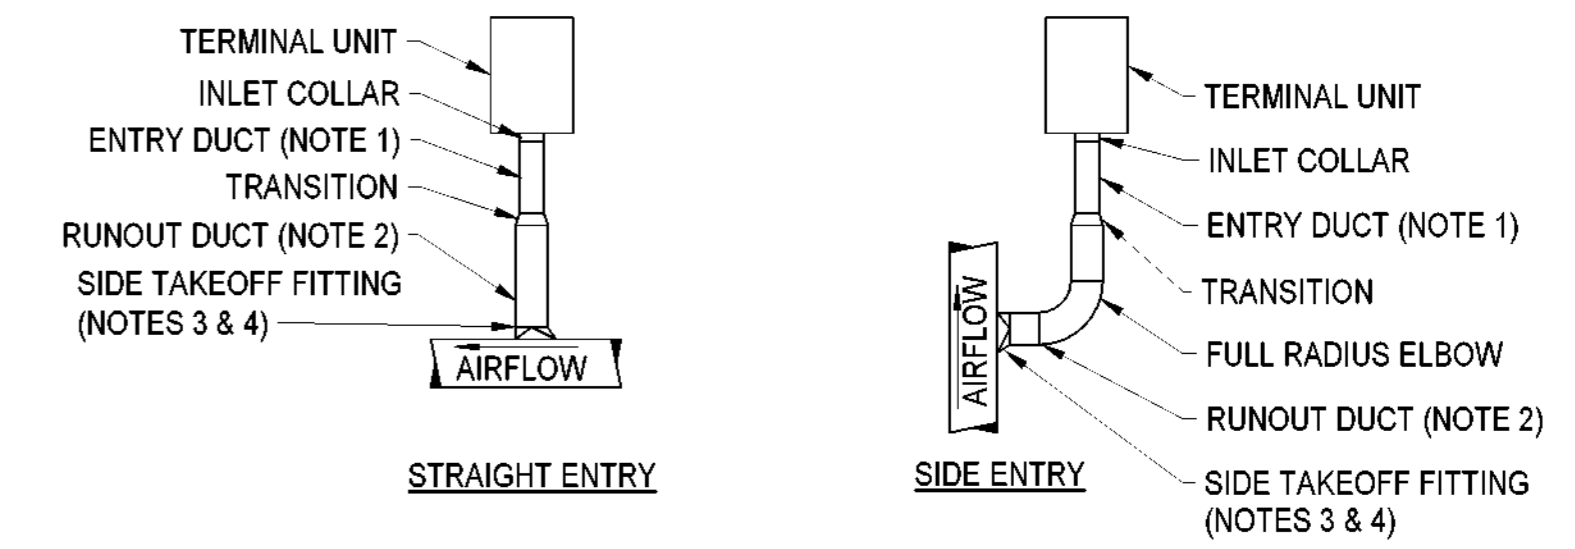


NOTES:  
 1. ENTRY DUCT SHALL MATCH INLET COLLAR SIZE, BE INDEPENDENTLY SUPPORTED FROM THE TERMINAL UNIT, AND HAVE A TOTAL LENGTH THAT IS 3 TIMES THE DIAMETER OR WIDTH OF THE INLET COLLAR SIZE.  
 2. THE RUNOUT FROM THE PRIMARY DUCT TO THE ENTRY DUCT, INCLUDING THE FLEXIBLE DUCT, SHALL BE SIZED AS FOLLOWS UNLESS NOTED OTHERWISE ON THE DRAWINGS.

| INLET COLLAR AND ENTRY DUCT SIZES | RUNOUT FROM PRIMARY TO ENTRY DUCT |
|-----------------------------------|-----------------------------------|
| 4"                                | 8"                                |
| 5"                                | 8"                                |
| 6"                                | 10"                               |
| 7"                                | 12"                               |
| 8"                                | 12"                               |
| 9"                                | 14"                               |
| 10"                               | 14"                               |
| 12"                               | 16"                               |
| 14"                               | 18"                               |
| 16"                               | 20"                               |
| 24"x16"                           | AS INDICATED ON PLANS             |


3. FOR ROUND TAKEOFF CONNECTIONS TO ROUND OR FLAT OVAL PRIMARY SUPPLY DUCTS, PROVIDE A CONICAL TAP IN LIEU OF A SIDE TAKEOFF FITTING.  
 4. FOR AIR HANDLING SYSTEMS WHERE THE PRIMARY SUPPLY DUCT DISTRIBUTION IS PROVIDE A CONICAL TAP IN LIEU OF A SIDE TAKEOFF FITTING. FITTINGS SHALL BE CONCENTRIC TYPE.

**3 TERMINAL UNIT INLET**  
 NO SCALE

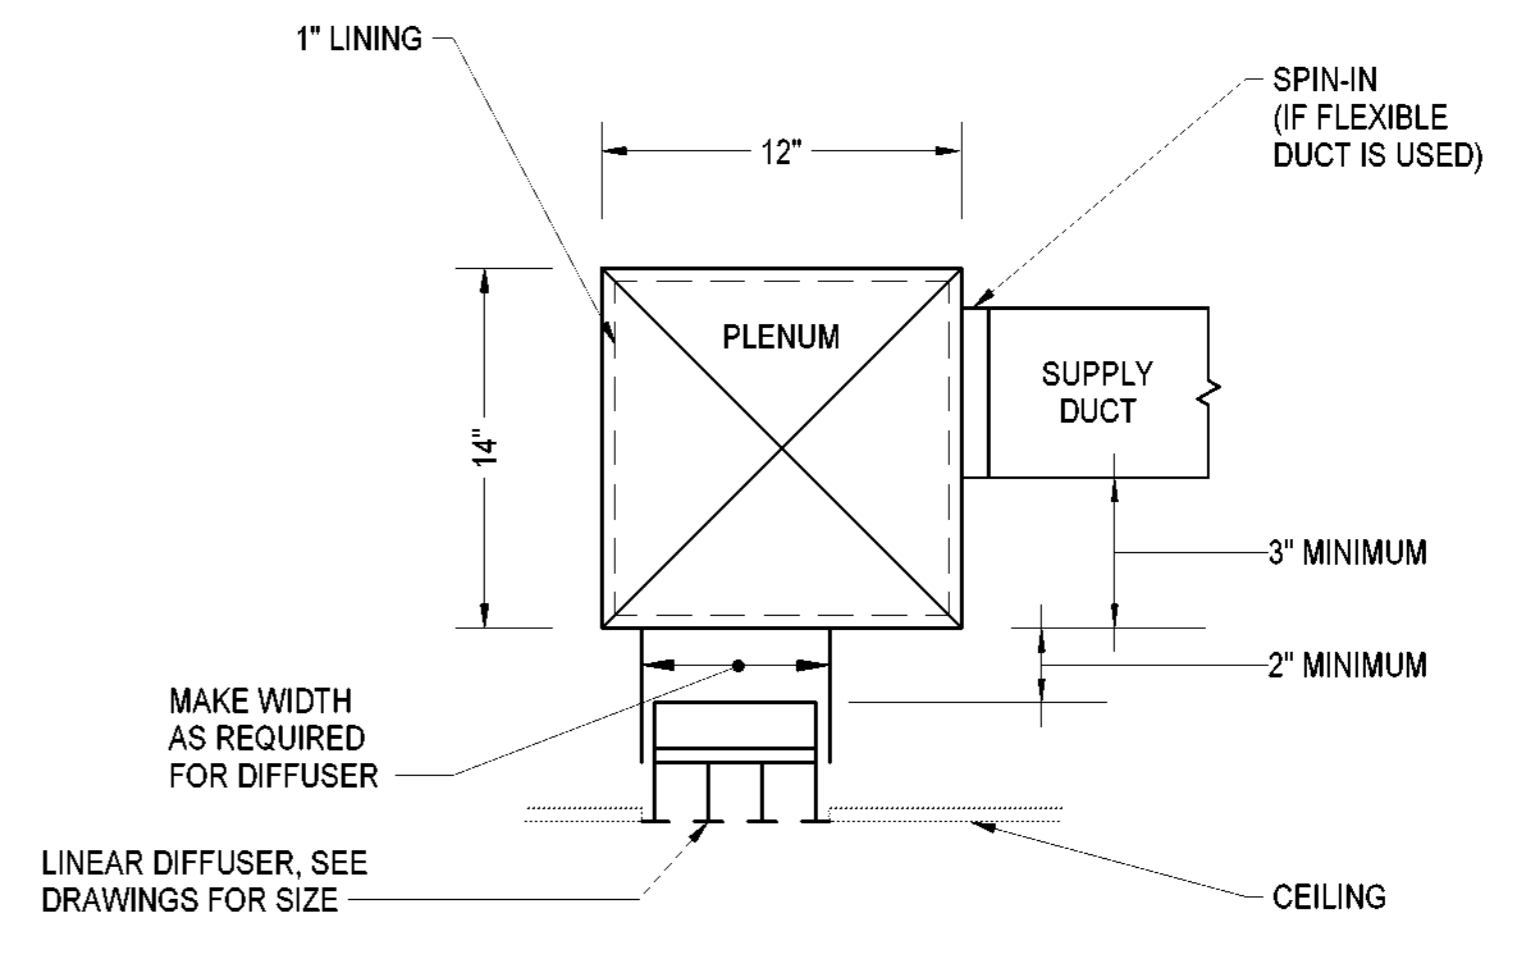

NOTES:  
 1. NECK AND PLENUM LENGTH SHALL BE DETERMINED BY ACTIVE DIFFUSER LENGTH.  
 2. DIFFUSER MOUNTING FRAME SHALL BE DETERMINED BY CEILING CONSTRUCTION AND MOUNTING CONDITIONS. SEE ARCHITECTURAL DRAWINGS.  
 3. TRANSITION AND/OR ADJUST PLENUM DIMENSIONS TO COORDINATE WITH STRUCTURE OR OTHER UTILITIES.  
 4. SEE DRAWINGS FOR SPECIAL PLENUM SIZES.

**5 LINEAR DIFFUSERS**  
 NO SCALE

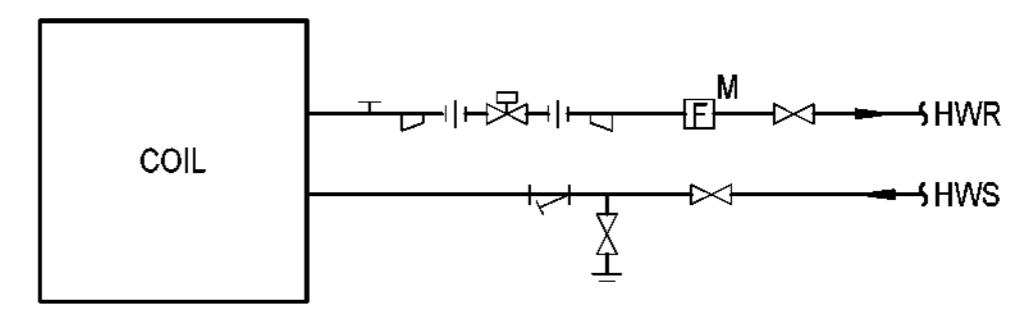

NOTES:  
 1. PROVIDE SWING JOINTS AT SUPPLY AND RETURN CONNECTIONS TO MAINS WHERE COIL RUNOUTS ARE LESS THAN 5'-0" LONG.  
 2. THIS DETAIL ALSO APPLIES TO DUCT-MOUNTED HOT WATER COILS.  
 3. LOCATE COMBINATION PRESSURE/TEMPERATURE TEST PORTS AS CLOSE TO COIL CONNECTIONS AS POSSIBLE.

**7 TERMINAL UNIT HOT WATER COILS**  
 NO SCALE




**CFD**  
 Cape Fear Development

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Grace Street  
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LS3P PROJECT: 7701-177800

| DATE         | DESCRIPTION |
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SHEET NAME:  
 HVAC DETAILS

ORIG SUBMISSION: 2023.05.22

SHEET:  
**M-602**

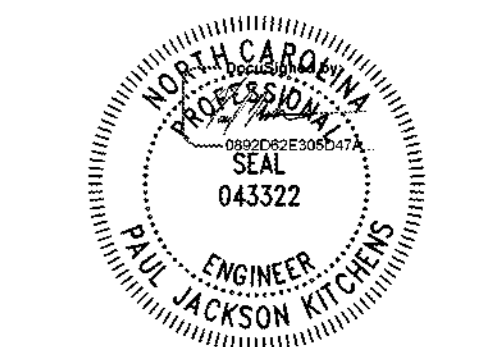PERMIT SET

THEME: PERFORMANCE & QUALITY  
 DIVERSITY  
 INNOVATION  
 SUSTAINABILITY


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D

C


B

A

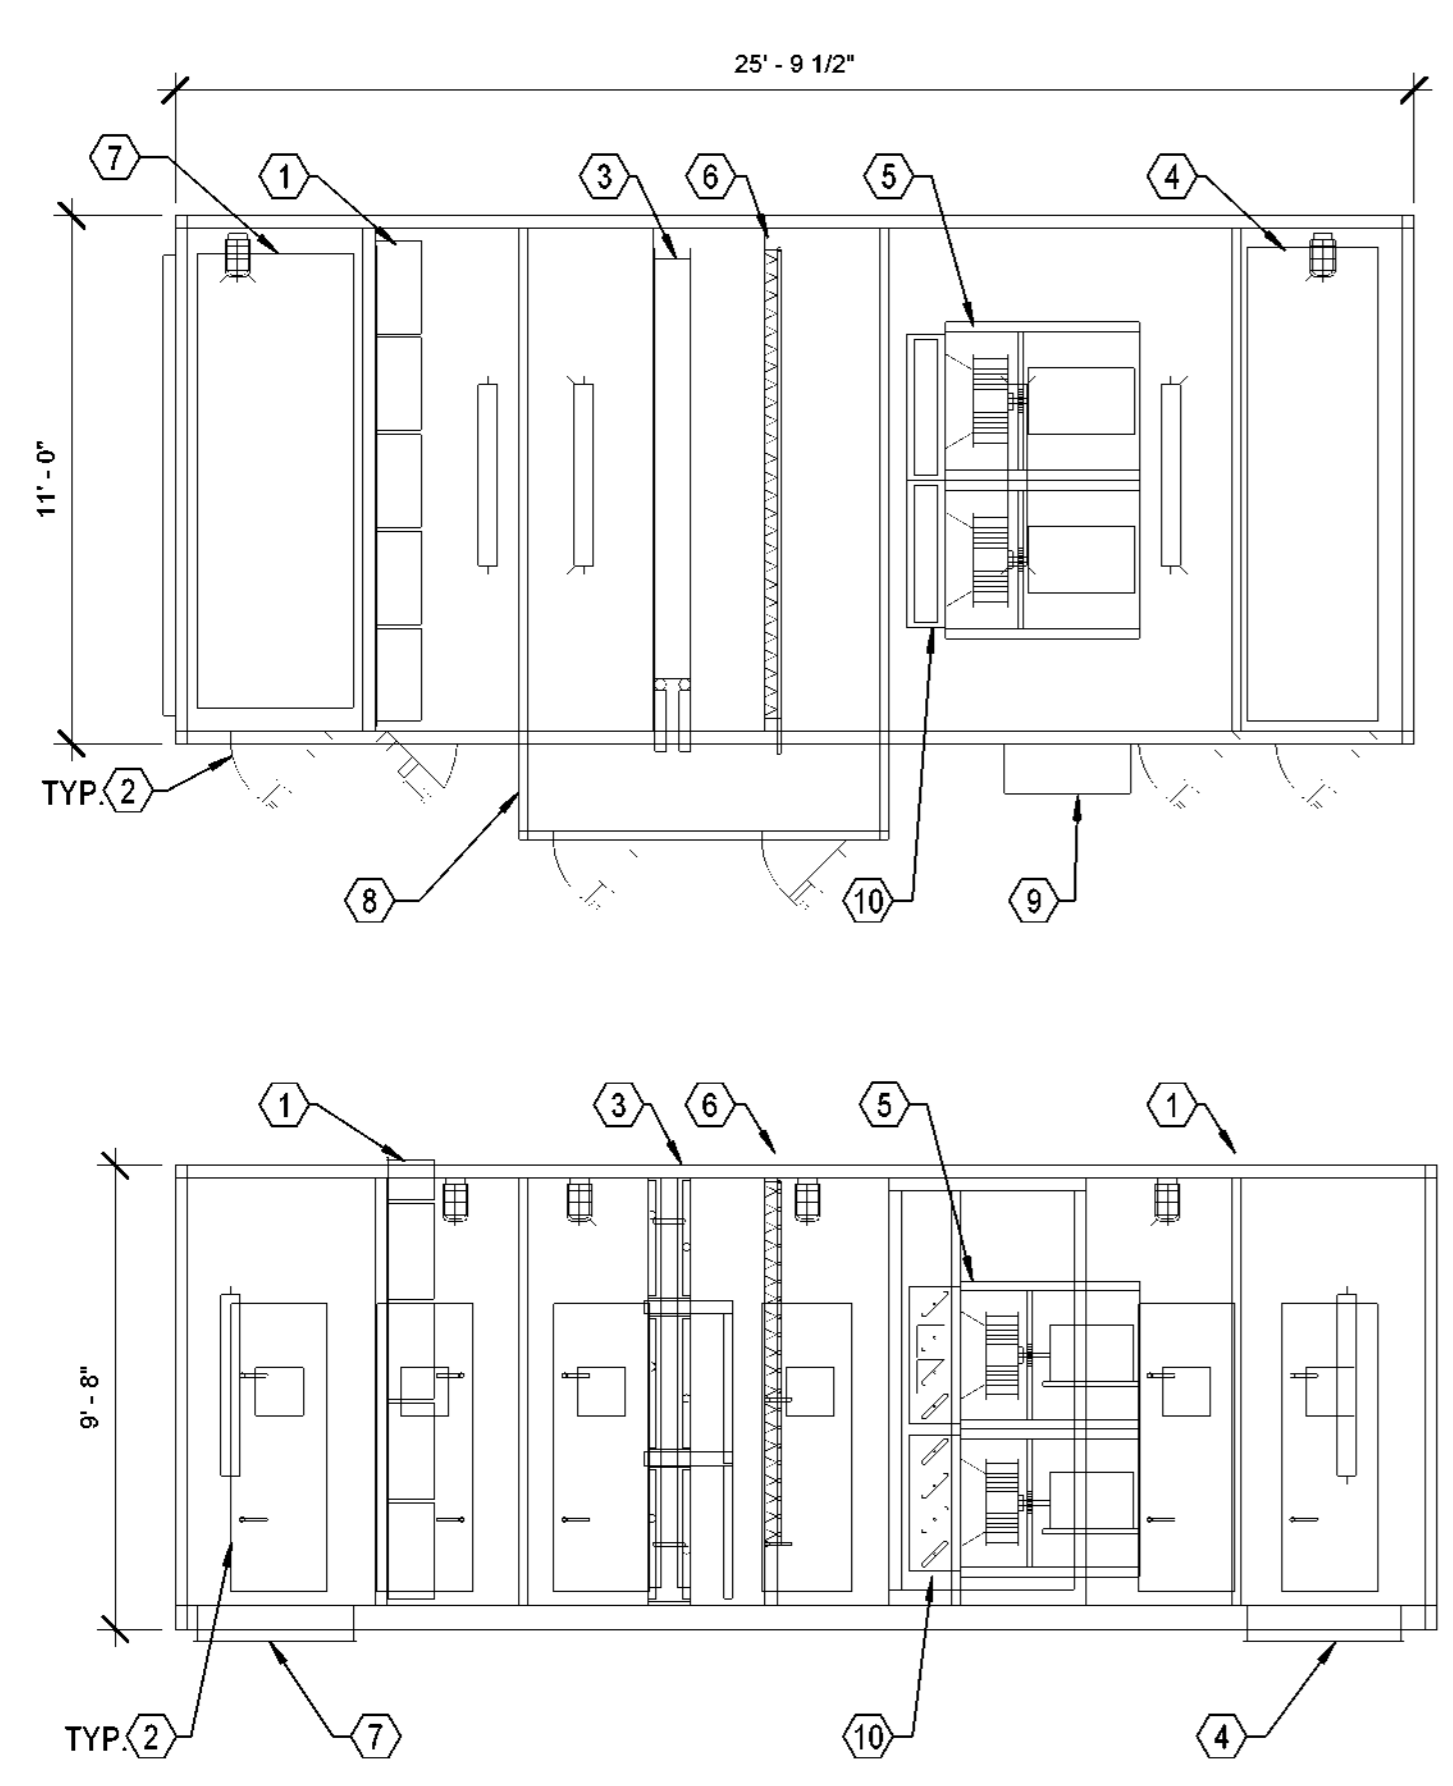


- KEYNOTES:**
- ① FILTER BANK (2" PLEATED MERV 8 + 12" CARTRIDGE MERV 15)
  - ② ACCESS DOOR
  - ③ CHILLED WATER COIL
  - ④ SUPPLY AIR OPENING
  - ⑤ SUPPLY FAN ARRAY
  - ⑥ HUMIDIFIER
  - ⑦ RETURN AIR OPENING
  - ⑧ INSULATED COIL CONNECTION VESTIBULE
  - ⑨ MANUFACTURER PROVIDED VARIABLE FREQUENCY DRIVES. ONE DRIVE PER FAN.
  - ⑩ ISOLATION DAMPERS. ONE DAMPER FOR FAN.

**1 AIR HANDLING UNIT DETAIL (AHU-R-1)**  
 NO SCALE

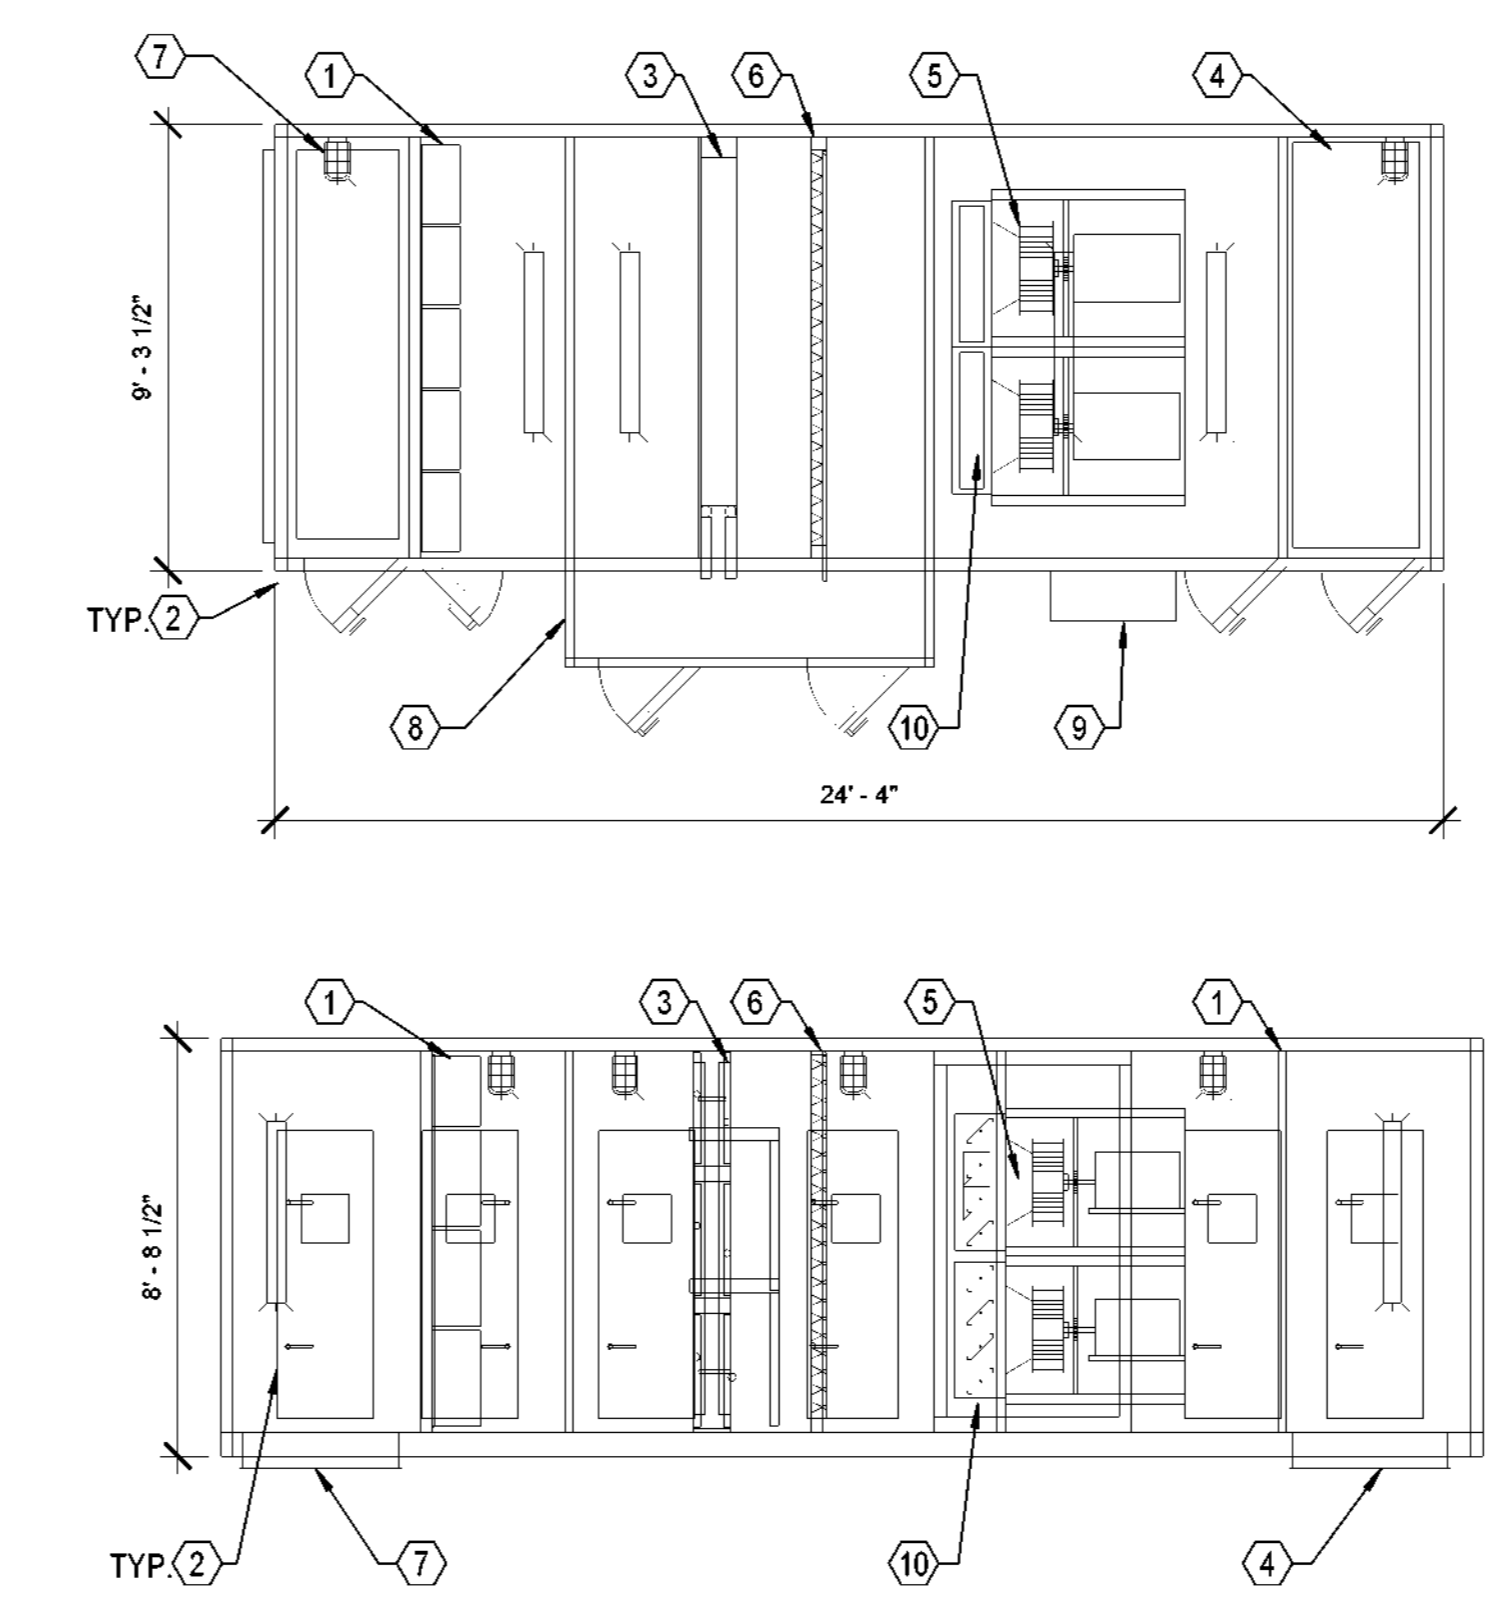

- KEYNOTES:**
- ① FILTER BANK (2" PLEATED MERV 8 + 12" CARTRIDGE MERV 15)
  - ② ACCESS DOOR
  - ③ CHILLED WATER COIL
  - ④ SUPPLY AIR OPENING
  - ⑤ SUPPLY FAN ARRAY
  - ⑥ HUMIDIFIER
  - ⑦ RETURN AIR OPENING
  - ⑧ INSULATED COIL CONNECTION VESTIBULE
  - ⑨ MANUFACTURER PROVIDED VARIABLE FREQUENCY DRIVES. ONE DRIVE PER FAN.
  - ⑩ ISOLATION DAMPERS. ONE DAMPER FOR FAN.

**2 AIR HANDLING UNIT DETAIL (AHU-R-2)**  
 NO SCALE

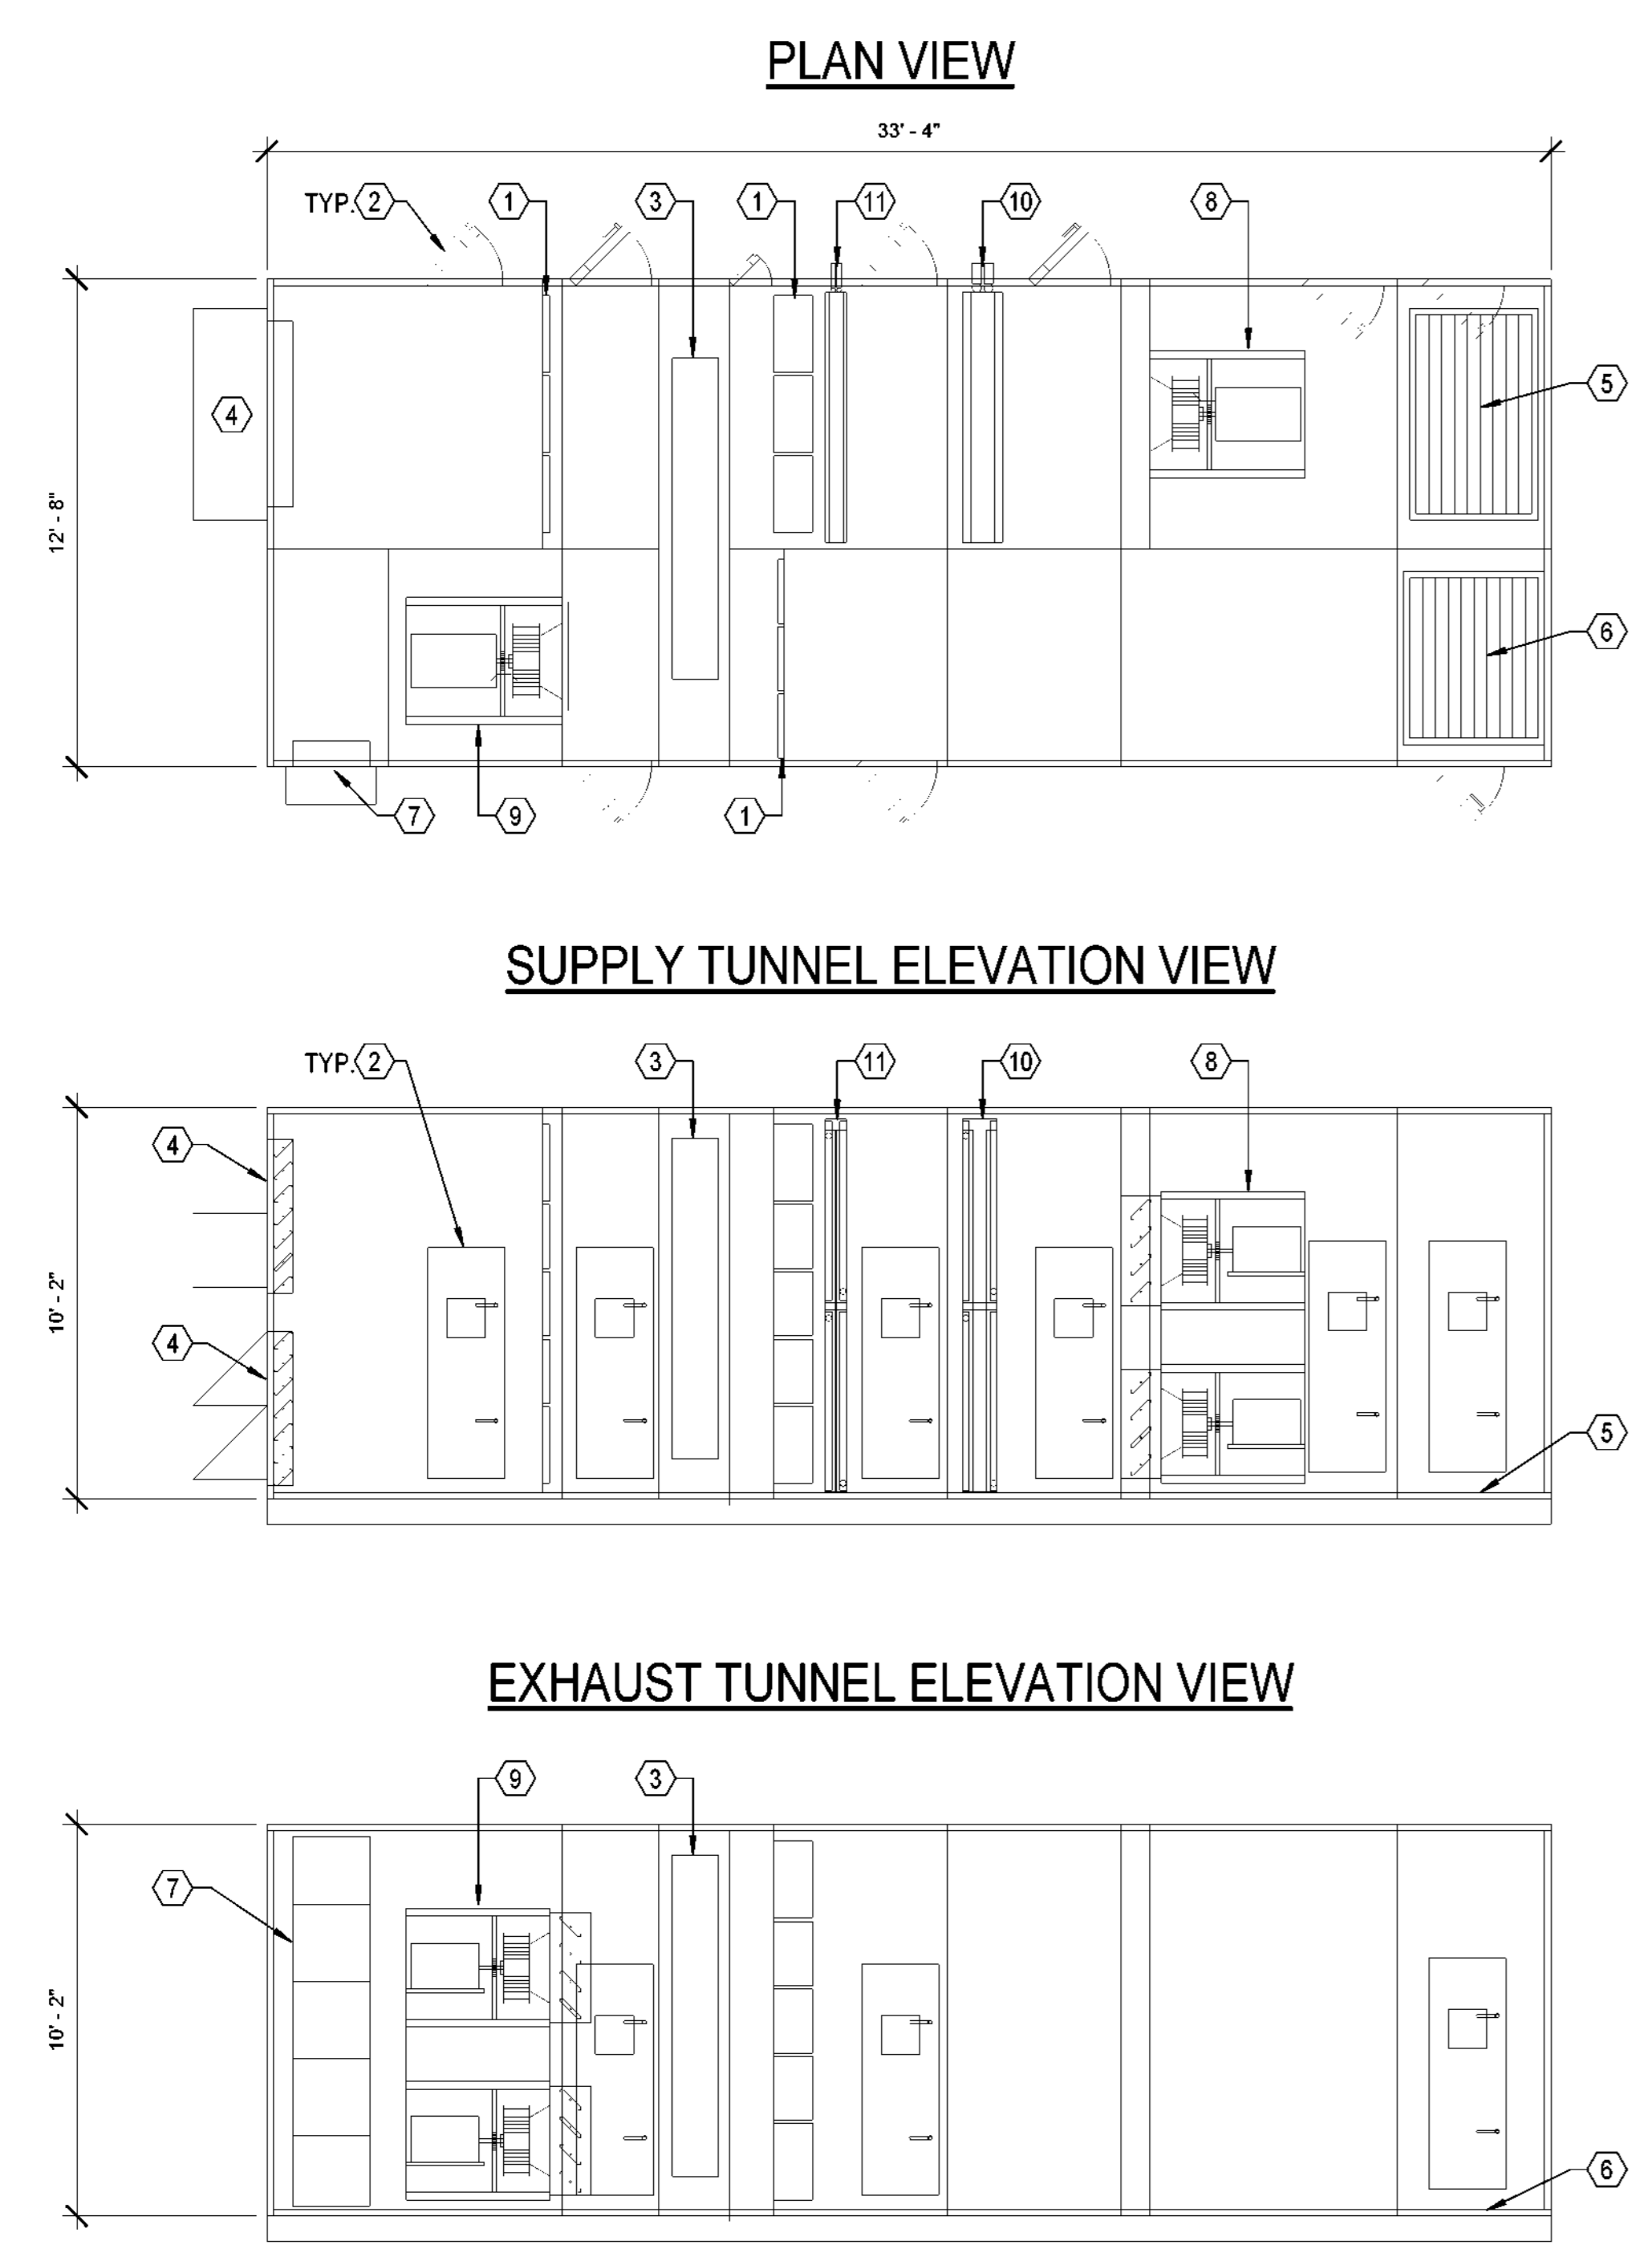

- KEYNOTES:**
- ① FILTER BANK
  - ② ACCESS DOOR
  - ③ ENERGY WHEEL
  - ④ SUPPLY AIR INLET
  - ⑤ SUPPLY AIR OUTLET
  - ⑥ EXHAUST AIR INLET
  - ⑦ EXHAUST AIR OUTLET
  - ⑧ SUPPLY FAN ARRAY
  - ⑨ EXHAUST FAN ARRAY
  - ⑩ CHILLED WATER COIL
  - ⑪ HOT WATER COIL

**3 ERU DETAIL**  
 NO SCALE




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LS3P PROJECT: 7701-177800

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| 0 | 2023.05.22 | PERMIT SET  |
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SHEET NAME:  
 HVAC DETAILS

ORIG 2023.05.22  
 SUBMISSION:

SHEET:  
**M-603**

PERMIT SET

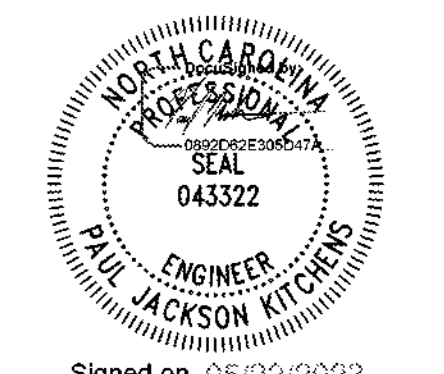

B. PROVIDE THE COMMISSIONING AUTHORITY COMPLETE SYSTEM LOGIC DIAGRAMS, DESCRIBING THE PROPOSED SYSTEM PROGRAMMING, WITH PROGRAMMED ATTRIBUTES SHOWN. THESE DIAGRAMS SHALL BE UPDATED WITH FIELD MODIFICATIONS FROM THE START-UP, CHECK-OUT, AND PREFUNCTIONAL TESTING PRIOR TO THE BEGINNING OF THE FUNCTIONAL TESTING OF THE BCS. PROVIDE A COPY OF EACH PROPOSED GRAPHICAL INTERFACE SCREEN WITH INTERFACE POINTS SHOWN FOR THE ENTIRE SYSTEM.

6. PROVIDE FORMAL TRAINING SESSIONS. EACH SESSION SHALL BE CONDUCTED BY FACTORY-TRAINED PERSONNEL:
a. TRAINING I: THE FIRST TRAINING SESSION SHALL CONSIST OF 24 HOURS OF ACTUAL TRAINING. THIS TRAINING MAY BE HELD ON-SITE OR IN THE SUPPLIER'S FACILITY. IF HELD OFF-SITE, THE TRAINING MAY OCCUR PRIOR TO FINAL COMPLETION OF THE SYSTEM INSTALLATION.

C. PROVIDE TRANSFORMERS OR FILTERS FOR OPERATION OF AUTOMATIC TEMPERATURE CONTROLS FROM BUILDING POWER CIRCUITS. EACH BCS CONTROLLER SHALL BE SERVED BY A DEDICATED TRANSFORMER, AND NO MORE THAN 10 TERMINAL UNIT CONTROLLERS SHALL BE SERVED BY A SINGLE TRANSFORMER.


3) AT THE ONSET OF EACH EVALUATION CYCLE THE BCS CONTROLLER SHALL EVALUATE RETURN AIR RELATIVE HUMIDITY. IF RETURN AIR RELATIVE HUMIDITY EXCEEDS 54% RH (ADJUSTABLE), DECREASE THE CURRENT SYSTEM DISCHARGE AIR TEMPERATURE SETPOINT BY 2°F BETWEEN THE LIMITS OF THE INITIAL SETPOINT AND 5°F (ADJUSTABLE) BELOW THE INITIAL SETPOINT.



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Table with 2 columns: DATE, DESCRIPTION. Row 1: 05/22/2023, PERMIT SET

SHEET NAME: HVAC CONTROLS GENERAL NOTES CONT

ORIG 2023.05.22 SUBMISSION:

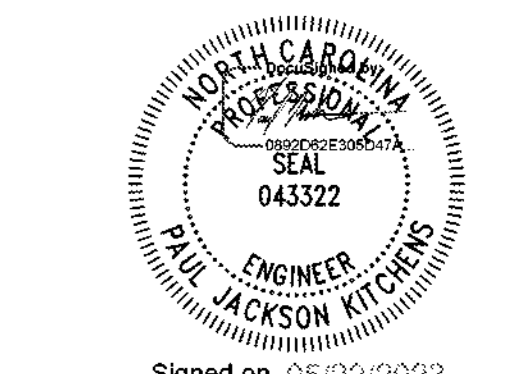SHEET: M-702

PERMIT SET










|  | OUTPUTS |         | INPUTS  |        |       | SOFTWARE |              | NOTES |
|--|---------|---------|---------|--------|-------|----------|--------------|-------|
|  | DIGITAL | DIGITAL | DIGITAL | ANALOG | ALARM | BCS      | ENERGY MGMT. |       |
| AIR HANDLING UNIT                                    | ●       |         |         |        |       |          |              | 9     |
| OUTSIDE AIR DAMPER                                   |         |         | ●       |        |       | ●        |              | 0     |
| AIRFLOW STATION                                      |         |         | ●       |        |       |          |              | 7     |
| RETURN AIR DAMPER                                    |         |         | ●       |        |       | ●        |              | 7     |
| MIXED AIR TEMPERATURE                                |         |         |         | ●      |       |          |              |       |
| CHILLED WATER CONTROL VALVE                          |         |         | ●       |        |       | ●        |              | C     |
| COOLING COIL LEAVING AIR TEMPERATURE                 |         |         |         | ●      |       |          |              |       |
| SUPPLY FAN START/STOP                                | ●       |         |         |        |       |          |              | 0     |
| SUPPLY FAN VFD SPEED                                 |         |         | ●       |        |       |          |              | 5     |
| SUPPLY FAN STATUS                                    |         |         | ●       |        |       | ●        |              |       |
| SYSTEM DISCHARGE AIR TEMPERATURE                     |         |         |         | ●      |       |          |              | 7     |
| SYSTEM DISCHARGE SMOKE DAMPER STATUS                 |         |         |         | ●      |       |          |              | 7     |
| MAIN SYSTEM SMOKE DAMPER OR FIRE SMOKE DAMPER STATUS |         |         |         | ●      |       |          |              | 7     |
| FREEZE/STAT  |         |         |         | ●      |       |          |              |       |
| DUCT HIGH STATIC PRESSURE SAFETY                     |         |         |         | ●      |       |          |              |       |
| RETURN DUCT LOW PRESSURE (SUCTION) SAFETY            |         |         |         | ●      |       |          |              |       |
| FILTER DIFFERENTIAL PRESSURE                         |         |         |         | ●      |       |          |              |       |
| SUPPLY DUCT STATIC PRESSURE                          |         |         |         |        | ●     |          |              | 8     |
| SUPPLY AIR RELATIVE HUMIDITY                         |         |         |         | ●      |       |          |              |       |
| SPACE CARBON DIOXIDE LEVEL                           |         |         |         | ●      |       |          |              |       |
| RETURN AIR TEMPERATURE                               |         |         |         | ●      |       |          |              | 3     |
| RETURN AIR RELATIVE HUMIDITY                         |         |         |         | ●      |       |          |              |       |
| RETURN AIR CARBON DIOXIDE LEVEL                      |         |         |         | ●      |       |          |              |       |
| OUTSIDE AIR TEMPERATURE                              |         |         |         | ●      |       |          |              | 4     |
| OUTSIDE AIR RELATIVE HUMIDITY                        |         |         |         | ●      |       |          |              |       |
| HUMIDIFIER CONTROL                                   |         |         |         |        |       | ●        |              |       |
| RELATIVE HUMIDITY HIGH LIMIT                         |         |         |         | ●      |       |          |              |       |

- NOTES:
- FAILURE MODE  
O - ON OR OPEN  
C - OFF OR CLOSE  
L - LAST COMMAND
  - WHERE FAILURE MODE IS INDICATED, THE INDICATED POSITION SHALL OCCUR ON FAILURE OF THE BCS CONTROLLER OR ITS OUTPUT FOR ANY REASON.
  - SEE PIPING PLANS FOR SENSOR LOCATIONS.
  - LOCATE OUTSIDE AIR TEMPERATURE SENSOR ON A NORTH FACING WALL OUT OF DIRECT SUNLIGHT. ONE OUTSIDE AIR TEMPERATURE SENSOR AND ASSOCIATED CONTROL POINT REQUIRED. SINGLE SENSOR AND CONTROL POINT MAY BE USED FOR ALL SYSTEMS AS REQUIRED.
  - FAN SHALL FAIL TO 50% SPEED.
  - PROVIDE BACNET INTEGRATION OF ALL AVAILABLE POINTS FROM VFD.
  - MONITOR OPEN AND CLOSED STATUS OF DAMPER END SWITCHES FROM TWO SEPARATE END SWITCHES INSTALLED ON DAMPER SHAFT.
  - DUCT STATIC PRESSURE SENSORS ARE SHOWN ON THE DUCTWORK FLOORPLANS.
  - PROVIDE GRAPHICS AND TRENDS FOR ALL POINTS LISTED IN I/O SUMMARY.


- SEQUENCE OF OPERATION**
- THE CONTROLS FOR THE AIR HANDLING UNITS AHU-R-1, AND AHU-R-2 SHALL FUNCTION AS FOLLOWS:
- SYSTEM START-UP:** THE SYSTEM SHALL BE AUTOMATICALLY STARTED AND STOPPED BY THE BCS CONTROLLER WHENEVER THE SYSTEM IS IN THE MANUAL MODE OR IN AUTOMATIC MODE AND ANY OF THE BELOW ARE TRUE:
    - THE TIME OF DAY IS BETWEEN THE SCHEDULED OCCUPIED START AND TOP TIMES.
    - THE SCHEDULE HAS BEEN OVERRIDDEN BY THE OPERATOR.
    - ANY ZONE LOCAL OVERRIDE TIMER (INITIATED BY LOCAL OVERRIDE BUTTON) IS NONZERO.
  - DAMPER AND FAN PRE-START STATUS:** PRIOR TO FAN STARTING, THE SYSTEM DAMPERS AND FANS SHALL HAVE THE FOLLOWING STATUSES:
 

| DAMPER/FAN             | STATUS | PROVEN STATUS     |
|------------------------|--------|-------------------|
| OUTSIDE AIR DAMPER     | CLOSED | CLOSED            |
| DISCHARGE SMOKE DAMPER | OPEN   | OPEN              |
| MAIN ISOLATION DAMPER* | OPEN   | OPEN              |
| RETURN AIR DAMPER      | OPEN   | OPEN FOR 1 MINUTE |

\*INCLUDES SMOKE AND FIRE/SMOKE DAMPERS  
\*\*IF COMPLETE FLOW PATH IS BLOCKED BY BRANCH DAMPERS BEING CLOSED THE UNIT SHALL NOT START.
  - OPTIMUM START:** THE SYSTEM SHALL START PRIOR TO SCHEDULED OCCUPANCY BASED ON THE TIME NECESSARY FOR THE ZONES TO REACH THEIR OCCUPIED SETPOINTS.
  - UNIT START-UP (PRE-COOL & RE-HEAT):** ON UNIT START-UP, THE SYSTEM SHALL RUN. IF OUTSIDE AIR TEMPERATURE IS BELOW 55°F (ADJUSTABLE), CLOSE THE CHILLED WATER VALVE AND MODULATE ALL ZONE LEVEL REHEAT COIL VALVES TO THE MAXIMUM DISCHARGE AIR TEMPERATURE SETPOINT. IF THE OUTSIDE AIR TEMPERATURE IS 55°F (ADJUSTABLE) OR HIGHER, MODULATE THE CHILLED WATER VALVE TO MAINTAIN MINIMUM DISCHARGE AIR TEMPERATURE SETPOINT. MODULATE THE SUPPLY FAN VARIABLE FREQUENCY DRIVE TO MAINTAIN ALL SUPPLY DUCT STATIC PRESSURE AT OR ABOVE THEIR RESPECTIVE SETPOINTS AS DETERMINED DURING THE TESTING, ADJUSTING AND BALANCING PROCESS. UNIT START-UP SHALL CONTINUE FOR 30 MINUTES (ADJUSTABLE) OR UNTIL RETURN AIR TEMPERATURES ARE WITHIN 2°F (ADJUSTABLE) OF THE OCCUPIED SPACE TEMPERATURE SETPOINTS FOR A PERIOD OF 5 MINUTES (ADJUSTABLE). UPON COMPLETION OF UNIT START-UP, OPEN THE OUTSIDE AIR DAMPER AND START NORMAL OPERATION.
  - DISCHARGE AIR TEMPERATURE CONTROL:** MODULATE THE CHILLED WATER VALVE TO MAINTAIN THE SYSTEM DISCHARGE AIR TEMPERATURE SETPOINT.
  - SUPPLY DUCT STATIC PRESSURE CONTROL:** MODULATE THE SUPPLY FAN VARIABLE FREQUENCY DRIVE TO MAINTAIN SUPPLY DUCT STATIC PRESSURE AT OR ABOVE THEIR RESPECTIVE SETPOINTS, AS DETERMINED DURING THE TESTING, ADJUSTING AND BALANCING PROCESS.
  - HUMIDIFIER CONTROL:** AIRFLOW SHALL BE PROVEN PRIOR TO ACTIVATION OF HUMIDIFIER SYSTEM. MODULATE THE HUMIDIFIER OUTPUT TO MAINTAIN SYSTEM DISCHARGE AIR RELATIVE HUMIDITY SETPOINT. SYSTEM DISCHARGE AIR RELATIVE HUMIDITY SETPOINT SHALL VARY BETWEEN THE LIMITS OF 40% AND 85% RH AS REQUIRED TO MAINTAIN THE AVERAGE SPACE RELATIVE HUMIDITY AT 50% RH (ADJUSTABLE). A HIGH HUMIDITY SAFETY SHALL DISABLE THE HUMIDIFIER IF THE SYSTEM DISCHARGE AIR RELATIVE HUMIDITY EXCEEDS 90% RH
  - RUN THE STATIC PRESSURE SETPOINT RESET WITH CONSTANT DAT SETPOINT ROUTINE.**
  - OUTSIDE AIR CONTROL:** FIVE MINUTES AFTER UNIT STARTUP, ALLOW THE OUTSIDE AIR DAMPER TO MODULATE TO MAINTAIN THE MINIMUM OUTDOOR AIR SETPOINT AS MEASURED BY THE OUTDOOR AIR AIRFLOW MEASUREMENT SYSTEM. EVALUATE THE OUTSIDE AIR VOLUME ON 5-MINUTE INTERVALS (ADJUSTABLE).
  - DEMAND CONTROL VENTILATION:** ADJUST THE MINIMUM OUTSIDE AIRFLOW SETPOINT BETWEEN THE LOWER AND UPPER LIMITS IN 10% (ADJUSTABLE) INCREMENTS EVERY 10 MINUTES. IF BOTH THE AVERAGE SPACE AND AVERAGE RETURN AIR CARBON DIOXIDE CONCENTRATIONS ARE BELOW 800 PPM (ADJUSTABLE), REDUCE THE OUTSIDE AIRFLOW SETPOINT. IF EITHER THE AVERAGE SPACE OR AVERAGE RETURN AIR CARBON DIOXIDE CONCENTRATIONS ARE ABOVE 1000 PPM (ADJUSTABLE), INCREASE THE OUTSIDE AIRFLOW SETPOINT. IF ANY SPACE OR RETURN AIR CARBON DIOXIDE CONCENTRATION IS ABOVE 1000 PPM FOR 5 MINUTES (ADJUSTABLE), INCREASE THE OUTSIDE AIRFLOW SETPOINT. IF ANY SPACE OR RETURN AIR CARBON DIOXIDE CONCENTRATION IS ABOVE 1000 PPM FOR LONGER THAN 1 HOUR (ADJUSTABLE), INITIATE AN ALARM THROUGH THE BCS.
  - FREEZE PROTECTION:** A SEPARATE LOW LIMIT SAFETY SENSING AIR ENTERING THE COOLING COIL SET AT 40°F (ADJUSTABLE), SHALL STOP THE FAN, CLOSE THE OUTSIDE AIR DAMPERS AND OPEN THE CHILLED WATER VALVE AND INITIATE AN ALARM. THIS SEQUENCE SHALL REMAIN OPERATIONAL AT ALL TIMES. BCS SHALL ALARM IF MIXED AIR ENTERING THE COIL REACHES 40°F (ADJUSTABLE).
  - HIGH PRESSURE SAFETY:** A HIGH-PRESSURE SAFETY SENSING DISCHARGE STATIC PRESSURE SET AT 20% LESS THAN DUCT PRESSURE RATING SHALL STOP THE FAN.
  - LOW SUCTION SAFETY:** A LOW-SUCTION SAFETY SENSING INTAKE STATIC PRESSURE SET AT 20% LESS THAN DUCT PRESSURE AT THE MAXIMUM SETPOINT SHALL STOP THE FAN. THE LOW-SUCTION DUCT PRESSURE AT MAXIMUM SETPOINT SHALL BE DETERMINED DURING THE TESTING, ADJUSTING AND BALANCING PROCESS.
  - UNOCCUPIED SHUTDOWN:** WHEN THE TIME OF DAY EACHES THE UNOCCUPIED STOP TIME, THE SYSTEM SHALL STOP.
    - HEATING UNOCCUPIED SHUTDOWN OVERRIDE:** WHEN ANY 3 TERMINAL UNITS CALL FOR HEATING AND PRIMARY VALVES OPENS, BCS SHALL OVERRIDE THE SUPPLY FAN INTERLOCK AND ALLOW SYSTEM TO RECIRCULATE AIR. AIR HANDLING UNIT HEATING AND COOLING COIL CONTROL VALVES SHALL REMAIN CLOSED. IF AFTER 30 MINUTES (ADJUSTABLE) TERMINAL UNITS ARE STILL CALLING FOR HEAT, PRIMARY VALVES ARE OPEN AND RETURN AIR TEMPERATURE IS 54°F (ADJUSTABLE) OR BELOW, ENGAGE THE ZONE HEATING COIL CONTROL VALVE TO PROVIDE A DISCHARGE AIR TEMPERATURE OF 85°F (ADJUSTABLE).
    - COOLING UNOCCUPIED SHUTDOWN OVERRIDE:** WHEN ANY 3 TERMINAL UNITS CALL FOR COOLING AND PRIMARY VALVES OPENS, BCS SHALL OVERRIDE THE SUPPLY FAN INTERLOCK AND ALLOW SYSTEM TO RECIRCULATE AIR. AIR HANDLING UNIT COOLING AND HEATING COIL CONTROL VALVES SHALL REMAIN CLOSED. IF AFTER 30 MINUTES (ADJUSTABLE) TERMINAL UNITS ARE STILL CALLING FOR COOLING AND PRIMARY VALVES ARE OPEN, ENGAGE THE AIR HANDLING UNIT COOLING COIL CONTROL VALVE TO PROVIDE A DISCHARGE AIR TEMPERATURE OF 55°F (ADJUSTABLE).
  - SHUTDOWN:** ON POWER INTERRUPTION OR FAN SHUTDOWN, CLOSE THE OUTSIDE AIR, RELIEF, SMOKE, AND RETURN DAMPERS, CLOSE THE CHILLED WATER CONTROL VALVE AND THE PREHEAT COIL CONTROL VALVE.
  - SMOKE DETECTION:** SMOKE DETECTORS AT THE AIR HANDLING UNIT SHALL AUTOMATICALLY SHUT DOWN THE FAN.
  - FIRE ALARM SYSTEM:** ON ACTIVATION OF THE FIRE ALARM SYSTEM RELAY, THE SYSTEM SHALL SHUT DOWN.

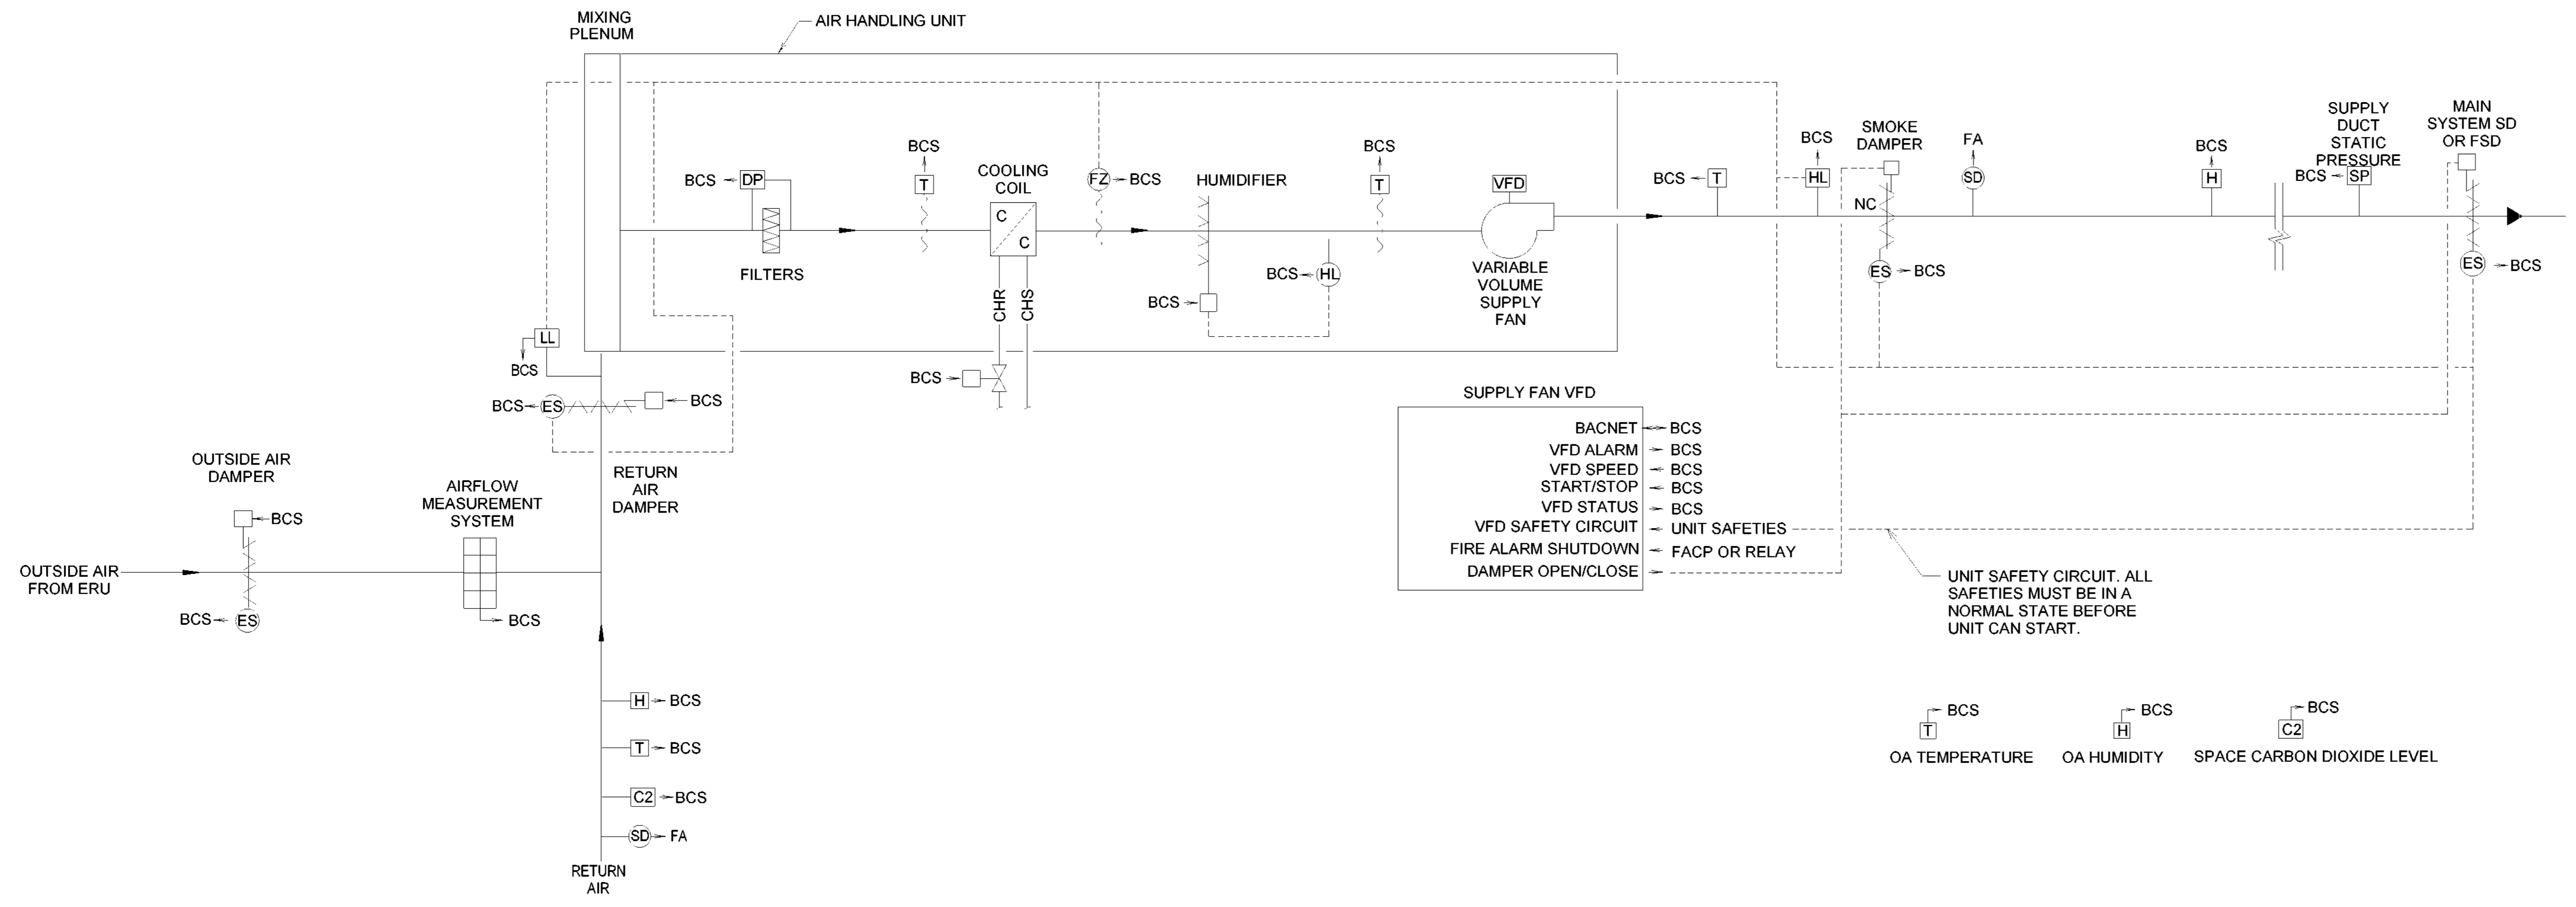


1 HVAC CONTROLS VAV AIR HANDLING UNITS  
1/8" = 1'-0"

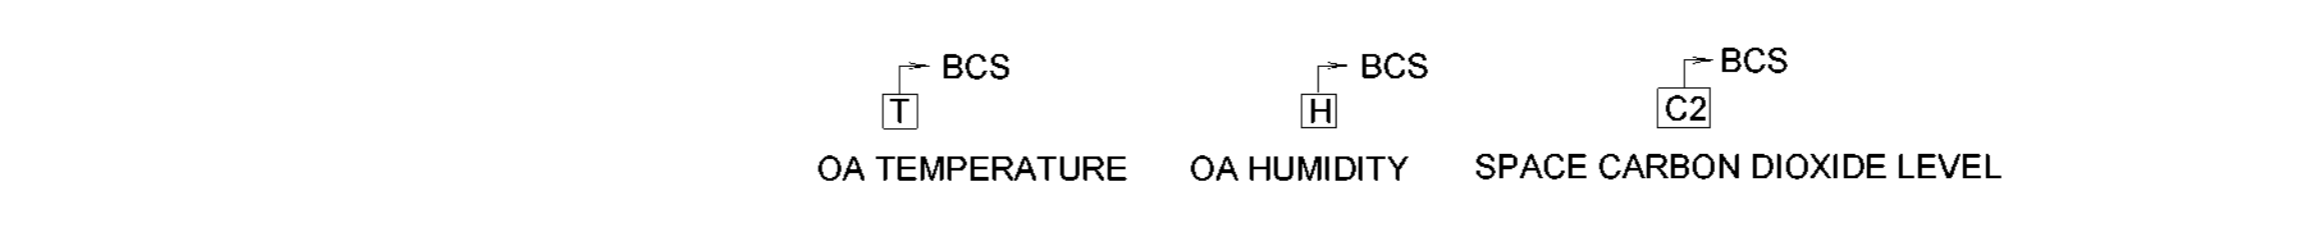

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LS3P PROJECT: 7701-177800

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SHEET NAME:  
HVAC CONTROLS  
AHU

ORIG SUBMISSION: 2023.05.22


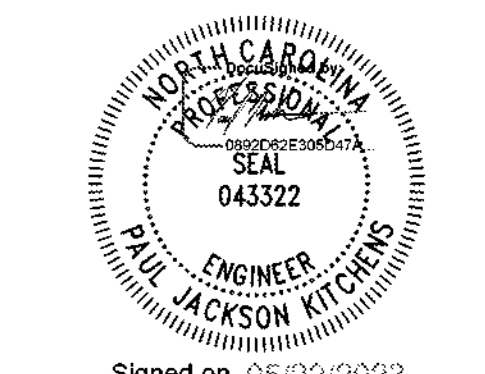
SHEET:  
M-706

THEME: PROGNOSIS E QUALITY DATE: 5/22/2023 10:17:13 AM

| BCS CONTROLLER INPUT/OUTPUT SUMMARY UTILITY METERING AND MISCELLANEOUS | OUTPUTS |        | INPUTS  |        | SOFTWARE |     |              |  | FAILURE MODE (SEE NOTE 1) | NOTES |
|--|---------|--------|---------|--------|----------|-----|--------------|--|---------------------------|-------|
|  | DIGITAL | ANALOG | DIGITAL | ANALOG | ALARM    | BCS | ENERGY MGMT. |  |                           |       |
| OUTSIDE AIR TEMPERATURE  | ●       |        |         |        |          |     |              |  |                           | 2     |
| OUTSIDE AIR RELATIVE HUMIDITY  |         |        |         |        |          |     |              |  |                           | 2     |
| OUTSIDE AIR DEW POINT  |         |        |         |        |          |     |              |  |                           | 2     |
| OUTSIDE AIR CARBON DIOXIDE   |         |        |         |        |          |     |              |  |                           | 2     |
| EMERGENCY GENERATOR STATUS   | ●       |        |         |        |          |     |              |  |                           |       |
| GENERAL ALARM  |         |        |         |        |          |     |              |  |                           |       |
| AUTOMATIC TRANSFER SWITCH POSITION                                     |         |        |         |        |          |     |              |  |                           |       |
| LOW FUEL LEVEL   |         |        |         |        |          |     |              |  |                           |       |
| MAIN ELECTRICAL METER  | ●       |        |         |        |          |     |              |  |                           |       |
| ELECTRICAL SUBMETERS   |         |        |         |        |          |     |              |  |                           |       |
| GAS METER  | ●       |        |         |        |          |     |              |  |                           |       |
| DOMESTIC COLD WATER  | ●       |        |         |        |          |     |              |  |                           |       |
| DOMESTIC COLD WATER FLOW   |         |        |         |        |          |     |              |  |                           | 4     |
| DOMESTIC COLD WATER PRESSURE   |         |        |         |        |          |     |              |  |                           | 4     |
| DOMESTIC COLD WATER TOTALIZATION                                       |         |        |         |        |          |     |              |  |                           | 4     |
| DOMESTIC WATER METER LEAK DETECTION                                    |         |        |         |        |          |     |              |  |                           | 4     |
| CIRCULATING PUMP RCP-1-1 STATUS  | ●       |        |         |        |          |     |              |  |                           | 4     |
| DOMESTIC HOT WATER CIRCULATING PUMPS                                   | ●       |        |         |        |          |     |              |  |                           | 4     |
| PUMP RUNNING   |         |        |         |        |          |     |              |  |                           |       |
| FAULT MODE   |         |        |         |        |          |     |              |  |                           |       |
| WATER HEATERS WH-1-1   | ●       |        |         |        |          |     |              |  |                           | 4     |
| SETPOINT DISPLAY   |         |        |         |        |          |     |              |  |                           |       |
| OUTLET WATER TEMPERATURE   |         |        |         |        |          |     |              |  |                           |       |
| OVER-TEMPERATURE ALARM   |         |        |         |        |          |     |              |  |                           |       |
| ELEVATOR SUMP PUMP SP-1-1, SP-1-2, SP-1-3                              | ●       |        |         |        |          |     |              |  |                           | 4     |
| PUMP ON STANDBY  |         |        |         |        |          |     |              |  |                           |       |
| PUMP RUNNING   |         |        |         |        |          |     |              |  |                           |       |
| PUMP FAILURE   |         |        |         |        |          |     |              |  |                           |       |
| TERMINAL UNITS (TYPE VV-R AND VV)                                      | ●       |        |         |        |          |     |              |  |                           | 8     |
| PRIMARY AIR FLOW   |         |        |         |        |          |     |              |  |                           | O     |
| PRIMARY AIR VALVE CONTROL  |         |        |         |        |          |     |              |  |                           | L     |
| HEATING WATER VALVE CONTROL (TYPE VV-R ONLY)                           |         |        |         |        |          |     |              |  |                           |       |
| DISCHARGE AIR TEMPERATURE (TYPE VV-R ONLY)                             |         |        |         |        |          |     |              |  |                           |       |
| SPACE TEMPERATURE  |         |        |         |        |          |     |              |  |                           | 6     |
| SPACE CARBON DIOXIDE LEVEL   |         |        |         |        |          |     |              |  |                           |       |
| EXHAUST AIR TERMINAL UNITS   | ●       |        |         |        |          |     |              |  |                           | 8     |
| PRIMARY AIR FLOW   |         |        |         |        |          |     |              |  |                           | O     |
| PRIMARY AIR VALVE CONTROL  |         |        |         |        |          |     |              |  |                           |       |



- NOTES:**
- FAILURE MODE  
O - ON OR OPEN  
C - OFF OR CLOSE  
L - LAST COMMAND
  - SEE DRAWINGS FOR SENSOR LOCATIONS.
  - PROVIDE ELECTRIC METER, CTS, CT FUSES, AND METER ENCLOSURE TO BE INSTALLED BY ELECTRICAL CONTRACTOR.
  - PROVIDE IDENTICAL POINTS FOR EACH SIMILAR PIECE OF EQUIPMENT.
  - PROVIDE IDENTICAL MONITORING POINTS FOR EACH ELECTRICAL SUBMETER. REFER TO ELECTRICAL DRAWINGS FOR SUBMETER QUANTITY.
  - POINTS NOT REQUIRED FOR ALL TERMINAL UNITS. REFER TO DRAWINGS M-1001 THROUGH M-1013F FOR CARBON DIOXIDE SENSOR LOCATIONS.
  - TERMINAL UNIT CONTROLS AND INTERFACES SHALL BE ARRANGED SO THAT EQUIPMENT CONTROLLED BY THE BCS OPERATES AS INDICATED ON FAILURE OF THE TERMINAL UNIT CONTROLLER FOR ANY REASON, INCLUDING LOGIC POWER SUPPLY FAILURE, CPU LOCK-UP, OR INTERPOSING RELAY FAILURE. SAFETY AND OPERATIONAL INTERLOCKS SHALL REMAIN IN EFFECT.
  - PROVIDE TERMINAL UNIT CONTROLLER WITH IDENTICAL CONTROL POINTS AND FUNCTIONS FOR EACH TERMINAL UNIT.

- SEQUENCE OF OPERATION:**
- ON A RISE IN SPACE TEMPERATURE ABOVE COOLING SETPOINT, EACH TERMINAL UNIT CONTROLLER SHALL MODULATE THE PRIMARY AIR VALVE TO THE MAXIMUM FLOW. ONCE THE SPACE TEMPERATURE SETPOINT IS MET, THE PRIMARY AIR VALVE SHALL MODULATE THE FLOW TO MAINTAIN THE SPACE CONDITIONS.
  - ON A DROP IN SPACE TEMPERATURE BELOW HEATING SETPOINT, EACH TERMINAL UNIT CONTROLLER SHALL MODULATE THE PRIMARY AIR VALVE TO THE MINIMUM FLOW.
  - IF THE SPACE TEMPERATURE FALLS THROUGH THE 5°F SPACE TEMPERATURE DEADBAND TO THE HEATING SETPOINT, THE TERMINAL UNIT CONTROLLER SHALL MODULATE THE PRIMARY AIR VALVE TO MAINTAIN THE MINIMUM HEATING FLOW AND MODULATE THE HOT WATER VALVE TO MAINTAIN LEAVING AIR TEMPERATURE SETPOINT.
  - LEAVING AIR TEMPERATURE SETPOINT SHALL BE VARIED TO MAINTAIN SPACE TEMPERATURE SETPOINT BETWEEN THE LIMITS OF THE AIR HANDLING UNIT SYSTEM DISCHARGE AIR TEMPERATURE SETPOINT AND 20°F ABOVE THE HEATING SPACE TEMPERATURE SETPOINT.
  - ON A FURTHER DROP IN SPACE TEMPERATURE, THE TERMINAL UNIT CONTROLLER SHALL MODULATE THE PRIMARY AIR VALVE OPEN TO THE MAXIMUM HEATING FLOW TO MAINTAIN THE HEATING SPACE TEMPERATURE SETPOINT WHILE SIMULTANEOUSLY MODULATE THE HOT WATER VALVE TO MAINTAIN LEAVING AIR TEMPERATURE AT 20°F ABOVE THE HEATING SPACE TEMPERATURE SETPOINT.

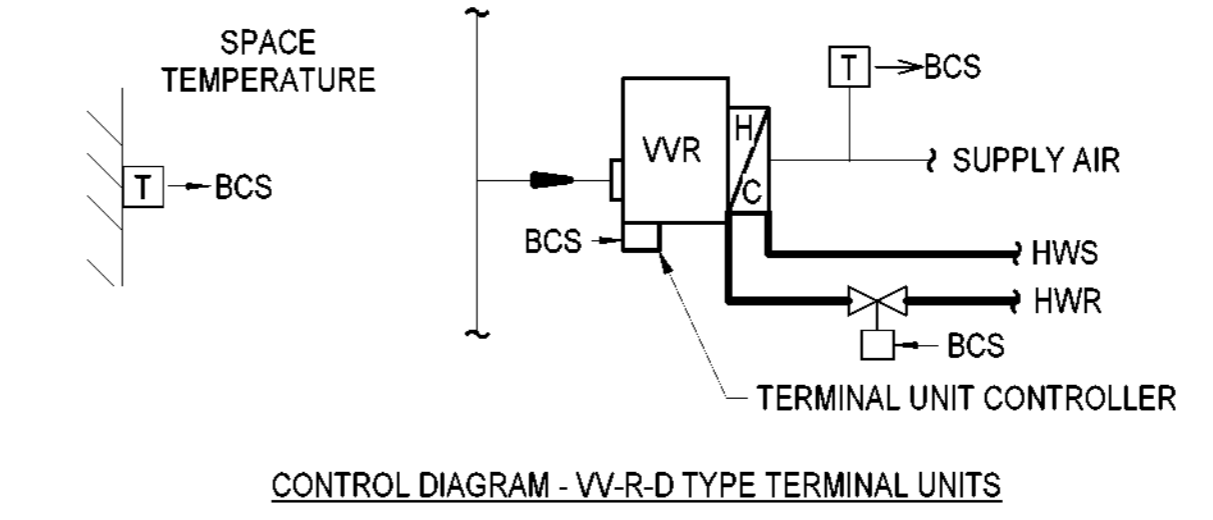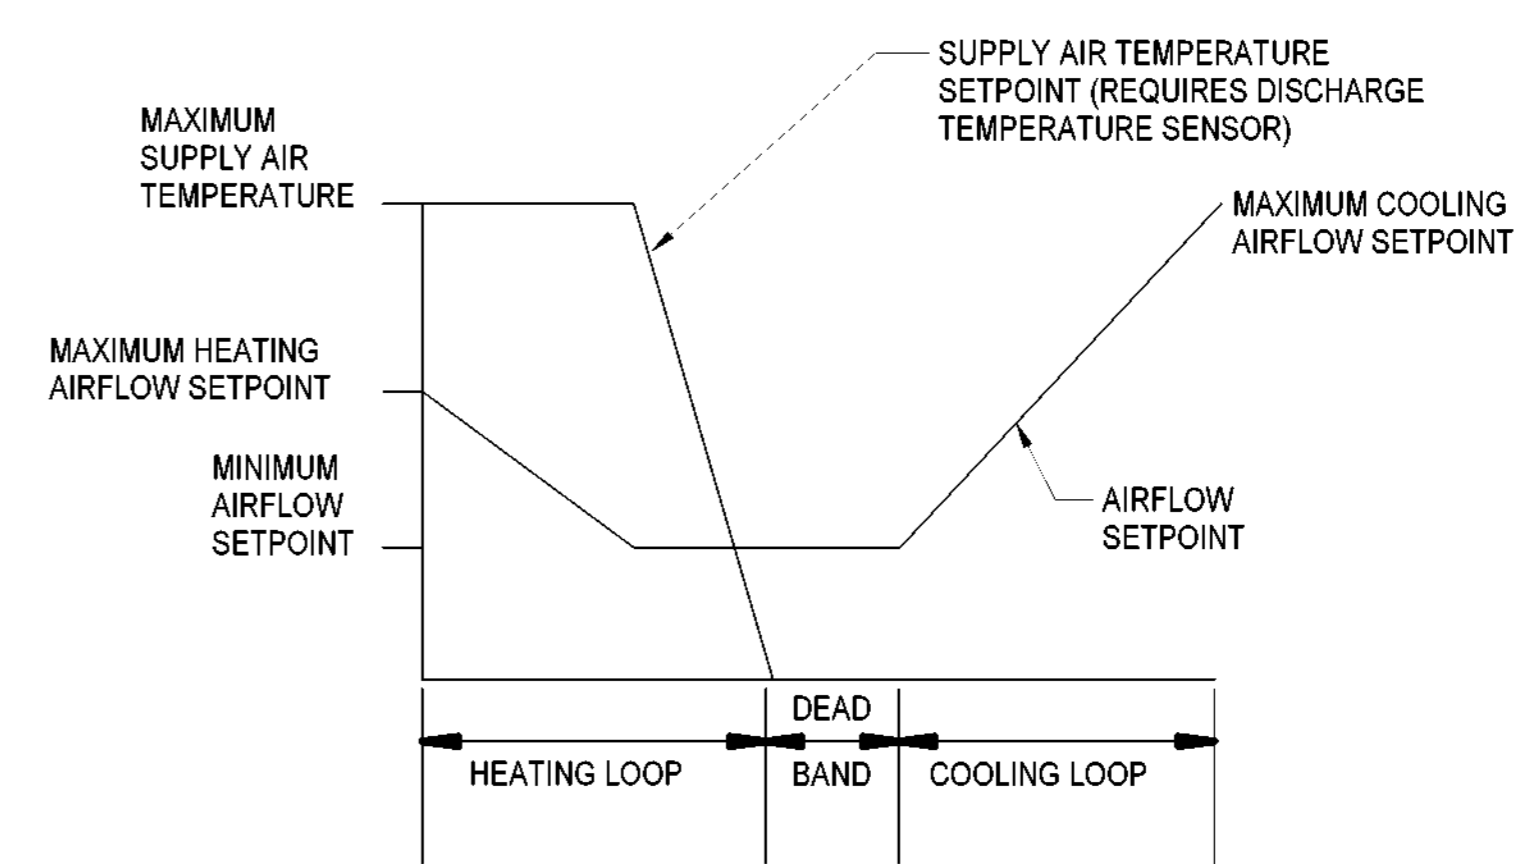


CONTROL DIAGRAM - VV-R-D TYPE TERMINAL UNITS

- SEQUENCE OF OPERATION:**
- ON A RISE IN SPACE TEMPERATURE ABOVE COOLING SETPOINT, EACH TERMINAL UNIT CONTROLLER SHALL MODULATE THE PRIMARY AIR VALVE TO THE MAXIMUM FLOW. ONCE THE SPACE TEMPERATURE SETPOINT IS MET, THE PRIMARY AIR VALVE SHALL MODULATE THE FLOW TO MAINTAIN THE SPACE CONDITIONS.
  - ON A DROP IN SPACE TEMPERATURE BELOW COOLING SETPOINT, EACH TERMINAL UNIT CONTROLLER SHALL MODULATE THE PRIMARY AIR VALVE TO THE MINIMUM FLOW.
  - IF THE SPACE TEMPERATURE FALLS THROUGH THE 5°F SPACE TEMPERATURE DEADBAND TO THE HEATING SETPOINT, THE TERMINAL UNIT CONTROLLER SHALL MODULATE THE PRIMARY AIR VALVE TO MAINTAIN THE MINIMUM HEATING FLOW AND MODULATE THE HOT WATER VALVE TO MAINTAIN LEAVING AIR TEMPERATURE SETPOINT.

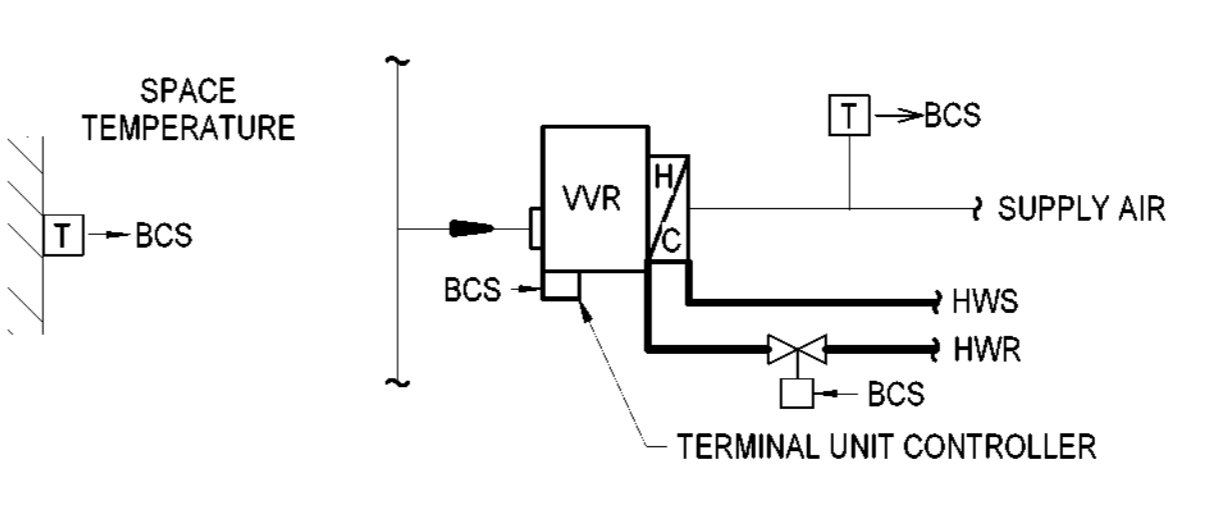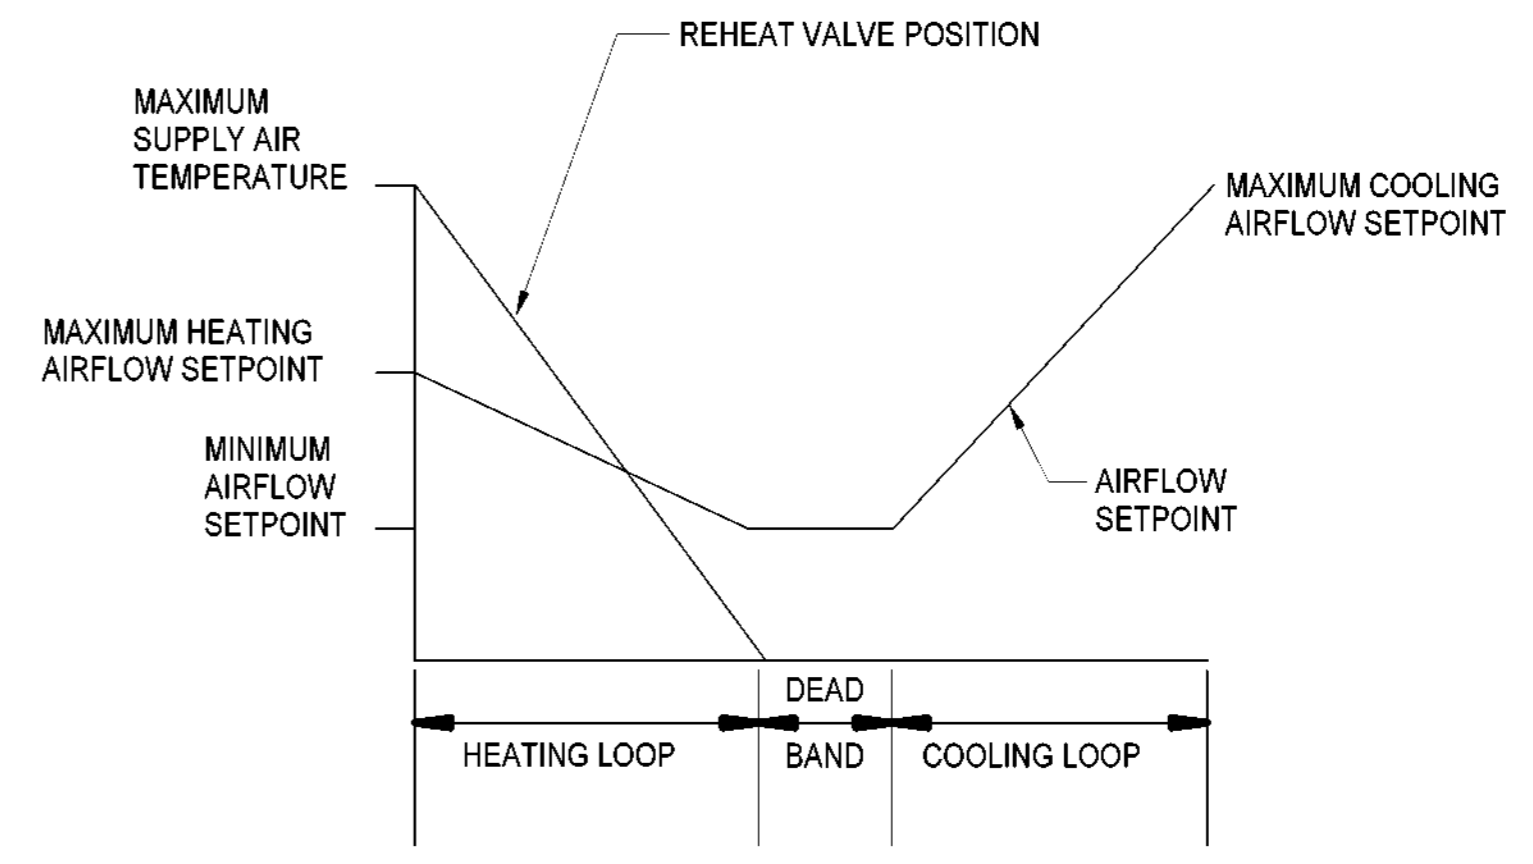


CONTROL DIAGRAM - VV-R TYPE TERMINAL UNITS

- SEQUENCE OF OPERATION:**
- VARIABLE VOLUME: EACH TERMINAL UNIT CONTROLLER SHALL MODULATE THE PRIMARY AIR VALVE BETWEEN THE MINIMUM AND MAXIMUM QUANTITIES INDICATED ON THE DRAWINGS TO MAINTAIN SPACE TEMPERATURE SETPOINT.

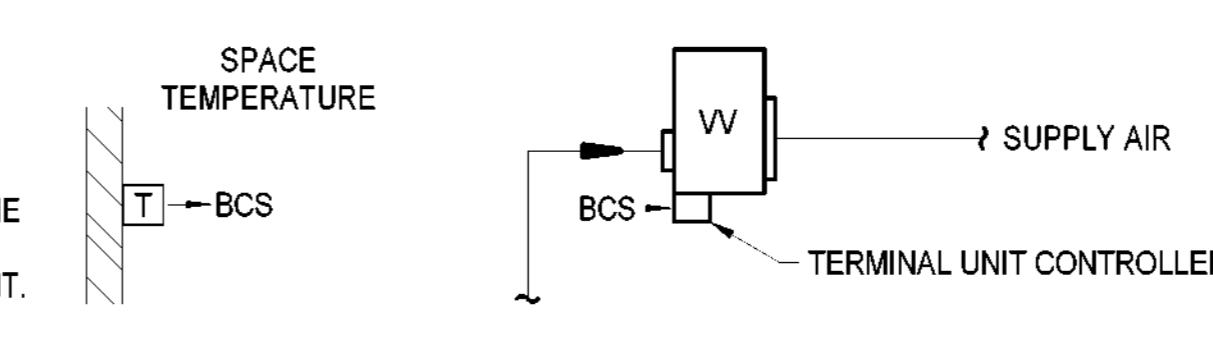

CONTROL DIAGRAM - VV TYPE TERMINAL UNITS

- SEQUENCE OF OPERATION:**
- CONSTANT VOLUME: EACH TERMINAL UNIT CONTROLLER SHALL MODULATE THE PRIMARY AIR VALVE TO MAINTAIN THE SCHEDULED EXHAUST FLOW.
  - THE BCS SHALL ALARM IF THE EXHAUST AIRFLOW IS MORE THAN 10% BELOW THE MINIMUM EXHAUST FLOW FOR MORE THAN 30 MINUTES.

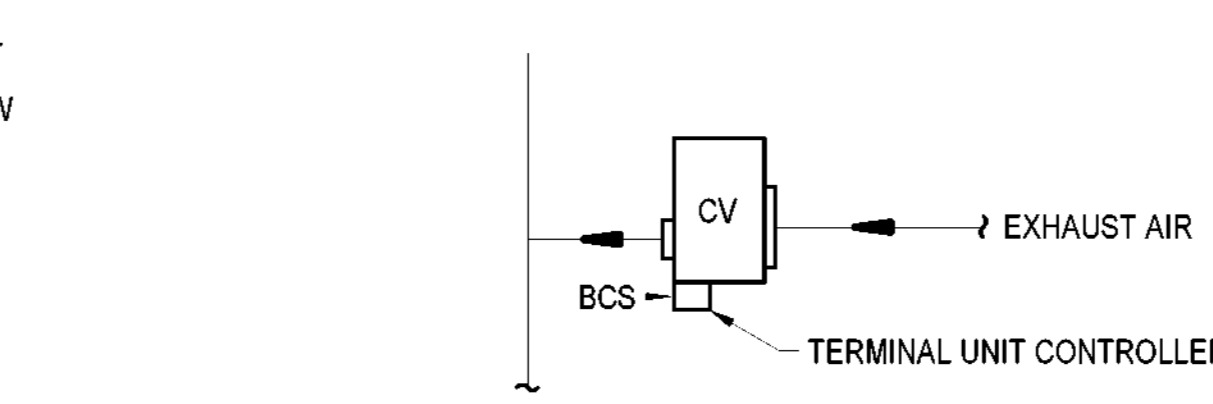

CONTROL DIAGRAM - CV EA TYPE TERMINAL UNITS

**1 MISCELLANEOUS CONTROLS SCHEMATICS**  
NO SCALE

**CFD**  
Cape Fear Development

**LS3P**

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Signed on 05/22/2023  
using a Digital Signature.

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**Project Grace**

Grace Street  
Wilmington, NC 28401

LS3P PROJECT: 7701-177800

| Δ | DATE       | DESCRIPTION |
|---|------------|-------------|
| 0 | 2023.05.22 | PERMIT SET  |

SHEET NAME:  
**HVAC CONTROLS - MISCELLANEOUS**

ORIG SUBMISSION: 2023.05.22

SHEET:  
**M-707**

PERMIT SET

