

**ADDENDUM NUMBER: TWO [2]**

---

**PROJECT:** **Provalus Whiteville**  
127 West Columbus St. [former News Reporter Building]  
Whiteville, North Carolina 28472

**ARCHITECT'S PROJECT NO:** 24002

**DATE:** November 27, 2024

**OWNER:** City of Whiteville  
Darren Currie, City Manager  
317 S. Madison St.  
Whiteville, North Carolina 28472

**ARCHITECT:** Oakley Collier Architects, P.A.  
109 Candlewood Road  
Rocky Mount, North Carolina 27804  
(252) 937-2500

**PREVIOUSLY ISSUED:** Addendum 1

**TO ALL CONTRACTORS:**

This Addendum is hereby made a part of the Contract Documents to the same extent as if originally included therein. This Addendum must be acknowledged on the Form of Proposal and shall be placed with the Contract Documents.

Drawings and Project Manual dated October 30, 2024, for this project are hereby modified, corrected, or supplemented as follows:

**Specifications**

**Item 1 Revision**      **01 20 00 - Allowances**  
Add Allowance No. 3 – Roof Penetrations  
    Include in the base bid amount an allowance of \$7,500 for Demo Roof  
    Renovation Repairs  
Add Allowance No. 4 – Concrete Leveling  
    Include in the base bid amount an allowance of \$15,000 for existing  
    concrete slab leveling and prep. Floor Trenches to remain and shall be  
    filled in as part of the leveling allowance.

**Item 2 Revision**      **09 50 00 – RIB – Acoustical Ceilings**  
In 2.02, replace “Duraclean Smooth White PVC Ceiling Tiles” with “USG Clima-  
Plus Millenia”

**Drawings**

- Item 3 Revision**      **Sheet A1.2 – Reflected Ceiling Plan**  
Updated Ceiling Legend
- Item 4 Revision**      **Sheet A1.3 – Finish Plan – First Floor**  
Updated Finish Schedule to show Corridors 200, 201, 202, 23, 205, & 206
- Item 5 Revision**      **Sheet A1.6 – Enlarged Restroom Plans**  
Toilet Accessories Schedule – Added ‘Shower Insert’ (SP)  
Tagged Shower Insert on Details 8, 9, and 12
- Item 6 Revision**      **Sheet A6.1 – Door and Window Schedule**  
Detail 6 renamed to “Door – Jamb” to add clarity.  
Detail 7 renamed to “Door – Head” to add clarity.  
Detail 10 – “Window – Sill – INT SF” Added  
Door Schedule updated to show Door 137 as Hollow Metal Frame
- Item 7 Revision**      **Sheet A6.2 – Door and Window Details**  
New Sheet Added, Includes details for Storefront details at exterior walls.
- Item 8 Revision**      **Sheet D1.1 – Demolition – First Floor Plan**  
Updated to remove demolition already completed by owner.
- Item 9 Revision**      **Sheet D1.2 – Demolition – Reflected Ceiling Plan**  
Updated to remove demolition already completed by owner.

**End of Addendum**

**BIDDER RFI RESPONSE DOCUMENT**

---

- PROJECT:** Provalus Whiteville  
127 West Columbus St. [former News Reporter Building]  
Whiteville, North Carolina 28472
- ARCHITECT'S PROJECT NO:** 24002
- DATE OF RESPONSES:** November 27, 2024
- OWNER:** City of Whiteville  
Darren Currie, City Manager  
317 S. Madison St.  
Whiteville, North Carolina 28472
- ARCHITECT:** Oakley Collier Architects, P.A.  
109 Candlewood Road  
Rocky Mount, North Carolina 27804  
(252) 937-2500
- PREVIOUSLY ISSUED:** Addendum 1
1. Remove all residual materials and clean existing concrete slabs.
  2. Existing floor trench to remain and openings to be filled in and leveled using Allowance 4 – Concrete Leveling
  3. D1.1 has been updated to removed demolition that has already been accomplished by owner.
  4. Ceiling demolition has been accomplished by owner. Clouded and shown on D1.2.
  5. Shower insert added to TA Schedule. Use Bradley 3x3 insert or other approved substitution.
  6. Demolition roof patches as a result of removal of existing roof equipment to be included in Allowance 3 – Roof Penetrations.
  7. 2x4 ceiling tiles. Use USG Clima-Plus Millenia.
  8. Seismic Design Category “C” applies.
  9. Floor finishes for Corridor 200-206 are concrete and existing terrazzo. Finishes are updated in Finish Schedule on A1.3.
  10. Door frame 137 to be hollow metal.
  11. The Electrical Contractor will not be responsible for providing diesel fuel.
  12. All of the workstation rows require 2-in conduit feed.
  13. Hardware allowances apply to all new doors.
  14. The Automatic Transfer Switch is not required to be service entrance rated.
  15. Room 121 (Exec Conference) floor finish is LVT-1. Changes were made in Addendum #1.
  16. Room 118 (Breakroom) floor finish is LVT-1. Changes were made in Addendum #1.
  17. Wall Tile (WT-1) for Room 121 (Women’s) is on East and West walls.
  18. Detail 3 on S0.3 is a typical detail. Applied to a location where something of 100 lbs gets supported by a bar joist, at a non-panel point location.
  19. Detail 4 on S0.2 is a typical detail for any NEW CMU walls only.
  20. AHU 13 (and mechanical shown in the existing metal building addition to the rear) if for limited conditioning of the space until a future phase fit-up can be accomplished.

21. Existing rooftop mechanical units will not be re-used and can be removed
22. Paint on drywall to be eggshell; Paint on wood trim to be semi-gloss. No areas of Level 5 drywall finish are anticipated.
- 23.



Copyright © 2023 Oakley/Collier Architects. These drawings are of the property of the Architect for use under his supervision. No reproduction or other use is allowed without permission.


SHEET KEYNOTES	
14	REMOVE EXISTING CEILING IN ITS ENTIRETY BACK TO STRUCTURAL DECK ABOVE, INCLUDING BUT NOT LIMITED TO CEILING SYSTEM LIGHTS AND ALL MEP ITEMS. REFER TO MEP DRAWINGS.
23	EXISTING GYPSUM BOARD CEILING/SOFFIT TO REMAIN. PATCH AND REPAIR CEILING AND OVERHEAD WALLS AS REQUIRED FOR NEW FINISHES.

### DEMOLITION NOTES

- A. FIELD VERIFY ALL EXISTING CONSTRUCTION CONDITIONS AND FINISHES PRIOR TO SUBMITTING A BID AND START OF ANY WORK. DISCREPANCIES IN ACTUAL CONDITIONS AND PLANS SHALL BE BROUGHT TO THE ATTENTION OF THE ARCHITECT AND/OR ENGINEER FOR EVALUATION BEFORE SUBMITTING BID AND/OR CONTINUING WITH WORK.
- B. FIELD VERIFY THE LOCATION OF ALL UTILITIES, INCLUDING BURIAL DEPTH, PRIOR TO START OF ANY WORK. CONDITIONS THAT PROHIBIT THE WORK FROM BEING PERFORMED AS SHOWN SHALL BE BROUGHT TO THE ATTENTION OF THE ARCHITECT AND/OR ENGINEER FOR EVALUATION BEFORE CONTINUING WITH WORK.
- C. VERIFY WITH THE OWNER PRIOR TO THE START OF WORK THE EXTENT OF DEMOLITION ITEMS TO BE SALVAGED.
- D. ITEMS NOT BEING SALVAGED SHALL BE TRANSPORTED AND DISPOSED OF IN A LEGAL MANNER IN ACCORDANCE WITH ALL APPLICABLE CODES.
- E. ADDITIONAL DEMOLITION WORK ASSOCIATED WITH PLUMBING, MECHANICAL, AND ELECTRICAL WORK IS REQUIRED. COORDINATE WORK REQUIRED WITH ALL TRADES.
- F. ALL DEMOLITION PLUMBING, MECHANICAL, AND ELECTRICAL WORK SHALL BE PERFORMED IN COMPLIANCE WITH ALL APPLICABLE CODES.
- G. ALL DEMOLITION WORK SHALL BE COORDINATED AND BE PERFORMED IN ACCORDANCE WITH OWNER.
- H. REMOVE AND/OR REINSTALL ALL EXISTING WALL MOUNTED DEVICE COVER PLATES INCLUDING SWITCHES, RECEPTACLES, OUTLETS, PANEL FACES, RECESSED CABINET FACES, ETC., AS REQUIRED FOR RENOVATION WORK AND PROPER INSTALLATION OF NEW FINISHES. FINISHING/PAINTING AROUND EXISTING NOTED ITEMS WILL NOT BE ACCEPTED.
- I. SEE SPECIFICATIONS FOR ADDITIONAL DEMOLITION REQUIREMENTS.
- J. CLEAN AND PREPARE ALL EXISTING SURFACES/SUBSTRATES TO REMAIN AS REQUIRED FOR PROPER INSTALLATION OF NEW FINISHES PER MANUFACTURER'S RECOMMENDATIONS.
- K. CLEAN AND PREPARE EXISTING SUBSTRATE IN ALL AREAS RECEIVING NEW FLOOR FINISHES AS REQUIRED BY RENOVATION WORK AND FOR PROPER INSTALLATION OF NEW FINISHES PER MANUFACTURER'S RECOMMENDATIONS.
- L. PERFORM DEMOLITION WORK IN A MANNER SO AS TO MINIMIZE DAMAGE TO EXISTING SURROUNDING ITEMS TO REMAIN.
- M. PATCH ALL EXISTING FLOORS, WALLS, AND CEILINGS AS REQUIRED FOR DEMOLITION AND RENOVATION WORK INCLUDING ALL PLUMBING, MECHANICAL, AND ELECTRICAL WORK.
- N. PATCH ALL EXISTING TO REMAIN FLOORS, WALLS, AND CEILINGS THAT ARE DAMAGED DURING THE COURSE OF DEMOLITION WORK INCLUDING ALL PLUMBING, MECHANICAL, AND ELECTRICAL DEMOLITION WORK.
- O. FURNISH AND INSTALL FLOOR LEVELING COMPOUND AS NECESSARY TO ACHIEVE A SMOOTH AND MONOLITHIC APPEARANCE FOR PROPER INSTALLATION OF NEW FINISHES.
- P. CUT AND PATCH EXISTING WALLS AS NECESSARY FOR RENOVATION AND DEMOLITION WORK. WALLS SHALL BE PATCHED TO MATCH ADJACENT EXISTING SURFACES AND PROVIDE A SMOOTH AND SEAMLESS TRANSITION FROM NEW TO EXISTING.
- Q. IT IS THE INTENT OF THESE DOCUMENTS THAT "PATCH" IMPLIES THAT THE EXISTING CONSTRUCTION SHALL BE REPAIRED IN A MANNER, WITH SAME OR SIMILAR MATERIALS, PROVIDING A SMOOTH AND SEAMLESS TRANSITION FROM NEW TO EXISTING MATERIALS AND THE PATCH SHALL BE PREPARED TO RECEIVE NEW FINISHES PER FINISH MANUFACTURER'S RECOMMENDATIONS.
- R. IT IS THE INTENT OF THESE DOCUMENTS THAT "PREPARED" IMPLIES THAT THE EXISTING CONSTRUCTION SHALL BE MADE READY TO RECEIVE NEW FINISHES IN ACCORDANCE WITH FINISH MANUFACTURER'S RECOMMENDATIONS.
- S. REMOVE ALL POPCORN CEILINGS FROM ALL AREAS WITHIN LIMITS OF WORK. REMOVE AND REINSTALL ALL CEILING MOUNTED DEVICES AND FIXTURES INCLUDING LIGHTS, DIFFUSERS AND GRILLES TO COMPLETELY REMOVE EXISTING POPCORN FINISH. SEE PME FOR ADDITIONAL INFORMATION.
- T. REMOVE ALL WINDOW TREATMENTS FROM ALL WINDOWS WITHIN LIMITS OF WORK AREA. PATCH AND REPAIR EXISTING CONSTRUCTION TO REMAIN AS NECESSARY.
- U. REMOVE ALL DECORATIVE DOOR TRIM ELEMENTS FROM ALL DOORS WITHIN THE LIMITS OF THE WORK AREA AND REPAIR EXISTING CONSTRUCTION TO REMAIN AS NECESSARY.
- V. REMOVE ALL MISCELLANEOUS OFFICE TYPE WALL MOUNTED ITEMS FROM THE REHAB SIDE WITHIN THE LIMITS OF THE WORK AREA AND REPAIR EXISTING CONSTRUCTION TO REMAIN AS NECESSARY.

### DEMOLITION LEGEND



	2X2 EXISTING LAY-IN CEILING WITHIN PROJECT SCOPE TO BE DEMOLISHED		2X2 EXISTING LAY IN CEILING WITHIN PROJECT SCOPE TO REMAIN
	2X4 EXISTING LAY-IN CEILING WITHIN PROJECT SCOPE TO BE DEMOLISHED		EXISTING GYPSUM BULKHEAD TO REMAIN
	AREA OF EXISTING BUILDING OUT OF SCOPE		2X4 LIGHT FIXTURE TO BE DEMOLISHED
	DASHED LINE INDICATES WALLS TO BE DEMOLISHED		SURFACE MOUNTED LIGHT FIXTURE TO BE DEMOLISHED
	SOLID LINE INDICATES WALL TO REMAIN		RECESSED CAN LIGHT TO BE DEMOLISHED
	SOLID FILL INDICATES EXISTING MASONRY WALL TO REMAIN		DEMOLITION KEYNOTE TAG

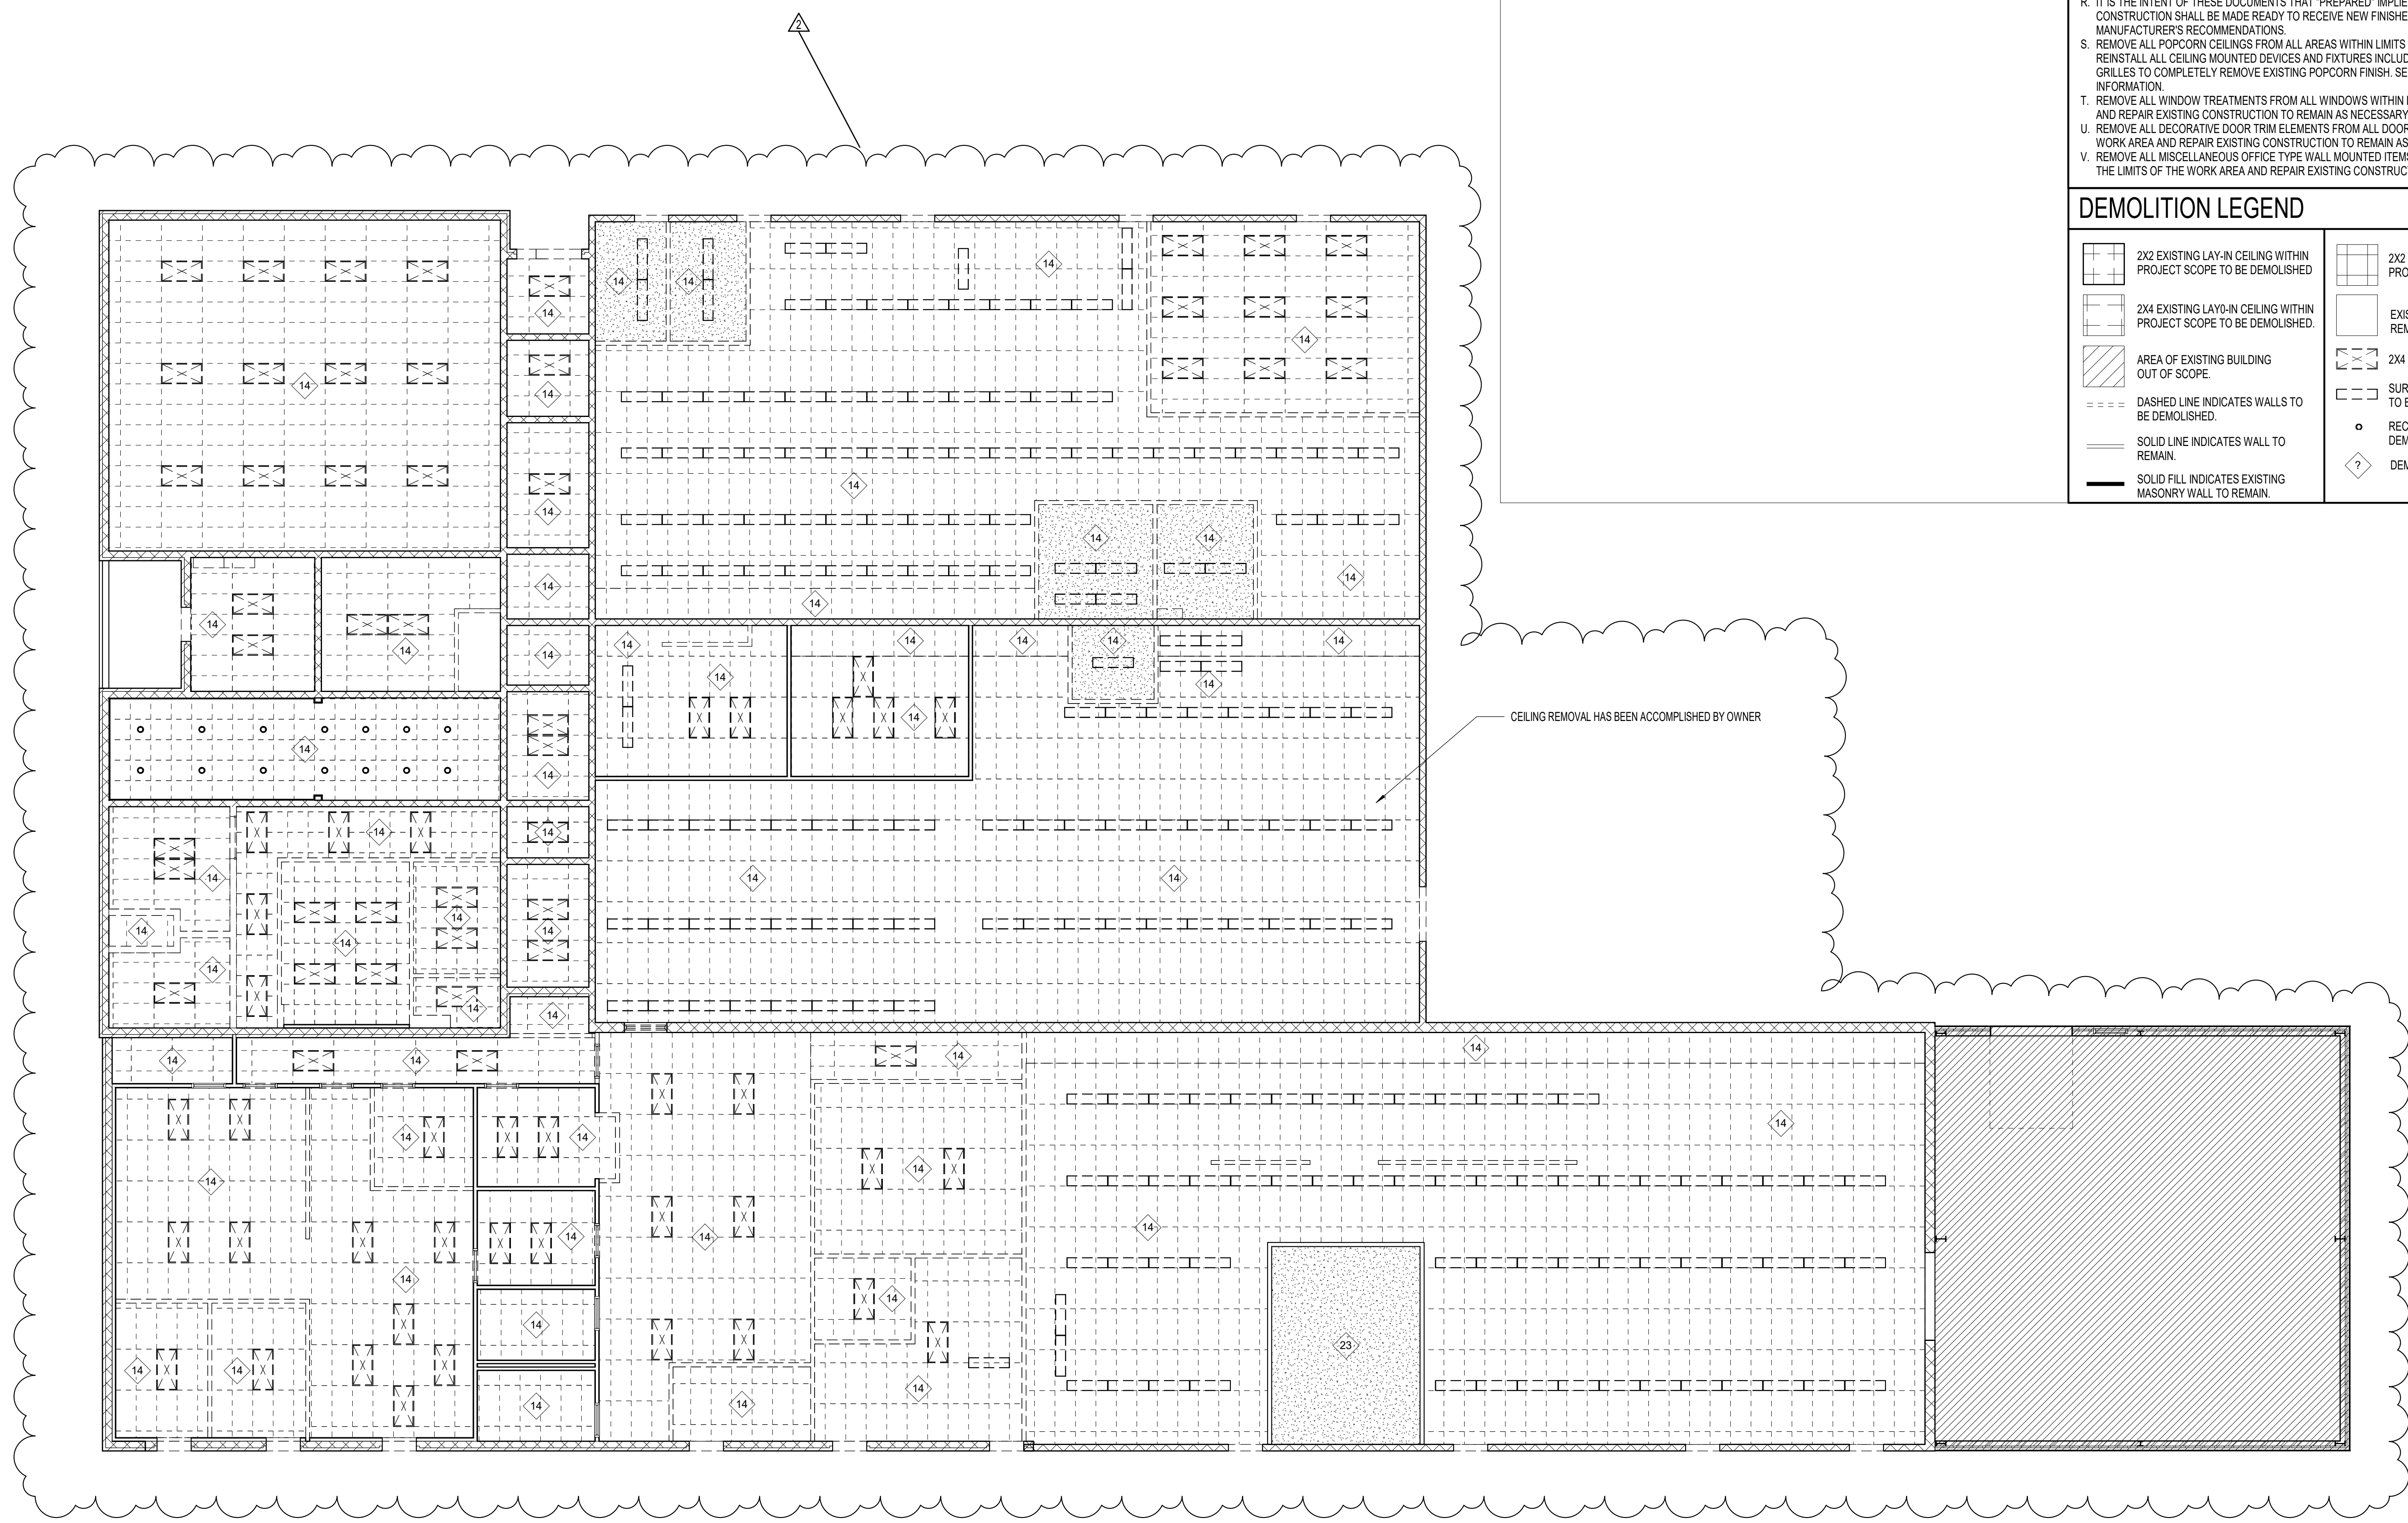

**1**  
**D1.2** DEMOLITION REFLECTED CEILING PLANS  
1/8" = 1'-0"

**OAKLEY  
COLLIER  
ARCHITECTS**  
OCA ARCHITECTS  
107 Condoverwood Road, Rocky Mount, NC 27854, (919) 352-9373, 2500  
305 N. Main Street, Raleigh, NC 27601

RENOVATION FOR:  
**PROVALUS**  
CITY OF WHITEVILLE  
127 W COLUMBUS ST., WHITEVILLE, NC

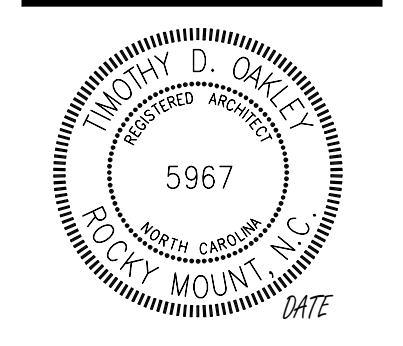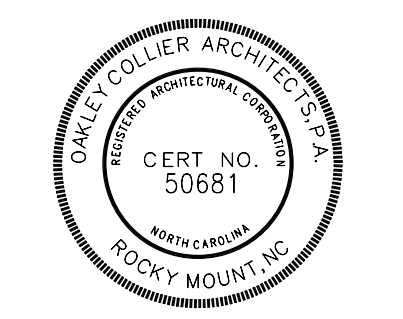

GENERAL NOTE:  
Prior to construction start, Contractor shall verify & be responsible for all Dimensions.

Revisions	Description	Date
2	BD ADD: 2	11/07/2024

Date: 10/30/2024  
Project No: **24002**

Drawn By: AV  
Checked By: DG  
Sheet Title: **D1.2**

DEMOLITION - REFLECTED CEILING PLAN


Copyright © 2023 Oakley Collier Architects. These drawings are of the property of the Architect for use under his supervision. No reproduction or other use is allowed without permission.

### GENERAL ROOF NOTES

- GUTTER AND DOWNSPOUTS SHALL BE FURNISHED AND INSTALLED BY ROOFING CONTRACTOR.
- CONTRACTOR SHALL COORDINATE ALL ROOF MOUNTED EQUIPMENT AND PENETRATIONS REQUIRED AND MAKE ALL NECESSARY PROVISIONS FOR SAME.
- GUTTERS, DOWNSPOUTS AND COMPONENTS SHALL BE PREFINISHED ALUMINUM COLOR - PER ARCHITECT.
- ALL DOWNSPOUTS SHALL TURN INTO STORM DRAIN. REFER TO FLOOR PLAN FOR MORE INFORMATION.
- ALL ROOF MOUNTED ITEMS SHALL BE PAINTED, CLEAN PREPARE AND PRIME SURFACES AS REQUIRED - COLOR PER ARCHITECT.
- FURNISH AND INSTALL 36" WIDE X LENGTH REQUIRED SELF ADHERED ICE AND WATER SHIELD ROOFING UNDERLAYMENT AT ALL EDGES, RIDGES, HIPS, AND VALLEYS.
- EXISTING TO REMAIN ROOF IS REPORTEDLY 8-YEARS OLD. NEW ROOF WORK ANTICIPATED ONLY AS REQUIRED TO ACCOMMODATE NEW EQUIPMENT AND/OR ROOF PENETRATIONS. COORDINATE WITH MEP DRAWING SHEETS.

### ROOF LEGEND

- INDICATES DIRECTION OF ROOF SLOPE ACHIEVED THRU STRUCTURE AND TAPERED INSULATION
- INDICATES THICKNESS OF TAPERED INSULATION ABOVE PRIMARY ROOF INSULATION AND UNDERLAYMENT BOARD IF REQUIRED - REFER TO WALL SECTIONS AND STRUCTURAL FOR ACTUAL ELEVATIONS
- RD PRIMARY ROOF DRAIN, REFER TO PLUMBING PLANS FOR DESCRIPTION, TYPICAL.
- OD SECONDARY (EMERGENCY) ROOF DRAIN, REFER TO PLUMBING PLANS FOR DESCRIPTION, TYPICAL.
- SC THROUGH WALL SCUPPER SECONDARY (EMERGENCY) ROOF DRAIN, TYPICAL.

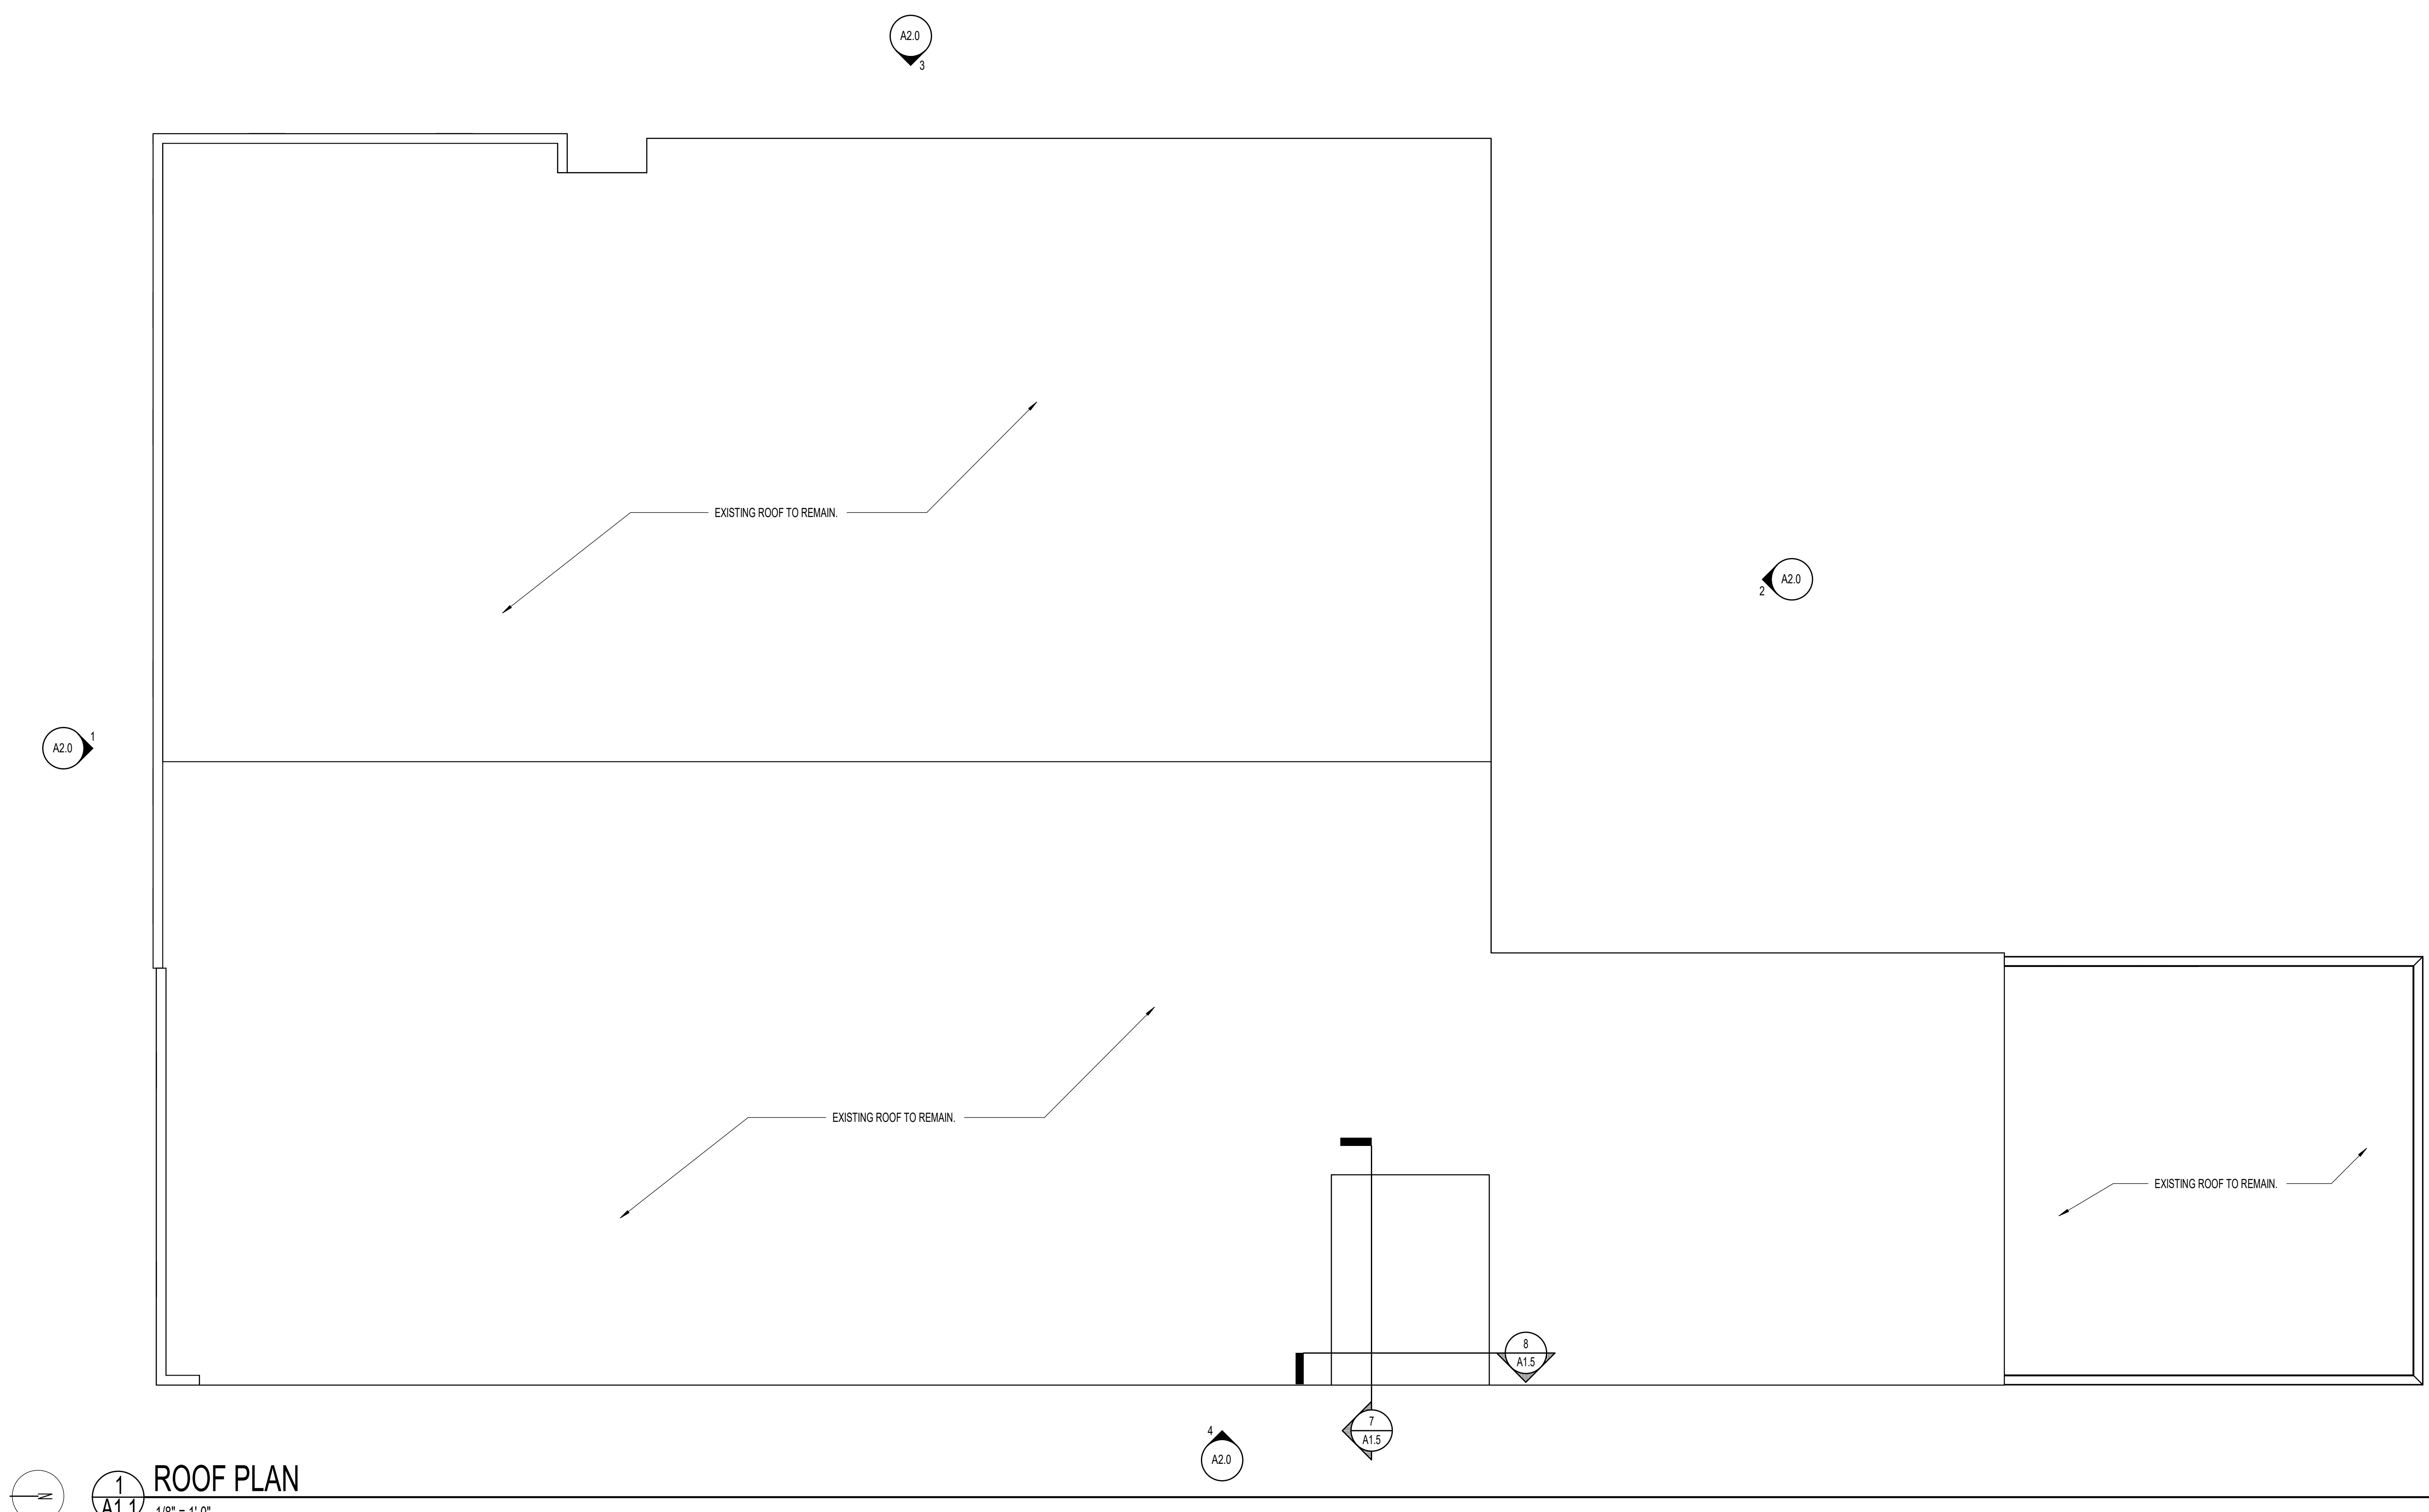


1  
A1.1  
1/8" = 1'-0"

## ROOF PLAN

**OAKLEY COLLIER ARCHITECTS**  
OCA ARCHITECTS

157 Condrews Road, Rocky Mount, NC 27854, (919) 352-9372/2500  
305 N. Hudson Street, Raleigh, NC 27601

RENOVATION FOR:  
**PROVALUS**  
CITY OF WHITEVILLE  
127 W COLUMBUS ST., WHITEVILLE, NC

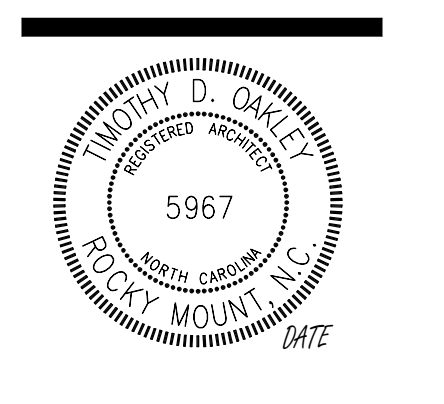

GENERAL NOTE:  
Prior to construction start, Contractor shall verify & be responsible for all Dimensions.

Revisions	Description	Date
1	BD ADD: 1	11/09/2024

Date	Project No.
10/30/2024	24002
Drawn By	Sheet No.
AV	A1.1
Checked By	Sheet Title
DG	ROOF PLAN




Copyright © 2023 Oakley/Collier Architects. These drawings are the property of the Architect for use under his supervision. No reproduction or other use is allowed without permission.

### CEILING NOTES



A. SEE MECHANICAL, ELECTRICAL, PLUMBING, AND FIRE PROTECTION PLANS FOR FULL DESCRIPTION OF CEILING MOUNTED ITEMS/DEVICES.  
 B. ALL GRIDS ARE CENTERED IN A ROOM UNLESS NOTED OTHERWISE.  
 C. REFER TO REFLECTED CEILING PLANS FOR CEILING HEIGHTS AND FINISH PLANS FOR CEILING TYPES.  
 D. CONTRACTOR TO REVIEW LAYOUT AND NOTIFY ARCHITECT OF ACoustICAL CEILING PANELS THAT ARE LESS THAN 3' IN WIDTH OR LENGTH.  
 E. ALL NEW LIGHT FIXTURES, EXIT SIGNS, SPRINKLER HEADS AND TERMINAL DEVICES TO BE CENTERED IN CEILING PANELS, UNLESS OTHERWISE INDICATED.  
 F. NOT ALL MEP DEVICES ARE SHOWN IN CEILING PLANS, SEE MEP DRAWINGS FOR LOCATIONS AND QUANTITIES.  
 G. FOR PENDANT MOUNTING HEIGHT REFER TO ELEVATIONS AND REFLECTED CEILING PLAN LEGEND.

### CEILING LEGEND

	4X4 LAY-IN CEILING SYSTEM
	5/8" GYPSUM BOARD
	CEILING HEIGHT KEY
	2 x 4 LIGHT FIXTURE
	HIGH BAY LED LIGHTING FIXTURE
	8' BAR LIGHT FIXTURE
	6' BAR LIGHT FIXTURE
	4' BAR LIGHT FIXTURE
	2' BAR LIGHT FIXTURE
	HIGH BAY LED LIGHTING FIXTURE
	CAN LIGHT FIXTURE
	LED VERTICAL PENDANT FIXTURE
	WALL MOUNTED TELEVISION

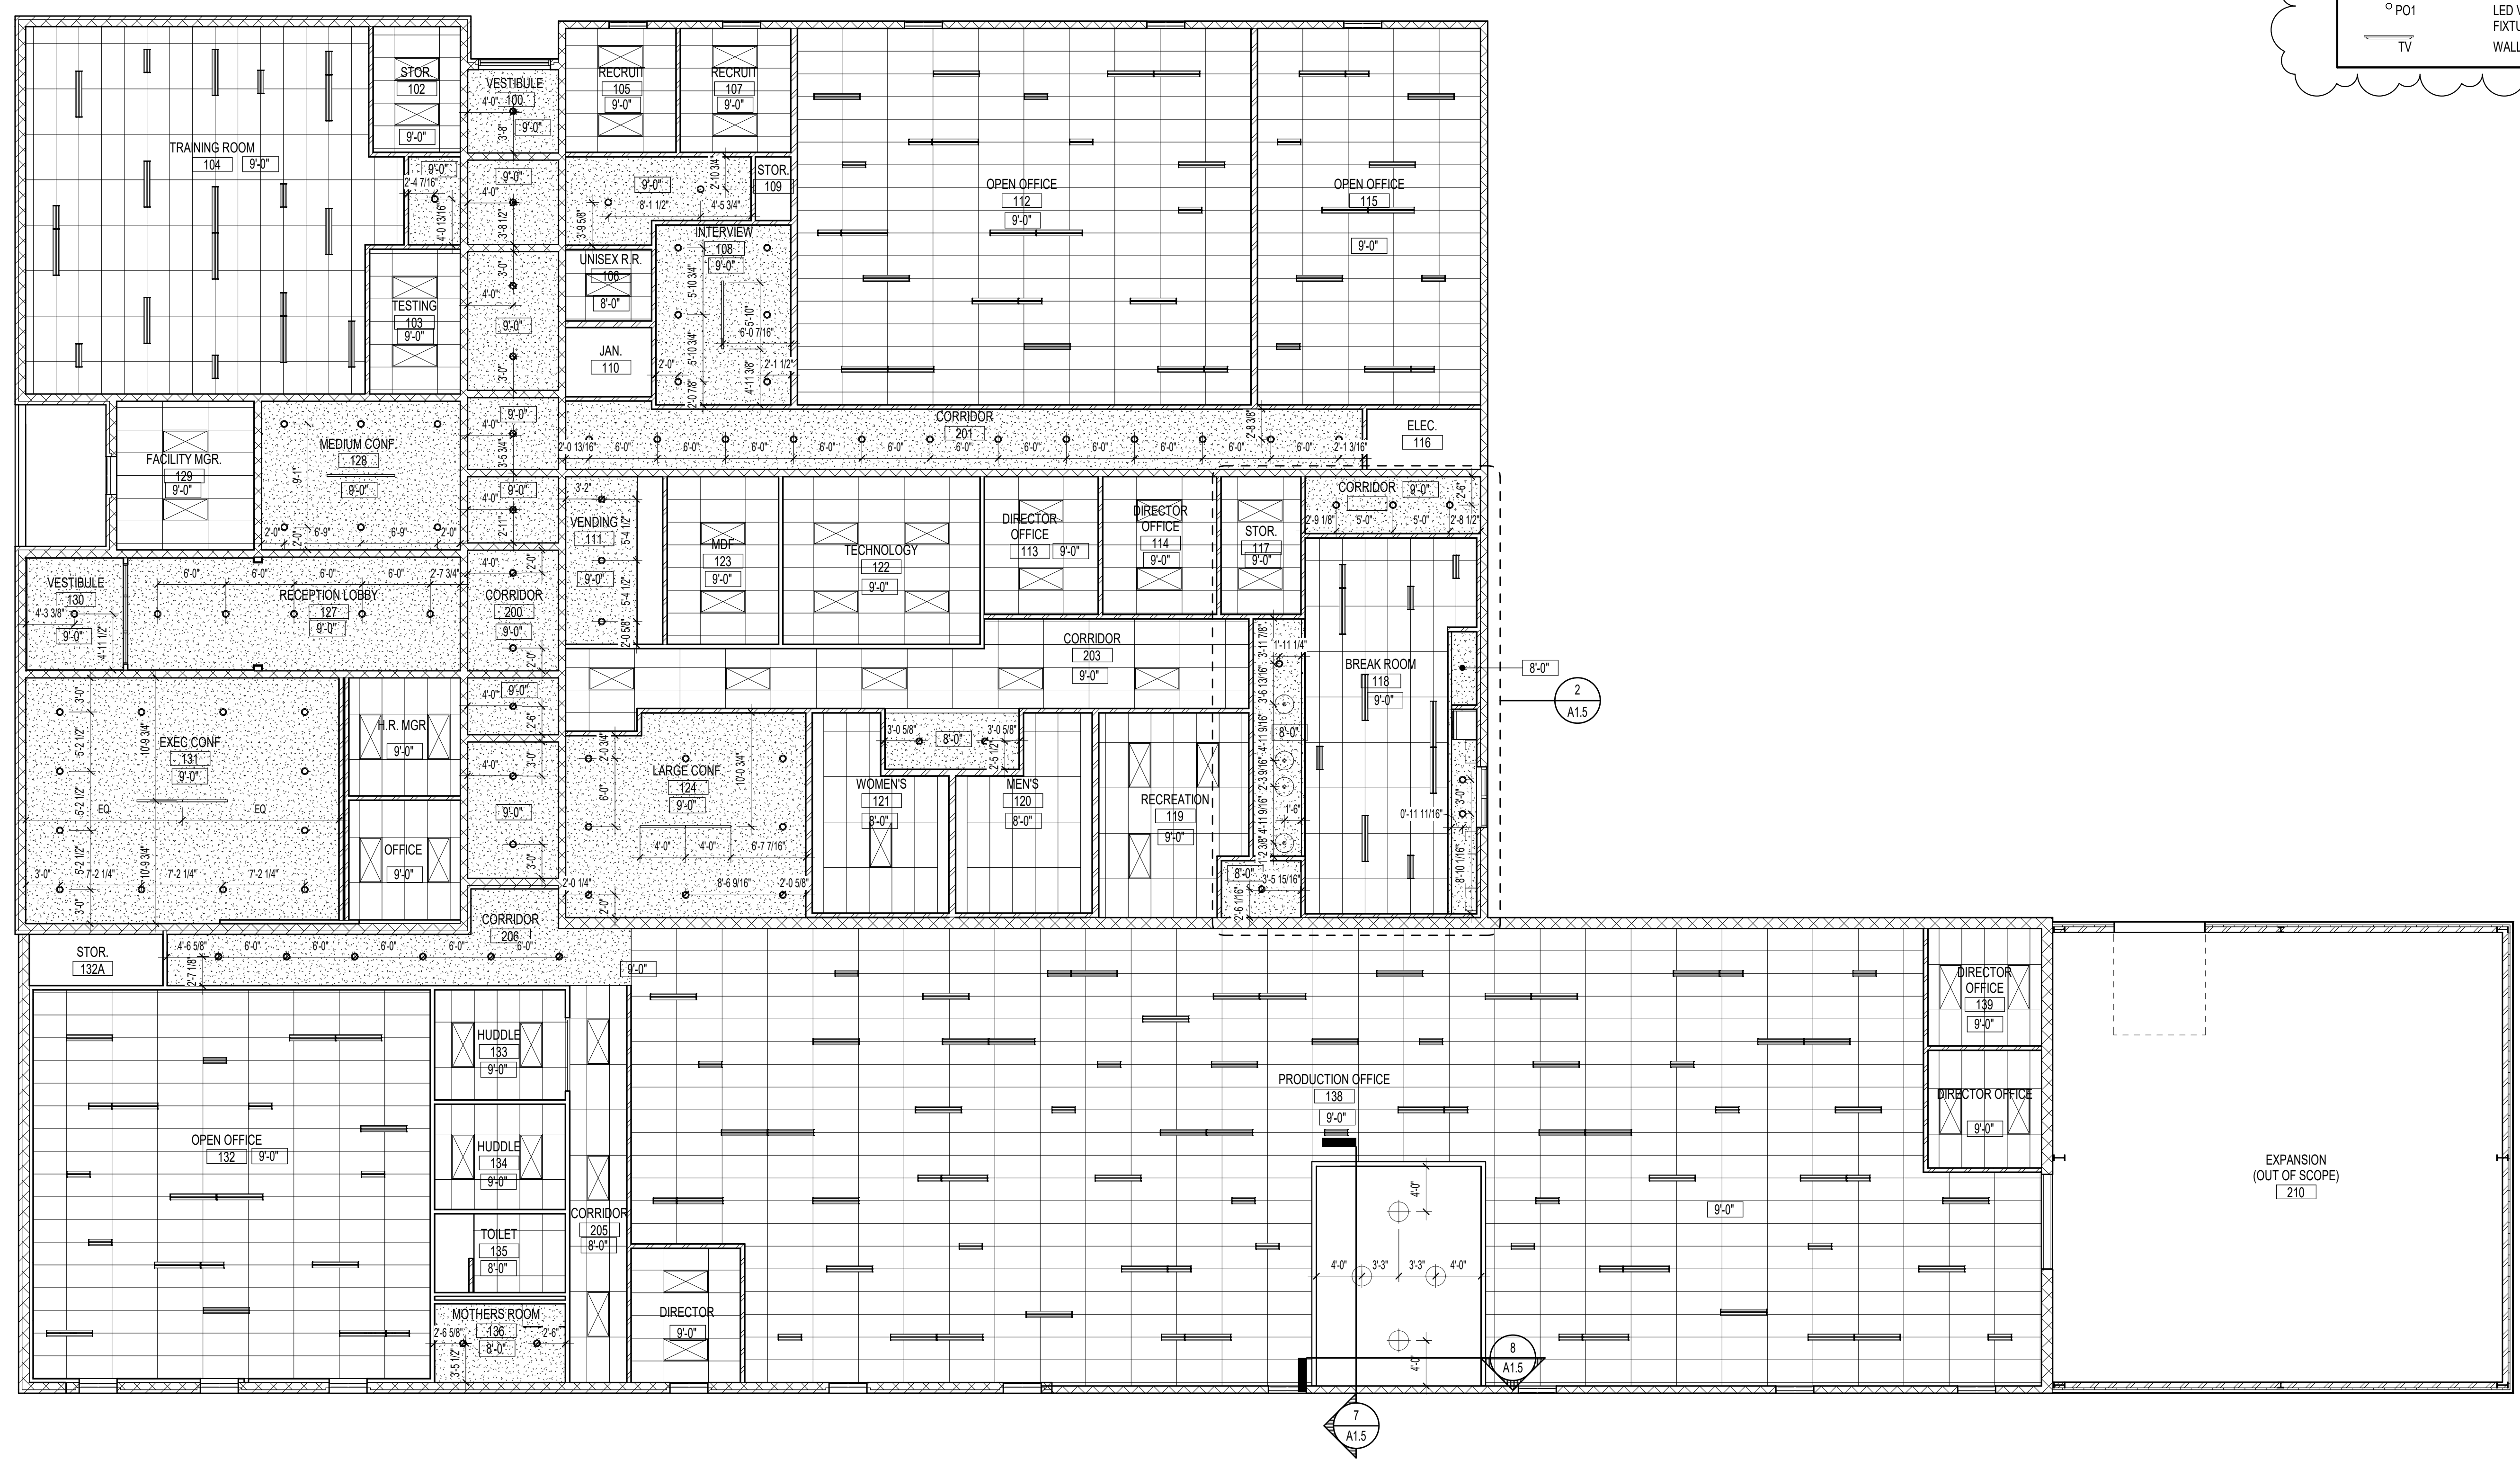

**1**  
A1.2 REFLECTED CEILING PLAN  
1/8" = 1'-0"

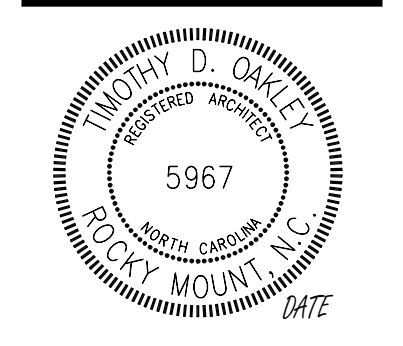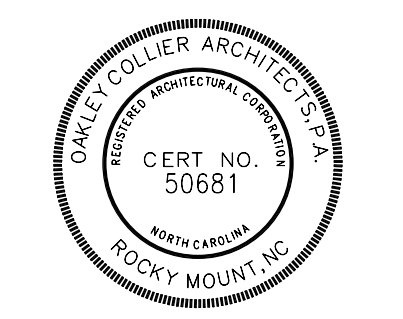

GENERAL NOTE:  
 Prior to construction start, Contractor shall verify & be responsible for all Dimensions.

Revisions	Description	Date
2	BD ADD: 2	11/07/2024

Date: 10/30/2024  
 Project No: **24002**

Drawn By: AV / RL  
 Checked By: DG  
 Sheet No: **A1.2**

Sheet Title:  
**REFLECTED CEILING PLAN**




Copyright © 2023 Oakley Collier Architects. These drawings are the property of the Architect for use under his supervision. No reproduction or other use is allowed without permission.

**TOILET ACCESSORIES SCHEDULE**

TAG	DESCRIPTION	MANUF.	MODEL NO.	MOUNTING HEIGHT
PT	PAPER TOWEL DISPENSER	A.S.I.	20210	48" TO SLOT
SD	SURFACE MOUNTED SOAP DISPENSER	A.S.I.	9343	50 7/8" TO TOP
M	4' X 42" MIRROR	-	-	40" TO BOTTOM
M4	4' X 6' MIRROR	-	-	40" TO BOTTOM
CS	CHANGING STATION	A.S.I.	9013-9	32" ABV. FF
TD	DOUBLE ROLL TISSUE DISPENSER	A.S.I.	10-9030	27" C.L.
GB36	1 1/2" DIA. X 36" S.S. GRAB BAR - PEENED	A.S.I.	3800-36P	34" C.L.
GB42	1 1/2" DIA. X 42" S.S. GRAB BAR - PEENED	A.S.I.	3800-42P	34" C.L.
GB18	1 1/2" DIA. X 18" S.S. (VERTICAL) GRAB BAR - PEENED	A.S.I.	3800-18P	39" TO BOTTOM
TS	PLASTIC LAMINATE TOILET PARTITION	A.S.I.	-	-
SN	SANITARY DISPENSER	A.S.I.	-	16" TO BOTTOM
DH	ROBE HOOK	A.S.I.	7306	46" ABV. FF
SP	SHOWER INSERT	BRADLEY 3x3'	-	-

- ALL TOILET ACCESSORIES SHALL BE INSTALLED PER MANUFACTURER'S RECOMMENDATIONS FOR SPECIFIC APPLICATIONS IN COMPLIANCE WITH ALL APPLICABLE CODES.
- WHERE INDICATED AND AS REQUIRED, TOILET ACCESSORY INSTALLATION SHALL COMPLY WITH NC ACCESSIBILITY CODE.
- FINISH AND INSTALL ALL NECESSARY FRAMING AND BLOCKING AS REQUIRED FOR PROPER INSTALLATION AND OPERATION OF ALL ACCESSORIES.
- MANUFACTURER AND MODEL NUMBERS INDICATED REPRESENT BASIS OF DESIGN. APPROVED SUBSTITUTIONS WILL BE ACCEPTED.

**HC ACCESSORIES LEGEND**

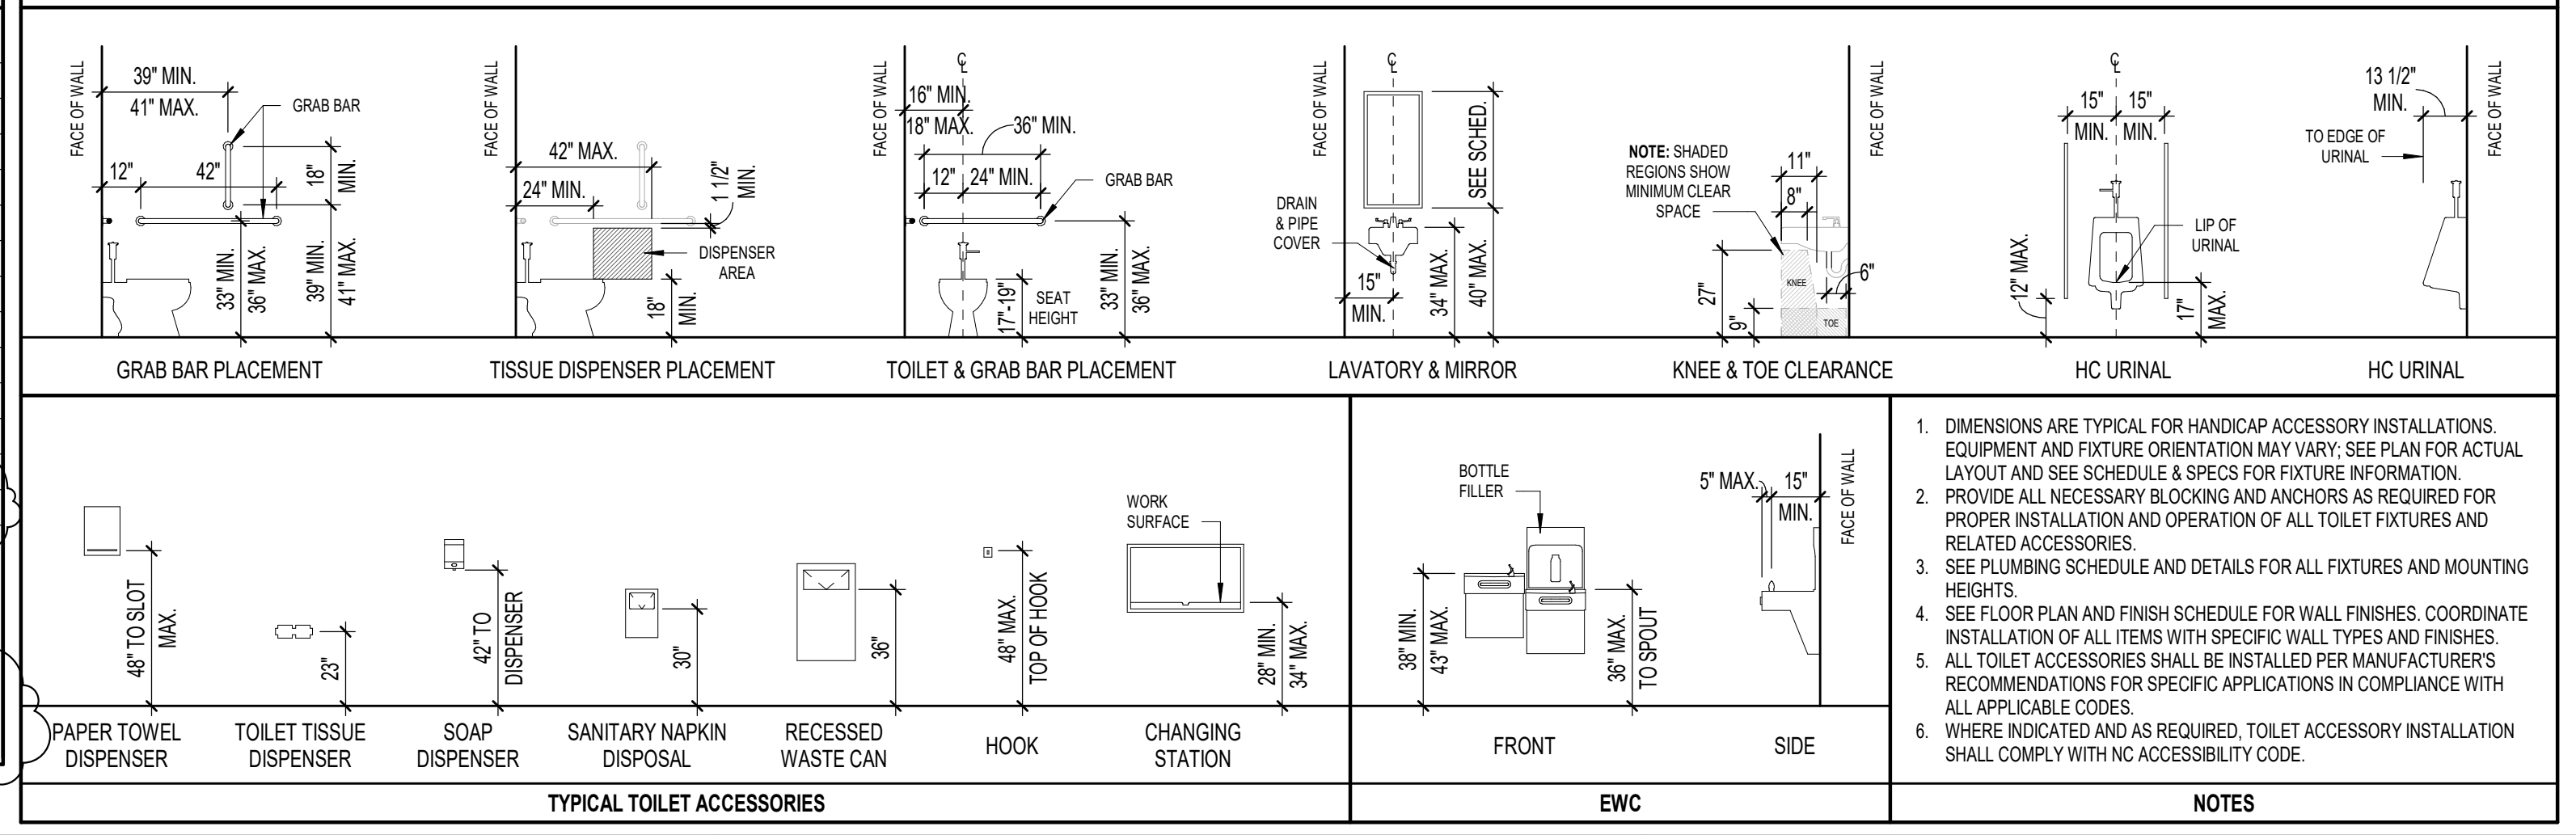

- DIMENSIONS ARE TYPICAL FOR HANDICAP ACCESSORY INSTALLATIONS. EQUIPMENT AND FIXTURE ORIENTATION MAY VARY. SEE PLAN FOR ACTUAL LAYOUT AND SEE SCHEDULE & SPECS FOR FIXTURE INFORMATION.
- PROVIDE ALL NECESSARY BLOCKING AND ANCHORS AS REQUIRED FOR PROPER INSTALLATION AND OPERATION OF ALL TOILET FIXTURES AND RELATED ACCESSORIES.
- SEE PLUMBING SCHEDULE AND DETAILS FOR ALL FIXTURES AND MOUNTING HEIGHTS.
- SEE FLOOR PLAN AND FINISH SCHEDULE FOR WALL FINISHES. COORDINATE INSTALLATION OF ALL ITEMS WITH SPECIFIC WALL TYPES AND FINISHES.
- ALL TOILET ACCESSORIES SHALL BE INSTALLED PER MANUFACTURER'S RECOMMENDATIONS FOR SPECIFIC APPLICATIONS IN COMPLIANCE WITH ALL APPLICABLE CODES.
- WHERE INDICATED AND AS REQUIRED, TOILET ACCESSORY INSTALLATION SHALL COMPLY WITH NC ACCESSIBILITY CODE.

**11 ELEVATION - UNISEX 135 #3**  
A1.6 1/4" = 1'-0"

**7 ELEVATION - MEN'S R.R. #3**  
A1.6 1/4" = 1'-0"

**4 ELEVATION - WOMEN'S R.R. #3**  
A1.6 1/4" = 1'-0"

**13 ELEVATION - MOTHERS 136**  
A1.6 1/4" = 1'-0"

**10 ELEVATION - UNISEX 135 #2**  
A1.6 1/4" = 1'-0"

**6 ELEVATION - MEN'S R.R. #2**  
A1.6 1/4" = 1'-0"

**3 ELEVATION - WOMEN'S R.R. #2**  
A1.6 1/4" = 1'-0"

**15 ELEVATION - UNISEX 106**  
A1.6 1/4" = 1'-0"

**12 ELEVATION - UNISEX 135 #4**  
A1.6 1/4" = 1'-0"

**9 ELEVATION - UNISEX 135 #1**  
A1.6 1/4" = 1'-0"






**5 ELEVATION - MEN'S R.R. #1**  
A1.6 1/4" = 1'-0"

**2 ELEVATION - WOMEN'S R.R. #1**  
A1.6 1/4" = 1'-0"

**14 ENLARGED PLAN - UNISEX 106**  
A1.6 1/4" = 1'-0"

**8 ENLARGED PLAN - UNISEX/MOTHERS**  
A1.6 1/4" = 1'-0"

**1 ENLARGED PLAN - RESTROOM**  
A1.6 1/4" = 1'-0"

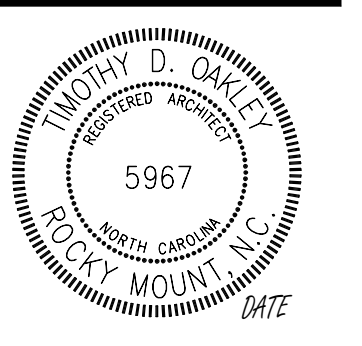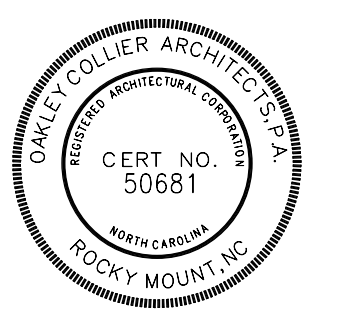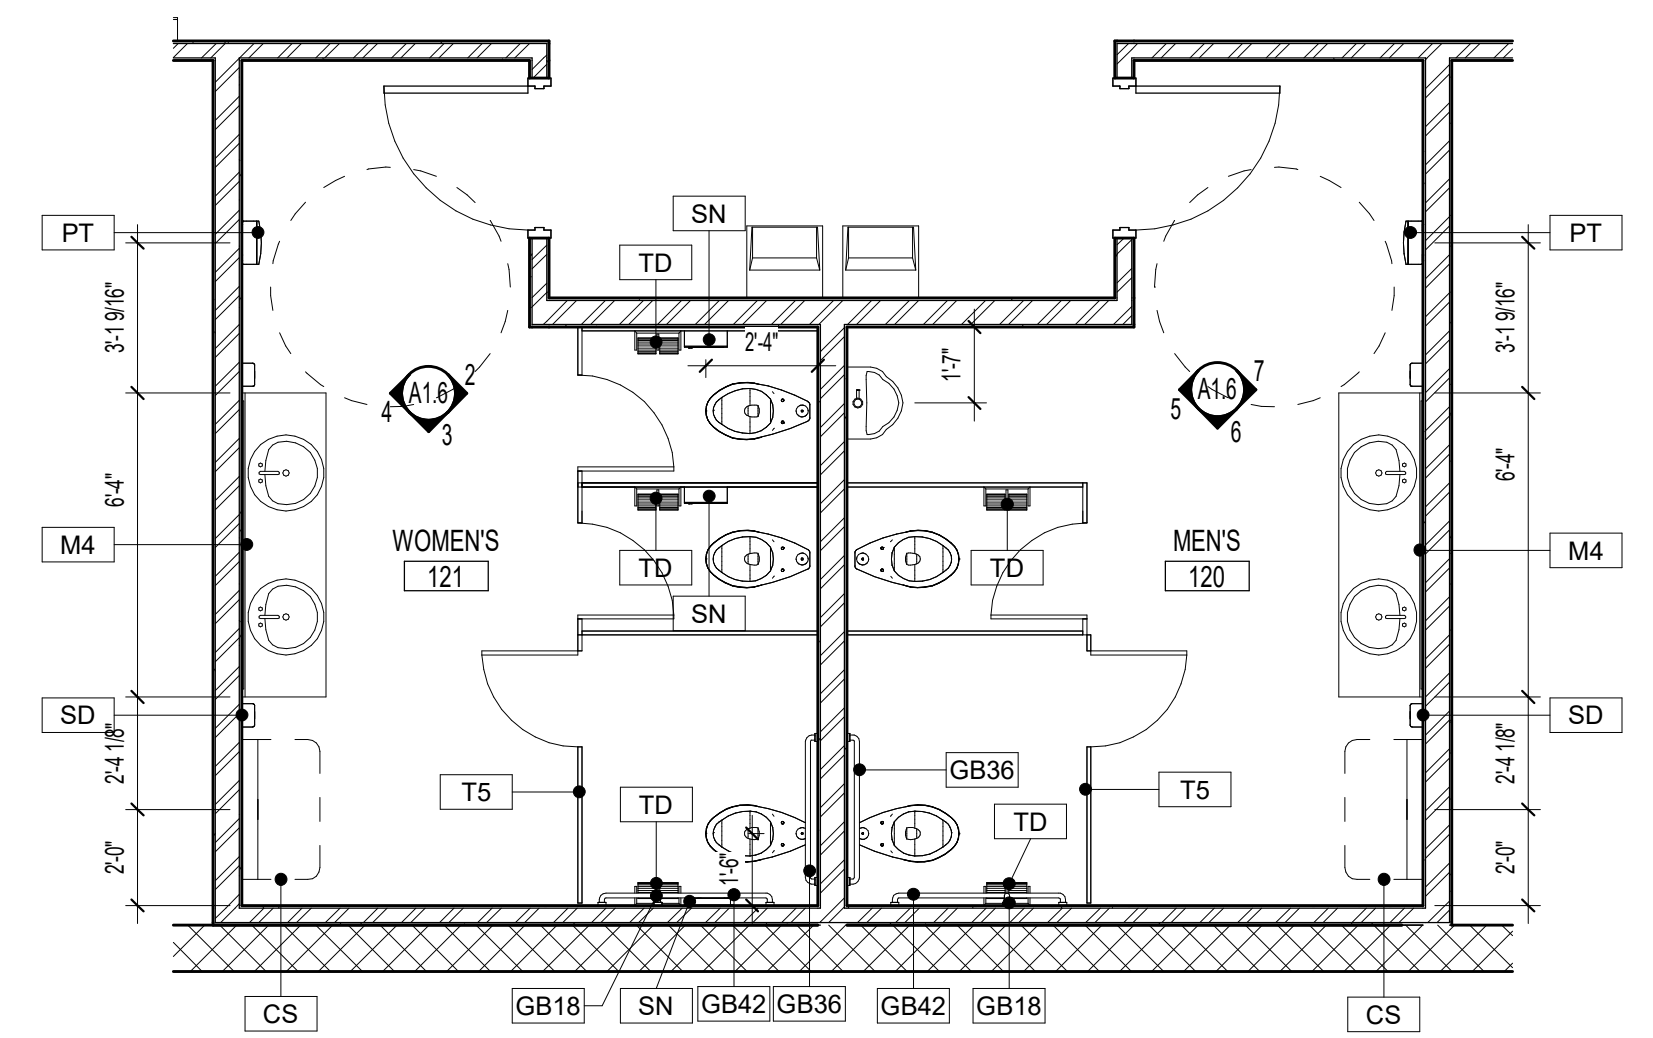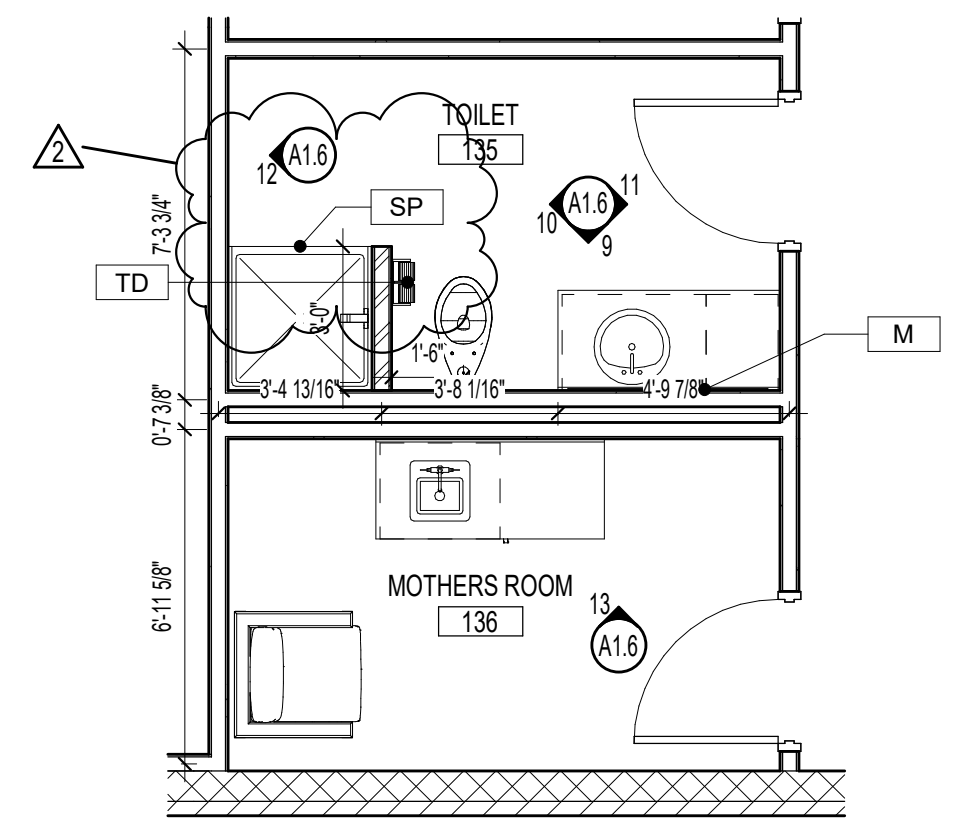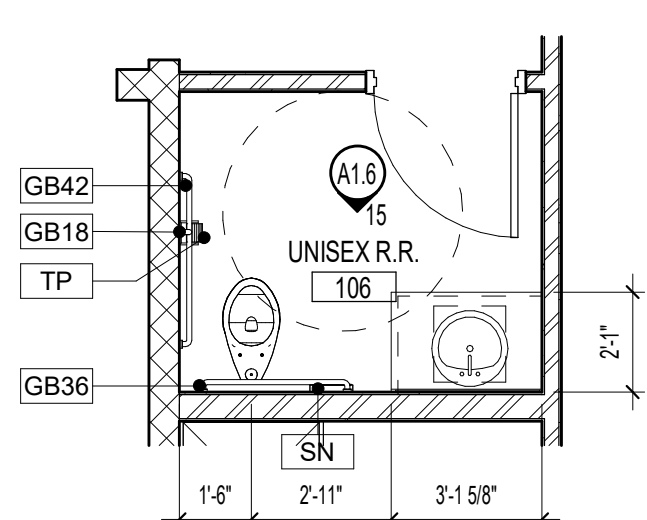


GENERAL NOTE:  
Prior to construction start, Contractor shall verify & be responsible for all Dimensions.

Revisions	Description	Date
1	BD ADD: 1	11/09/2024
2	BD ADD: 2	11/07/2024


Date: 10/30/2024  
Project No: **24002**

Drawn By: AV / RL  
Checked By: DG  
Sheet No: **A1.6**


Sheet Title: ENLARGED RESTROOM PLANS

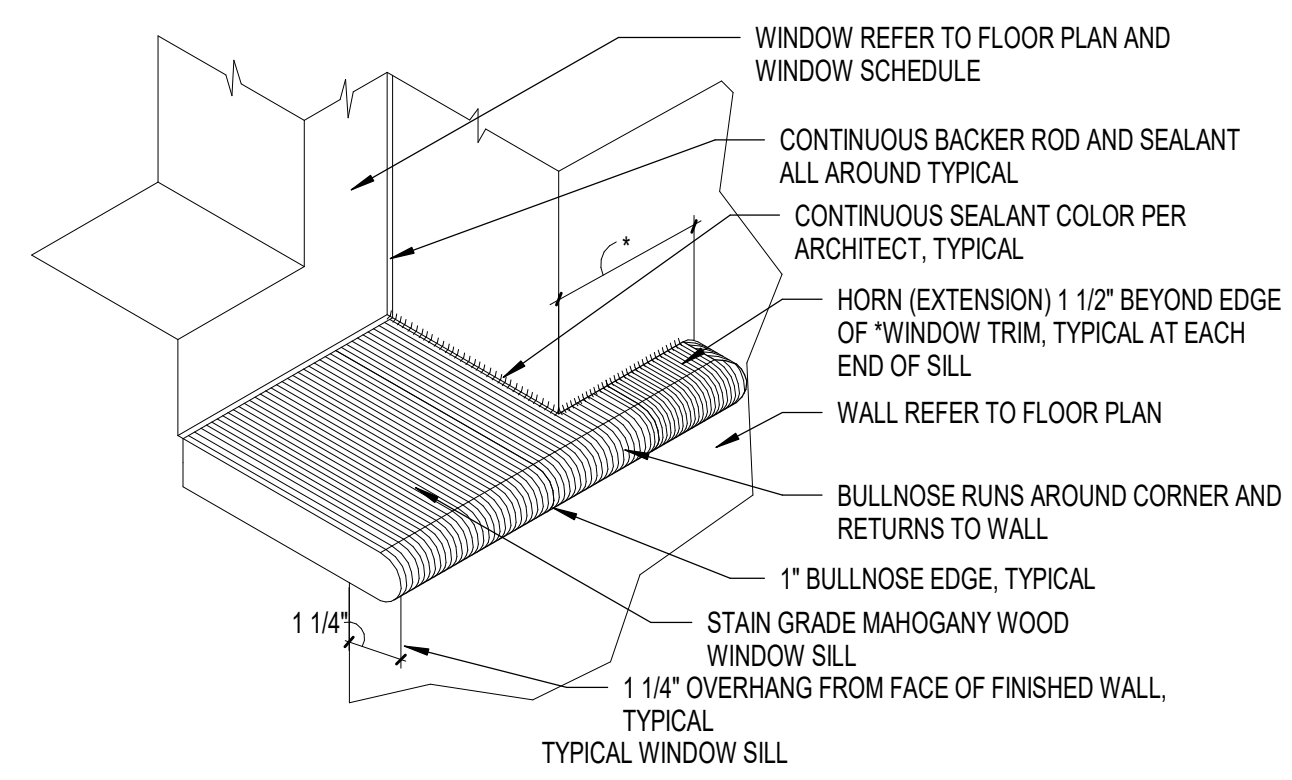


**9**  
A6.1  
SILL DETAIL  
1/4\"/>

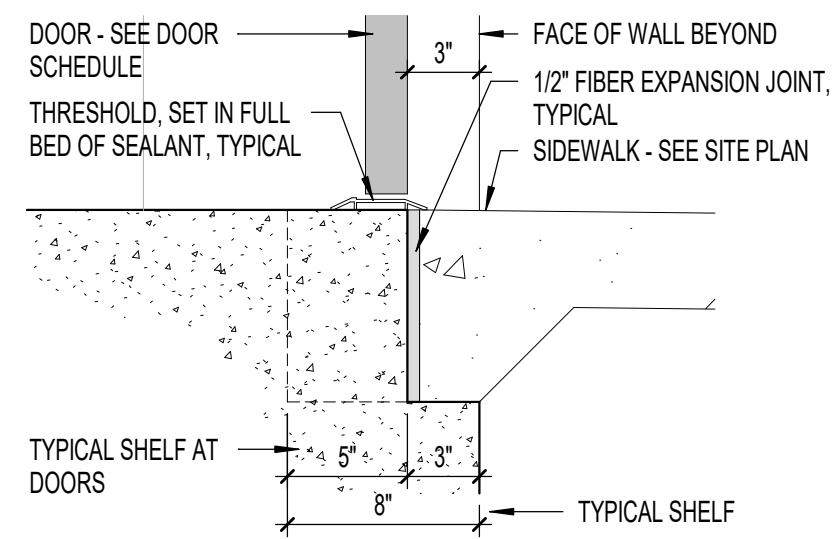


**8**  
A6.1  
SILL DETAIL  
1 1/2\"/>

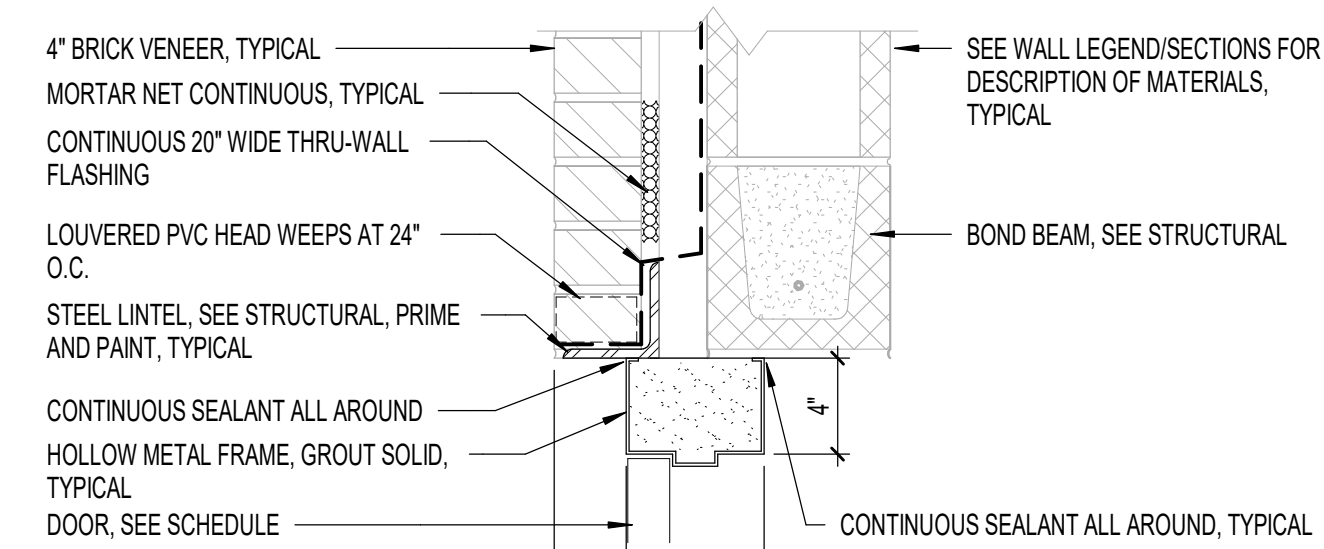


**7**  
A6.1  
DOOR - HEAD  
1 1/2\"/>

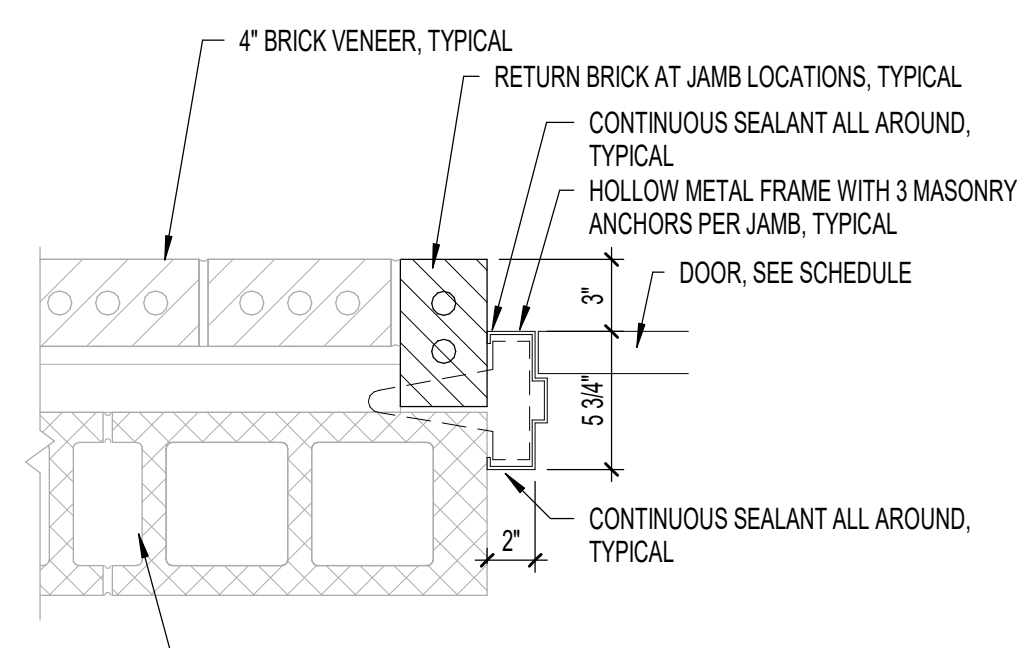


**6**  
A6.1  
DOOR - JAMB  
1 1/2\"/>

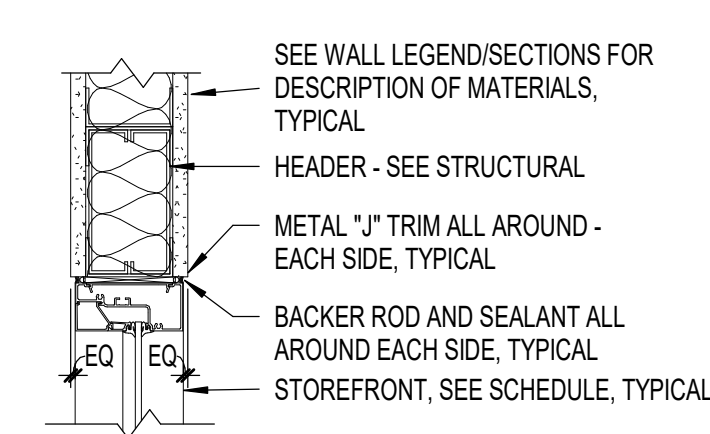

**5**  
A6.1  
WINDOW - HEAD - INT SF  
1 1/2\"/>

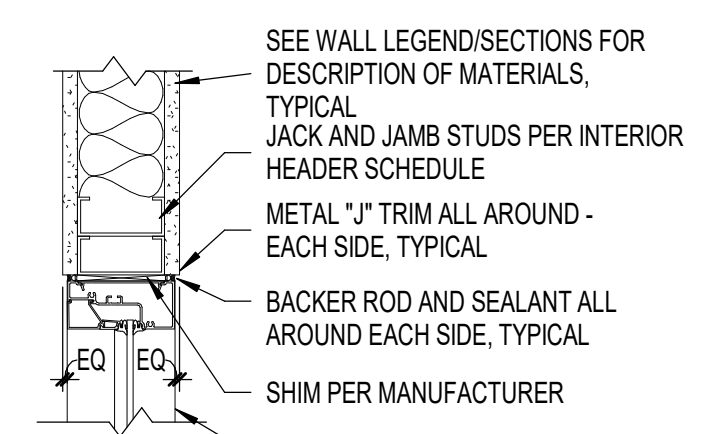

**4**  
A6.1  
WINDOW - JAMB PARALLEL - INT SF  
1 1/2\"/>

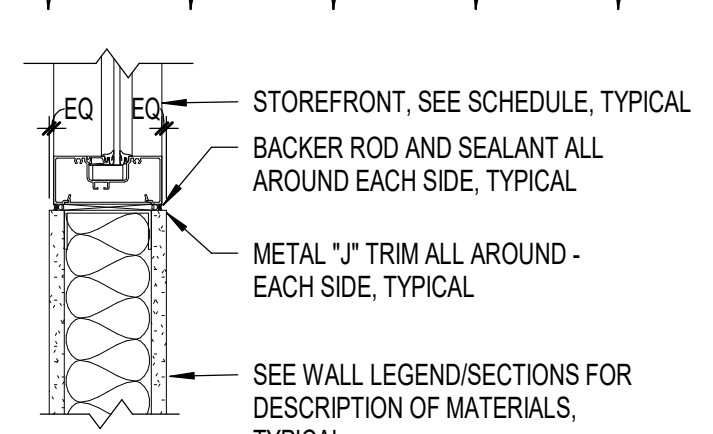


**10**  
A6.1  
WINDOW - SILL - INT SF  
1 1/2\"/>

**DOOR SCHEDULE**


DOOR NUMBER	SIZE			DOOR					FRAME				REMARKS
	WIDTH	HEIGHT	THICKNESS	MATERIAL	FINISH	DESCRIPTION	ELEVATION	RATING	MATERIAL	FINISH	ELEVATION	RATING	
100A	6'-0"	7'-0"	1 3/4"	HOLLOW METAL	PAINTED	1/4" TEMPERED	D6	N/A	HOLLOW METAL	PAINTED	F2	N/A	
100B	3'-0"	7'-0"	1 3/4"	SC WOOD	PAINTED	1/4" TEMPERED	D4	N/A	HOLLOW METAL	PAINTED	F4	N/A	
102	3'-0"	7'-0"	1 3/4"	SC WOOD	PAINTED	N/A	D1	N/A	HOLLOW METAL	PAINTED	F1	N/A	
103	3'-0"	7'-0"	1 3/4"	SC WOOD	PAINTED	1/4" TEMPERED	D2	N/A	HOLLOW METAL	PAINTED	F1	N/A	
104A	3'-0"	7'-0"	1 3/4"	SC WOOD	PAINTED	1/4" TEMPERED	D4	N/A	HOLLOW METAL	PAINTED	F4	N/A	
105	3'-0"	7'-0"	1 3/4"	SC WOOD	PAINTED	1/4" TEMPERED	D2	N/A	HOLLOW METAL	PAINTED	F1	N/A	
106	3'-0"	7'-0"	1 3/4"	SC WOOD	PAINTED	N/A	D1	N/A	HOLLOW METAL	PAINTED	F1	N/A	
107	3'-0"	7'-0"	1 3/4"	SC WOOD	PAINTED	1/4" TEMPERED	D2	N/A	HOLLOW METAL	PAINTED	F1	N/A	
108A	3'-0"	7'-0"	1 3/4"	SC WOOD	PAINTED	1/4" TEMPERED	D2	N/A	HOLLOW METAL	PAINTED	F1	N/A	
108B	3'-0"	7'-0"	1 3/4"	SC WOOD	PAINTED	1/4" TEMPERED	D2	N/A	HOLLOW METAL	PAINTED	F1	N/A	
109	2'-8"	7'-0"	1 3/4"	SC WOOD	PAINTED	N/A	D1	N/A	HOLLOW METAL	PAINTED	F1	N/A	
110	3'-0"	7'-0"	1 3/4"	SC WOOD	PAINTED	N/A	D1	N/A	HOLLOW METAL	PAINTED	F1	N/A	
112A	3'-0"	7'-0"	1 3/4"	SC WOOD	PAINTED	1/4" TEMPERED	D4	N/A	HOLLOW METAL	PAINTED	F1	N/A	
112B	3'-0"	7'-0"	1 3/4"	SC WOOD	PAINTED	1/4" TEMPERED	D4	N/A	HOLLOW METAL	PAINTED	F1	N/A	
113	3'-0"	7'-0"	1 3/4"	SC WOOD	PAINTED	1/4" TEMPERED	D2	N/A	HOLLOW METAL	PAINTED	F4	N/A	
114	3'-0"	7'-0"	1 3/4"	SC WOOD	PAINTED	1/4" TEMPERED	D2	N/A	HOLLOW METAL	PAINTED	F4	N/A	
115	3'-0"	7'-0"	1 3/4"	ALUM. STOREFRONT	ALUMINUM	1/4" TEMPERED	D4	N/A	ALUM. STOREFRONT	ALUMINUM	S3	N/A	
116	3'-0"	7'-0"	1 3/4"	SC WOOD	PAINTED	N/A	D1	N/A	HOLLOW METAL	PAINTED	F1	N/A	
117	3'-0"	7'-0"	1 3/4"	SC WOOD	PAINTED	N/A	D1	N/A	HOLLOW METAL	PAINTED	F1	N/A	
118A	3'-0"	7'-0"	1 3/4"	SC WOOD	PAINTED	1/4" TEMPERED	D3	N/A	HOLLOW METAL	PAINTED	F1	N/A	
118B	3'-0"	7'-0"	1 3/4"	SC WOOD	PAINTED	1/4" TEMPERED	D3	N/A	HOLLOW METAL	PAINTED	F1	N/A	
118C	3'-0"	7'-0"	1 3/4"	SC WOOD	PAINTED	1/4" TEMPERED	D3	N/A	HOLLOW METAL	PAINTED	F1	N/A	
118A	3'-0"	7'-0"	1 3/4"	SC WOOD	PAINTED	1/4" TEMPERED	D3	N/A	HOLLOW METAL	PAINTED	F1	N/A	
119B	3'-0"	7'-0"	1 3/4"	SC WOOD	PAINTED	1/4" TEMPERED	D3	N/A	HOLLOW METAL	PAINTED	F1	N/A	
120	3'-0"	7'-0"	1 3/4"	SC WOOD	PAINTED	N/A	D1	N/A	HOLLOW METAL	PAINTED	F1	N/A	
121	3'-0"	7'-0"	1 3/4"	SC WOOD	PAINTED	N/A	D1	N/A	HOLLOW METAL	PAINTED	F1	N/A	
124	3'-0"	7'-0"	1 3/4"	SC WOOD	PAINTED	N/A	D2	N/A	HOLLOW METAL	PAINTED	F4	N/A	
126	3'-0"	7'-0"	1 3/4"	SC WOOD	PAINTED	1/4" TEMPERED	D2	N/A	HOLLOW METAL	PAINTED	F1	N/A	
127	3'-0"	7'-0"	1 3/4"	ALUM. STOREFRONT	ALUMINUM	1/4" TEMPERED	D4	N/A	ALUM. STOREFRONT	ALUMINUM	S1	N/A	
130	4'-0"	7'-0"	1 3/4"	HOLLOW METAL	PAINTED	1/4" TEMPERED	D4	N/A	HOLLOW METAL	PAINTED	F2	N/A	
131A	3'-0"	7'-0"	1 3/4"	SC WOOD	PAINTED	1/4" TEMPERED	D2	N/A	HOLLOW METAL	PAINTED	F1	N/A	
131B	3'-0"	7'-0"	1 3/4"	SC WOOD	PAINTED	1/4" TEMPERED	D2	N/A	HOLLOW METAL	PAINTED	F1	N/A	
132	3'-0"	7'-0"	1 3/4"	SC WOOD	PAINTED	1/4" TEMPERED	D4	N/A	HOLLOW METAL	PAINTED	F4	N/A	
133	3'-0"	7'-0"	1 3/4"	SC WOOD	PAINTED	1/4" TEMPERED	D2	N/A	HOLLOW METAL	PAINTED	F1	N/A	
134	3'-0"	7'-0"	1 3/4"	ALUM. STOREFRONT	ALUMINUM	1/4" TEMPERED	D2	N/A	ALUM. STOREFRONT	PAINTED	F1	N/A	
137	3'-0"	7'-0"	1 3/4"	SC WOOD	PAINTED	1/4" TEMPERED	D2	N/A	HOLLOW METAL	PAINTED	F4	N/A	
138A	3'-0"	7'-0"	1 3/4"	SC WOOD	PAINTED	1/4" TEMPERED	D4	N/A	HOLLOW METAL	PAINTED	F4	N/A	
138B	6'-0"	7'-0"	1 3/4"	HOLLOW METAL	PAINTED	N/A	D5	N/A	HOLLOW METAL	PAINTED	F1	N/A	
139	3'-0"	7'-0"	1 3/4"	SC WOOD	PAINTED	1/4" TEMPERED	D2	N/A	HOLLOW METAL	PAINTED	F1	N/A	
140	3'-0"	7'-0"	1 3/4"	SC WOOD	PAINTED	1/4" TEMPERED	D2	N/A	HOLLOW METAL	PAINTED	F1	N/A	
202	3'-0"	7'-0"	1 3/4"	HOLLOW METAL	PAINTED	N/A	D1	N/A	HOLLOW METAL	PAINTED	F2	N/A	
205	3'-0"	7'-0"	1 3/4"	HOLLOW METAL	PAINTED	N/A	D1	N/A	HOLLOW METAL	PAINTED	F2	N/A	
206	6'-0"	7'-0"	1 3/4"	HOLLOW METAL	PAINTED	N/A	D5	N/A	HOLLOW METAL	PAINTED	F2	N/A	
EX104B	3'-0"	7'-0"	1 3/4"										
EX118D	6'-0"	7'-0"	1 3/4"										
EX122	3'-0"	7'-0"	1 3/4"										
EX123	3'-0"	7'-0"	1 3/4"										
EX125	4'-0"	6'-8"	1 3/4"										
EX128	2'-8"	6'-8"	1 3/4"										
EX129	2'-8"	6'-8"	1 3/4"										
EX132	2'-8"	6'-8"	1 3/4"										
EX132A	3'-0"	7'-0"	1 3/4"										
EX133	2'-8"	6'-8"	1 3/4"										
EX135	3'-0"	7'-0"	1 3/4"										
EX136	3'-0"	7'-0"	1 3/4"										




**DOOR - ELEVATIONS**  
1/4" = 1'-0"

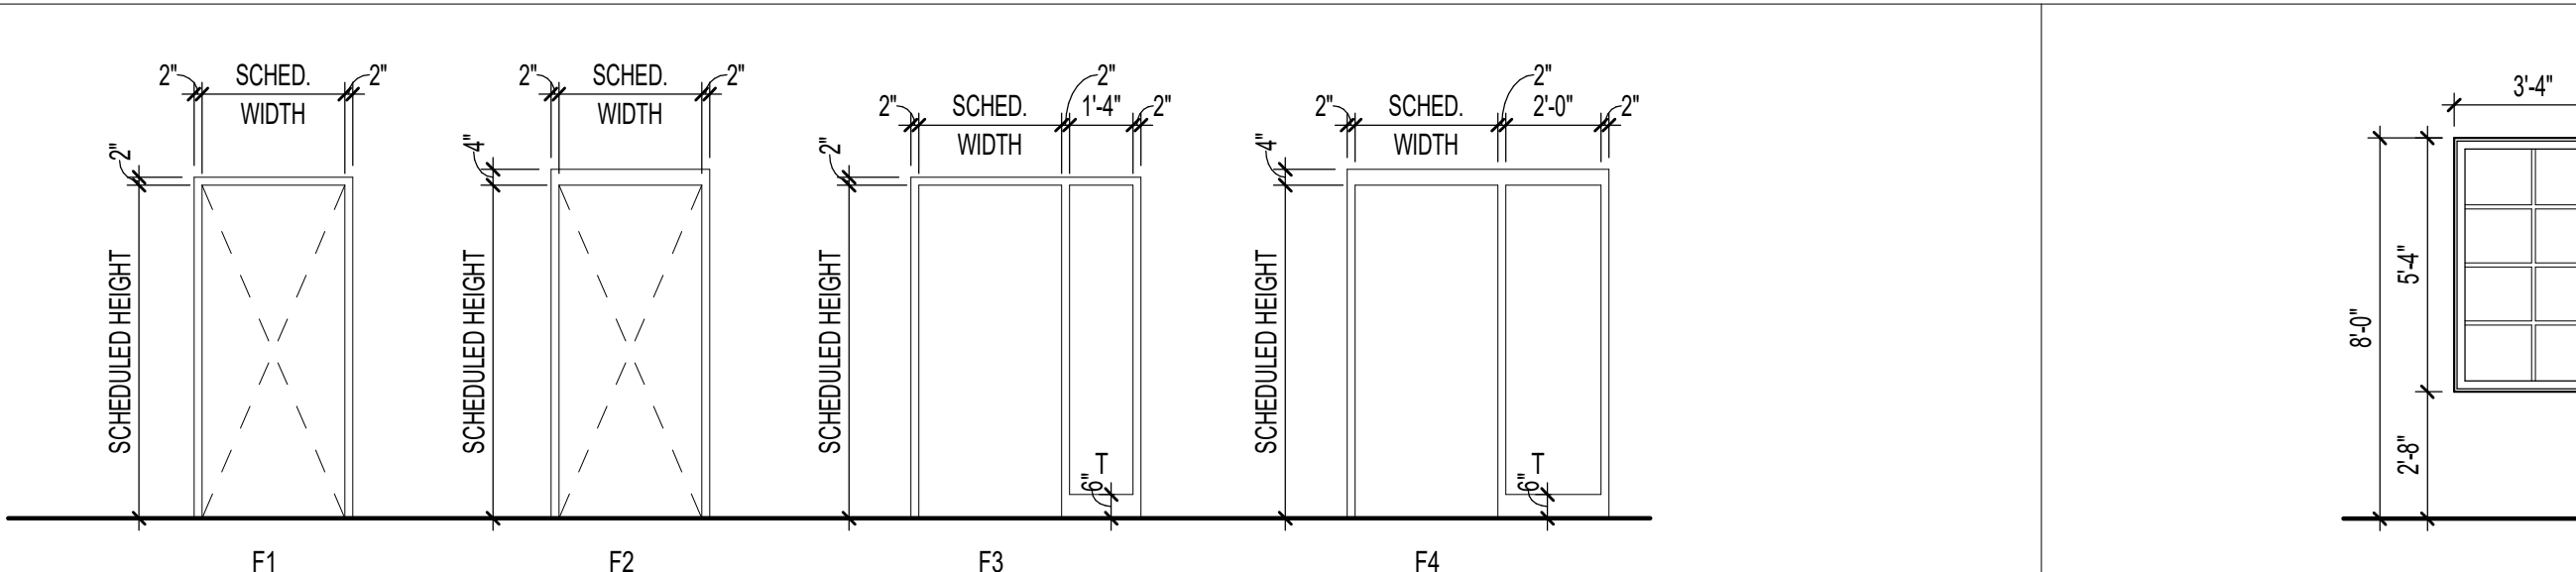


**FRAME - ELEVATIONS**  
1/4" = 1'-0"

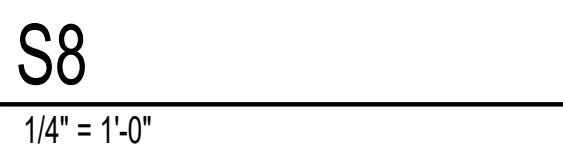


**S8**  
1/4" = 1'-0"

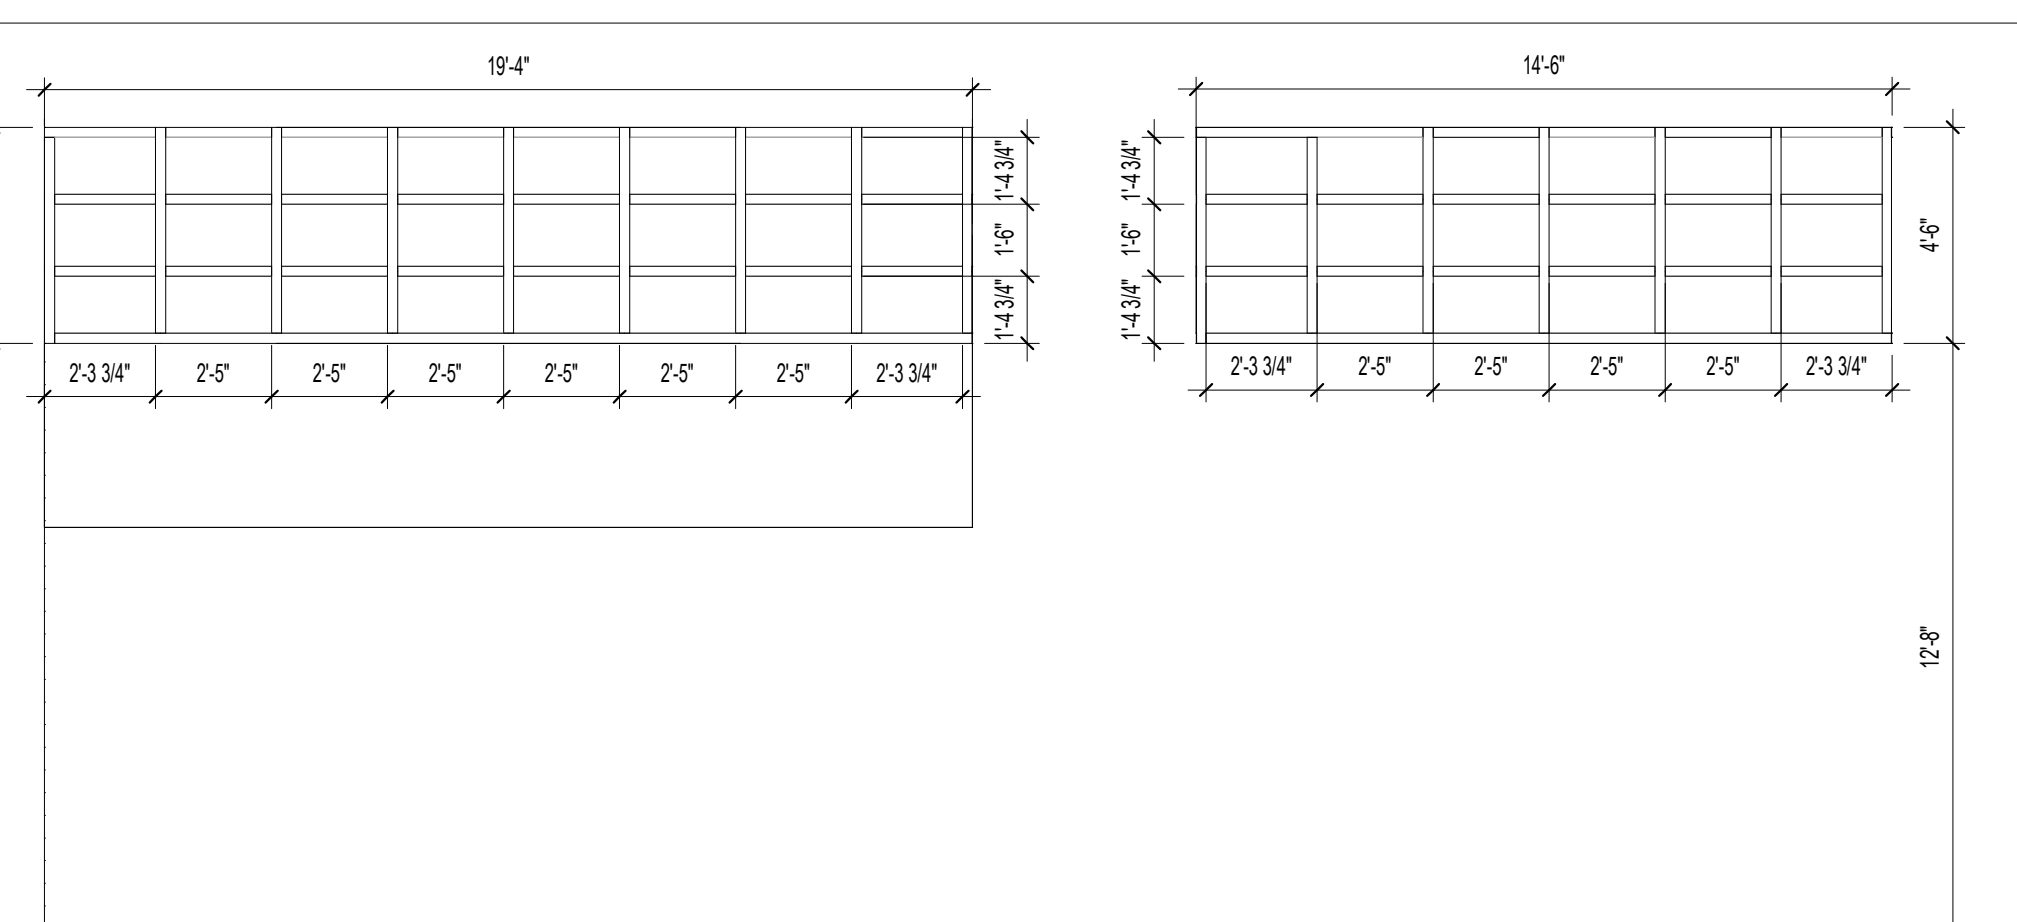


**S7**  
1/4" = 1'-0"

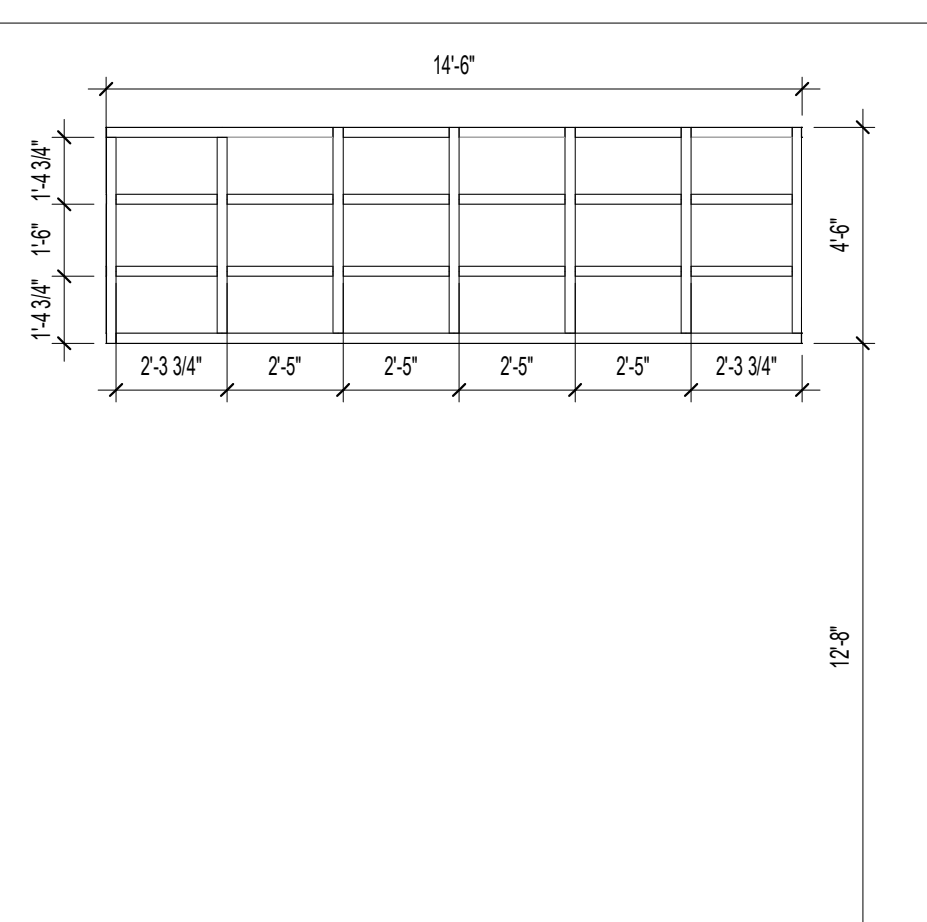


**S6**  
1/4" = 1'-0"

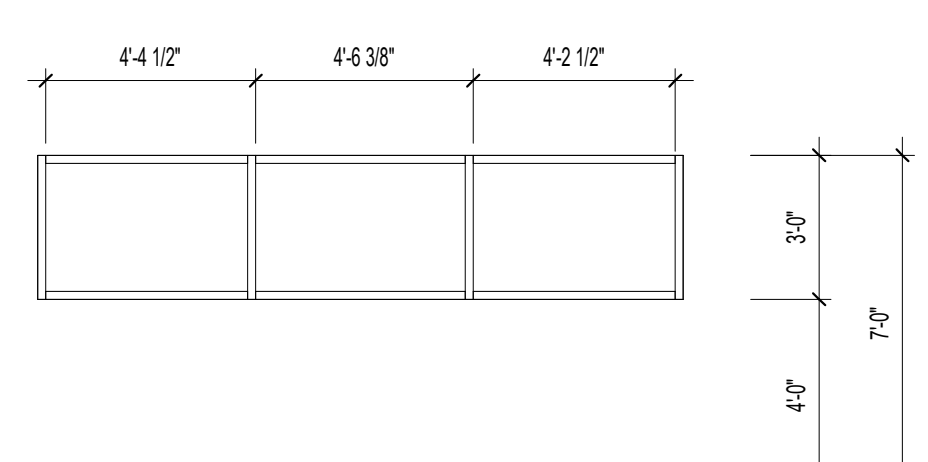


**S5**  
1/4" = 1'-0"

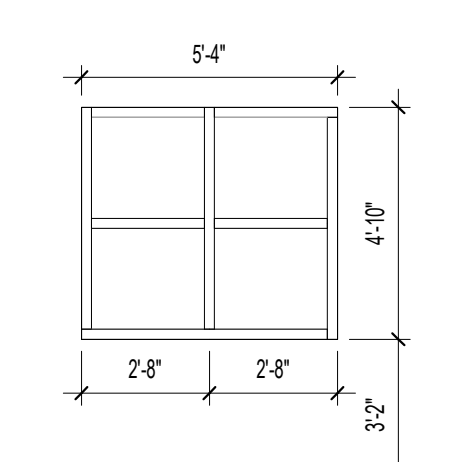


**S4**  
1/4" = 1'-0"

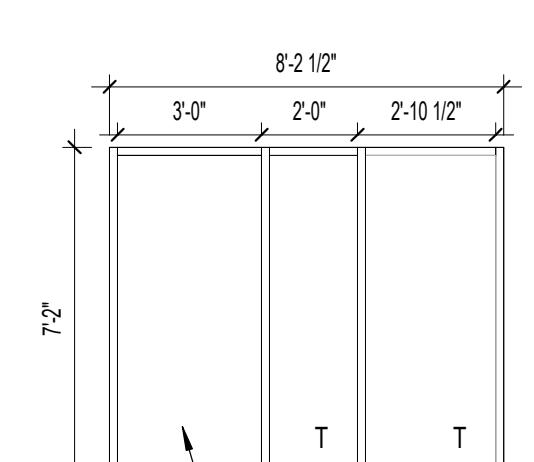

**S3**  
1/4" = 1'-0"

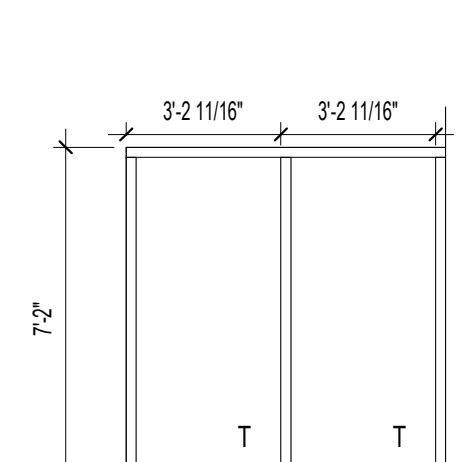

**S2**  
1/4" = 1'-0"

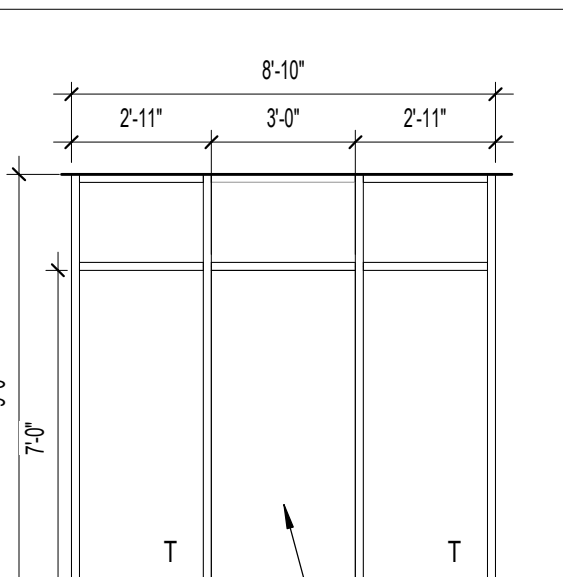

**S1**  
1/4" = 1'-0"

**GENERAL DOOR NOTES**

- ALL HARDWARE SHALL MEET ALL APPLICABLE CODES.
- TEMPERED GLAZING SHALL BE USED AS NOTED AND AS REQUIRED BY CODE.
- EXTERIOR DOOR GLAZING SHALL BE 5/8" TEMPERED INSULATED, TYPICAL, U.N.O.
- EXTERIOR DOOR GLAZING SHALL BE TINTED TO MATCH PROJECT FENESTRATION, TYP.
- FURNISH AND INSTALL DOOR CLOSERS AS SCHEDULED & AS PER APPLICABLE CODES.
- ALL HOLLOW METAL DOOR FRAMES SHALL BE FULLY WELDED TYPE, FACTORY PRIMED, AND FIELD PAINTED. COLOR PER ARCHITECT. INSTALL PER MANUFACTURER FOR PROPER INSTALLATION AND OPERATION FOR SPECIFIC APPLICATIONS.
- ALL WOOD DOORS SHALL BE PAINT GRADE, SPECIES AND COLOR PER ARCHITECT (PROJECT SPECIFICATIONS).
- ALL ALUMINUM STOREFRONT WINDOWS AND DOORS SHALL BE PREFINISHED COLOR (BY ARCHITECT) FROM MANUFACTURER'S RANGE OF COLORS.
- DOOR THRESHOLDS SHALL BE 1 1/2" MAXIMUM HEIGHT.
- ALL EXISTING DOORS, ASSOCIATED DOOR HARDWARE, AND FRAMES TO REMAIN SHALL BE ACCESSED PRIOR TO RENOVATION. ALL EXISTING DOORS, DOOR HARDWARE, AND FRAMES TO REMAIN SHALL BE CLEANED & REFURNISHED TO MATCH PROJECT STANDARDS.

**WINDOW NOTES**



- ALL EXTERIOR STOREFRONT GLAZING SHALL BE 1" INSULATED GLASS LITE WITH TINTED GLASS AS NOTED IN SCHEDULE, TYP.
- PROVIDE ALL NECESSARY FRAME ANCHORS AS REQUIRED FOR SPECIFIC INSTALLATIONS.
- ALL GLAZING WITHIN 24" OF VERTICAL EDGE OF DOORS SHALL BE TEMPERED. TEMPERED GLAZING SHALL BE USED AS NOTED AND AS REQUIRED BY CODE.
- ALL FRAMING SYSTEMS SHALL BE DESIGNED, ENGINEERED AND FABRICATED BY THE SYSTEM MANUFACTURER TO MEET ALL APPLICABLE CODES. SHOP DRAWINGS SHALL BE SUBMITTED FOR REVIEW PRIOR TO FABRICATION.
- ALL FRAMING DIMENSIONS AS SHOWN ARE ROUGH OPENING DIMENSIONS. CONTRACTOR SHALL VERIFY AND BE RESPONSIBLE FOR EXACT FINISH DIMENSION AT JOB SITE PRIOR TO FABRICATION.
- HORIZONTAL LOWER BLINDS SHALL BE FURNISHED AND INSTALLED ON AT EXTERIOR WINDOWS.

**LEGEND**

HR	INTERIOR HOLLOW METAL WINDOW ASSEMBLY, SEE SPECIFICATION.
WF	EXTERIOR HOLLOW METAL WINDOW ASSEMBLY, SEE SPECIFICATION.
SF	INTERIOR ALUMINUM STOREFRONT
CF	ALUMINUM CURTAIN WALL

**GLAZING**

IG	INSULATED GLASS
SG	SAFETY GLASS
RSG	RATED SAFETY GLASS
IG-1	TINTED
IG-2	TINTED TEMPERED
IG-4	TINTED LAMINATED
IG-5	SPANDREL
SG-CG	CLEAR
SG-CT	CLEAR, TEMPERED
SG-FT	FROSTED, TEMPERED


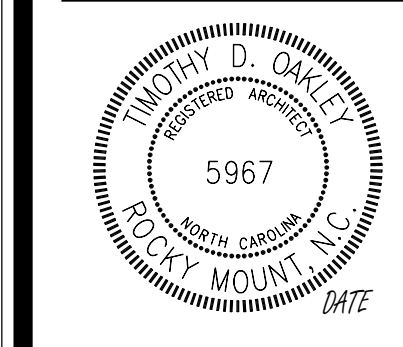
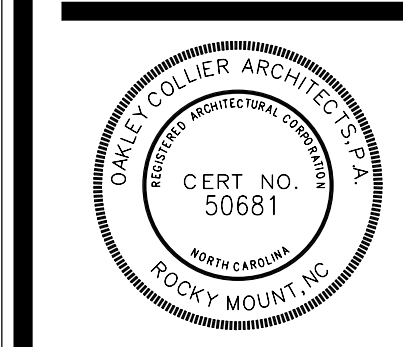


GENERAL NOTE:  
Prior to construction start, Contractor shall verify & be responsible for all Dimensions.

Revisions	Description	Date
1	BD ADD: 1	11/09/2024
2	BD ADD: 2	11/07/2024

Date	10/30/2024	Project No.	24002
Drawn By	RL	Sheet No.	A6.1
Checked By	DG	Sheet Title	DOOR AND WINDOW SCHEDULE

Copyright © 2023 Oakley Collier Architects. These drawings are of the property of the Architect for use under his supervision. No reproduction or other use is allowed without permission.

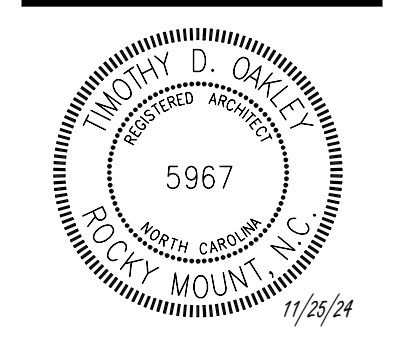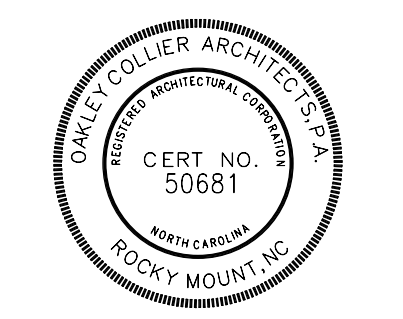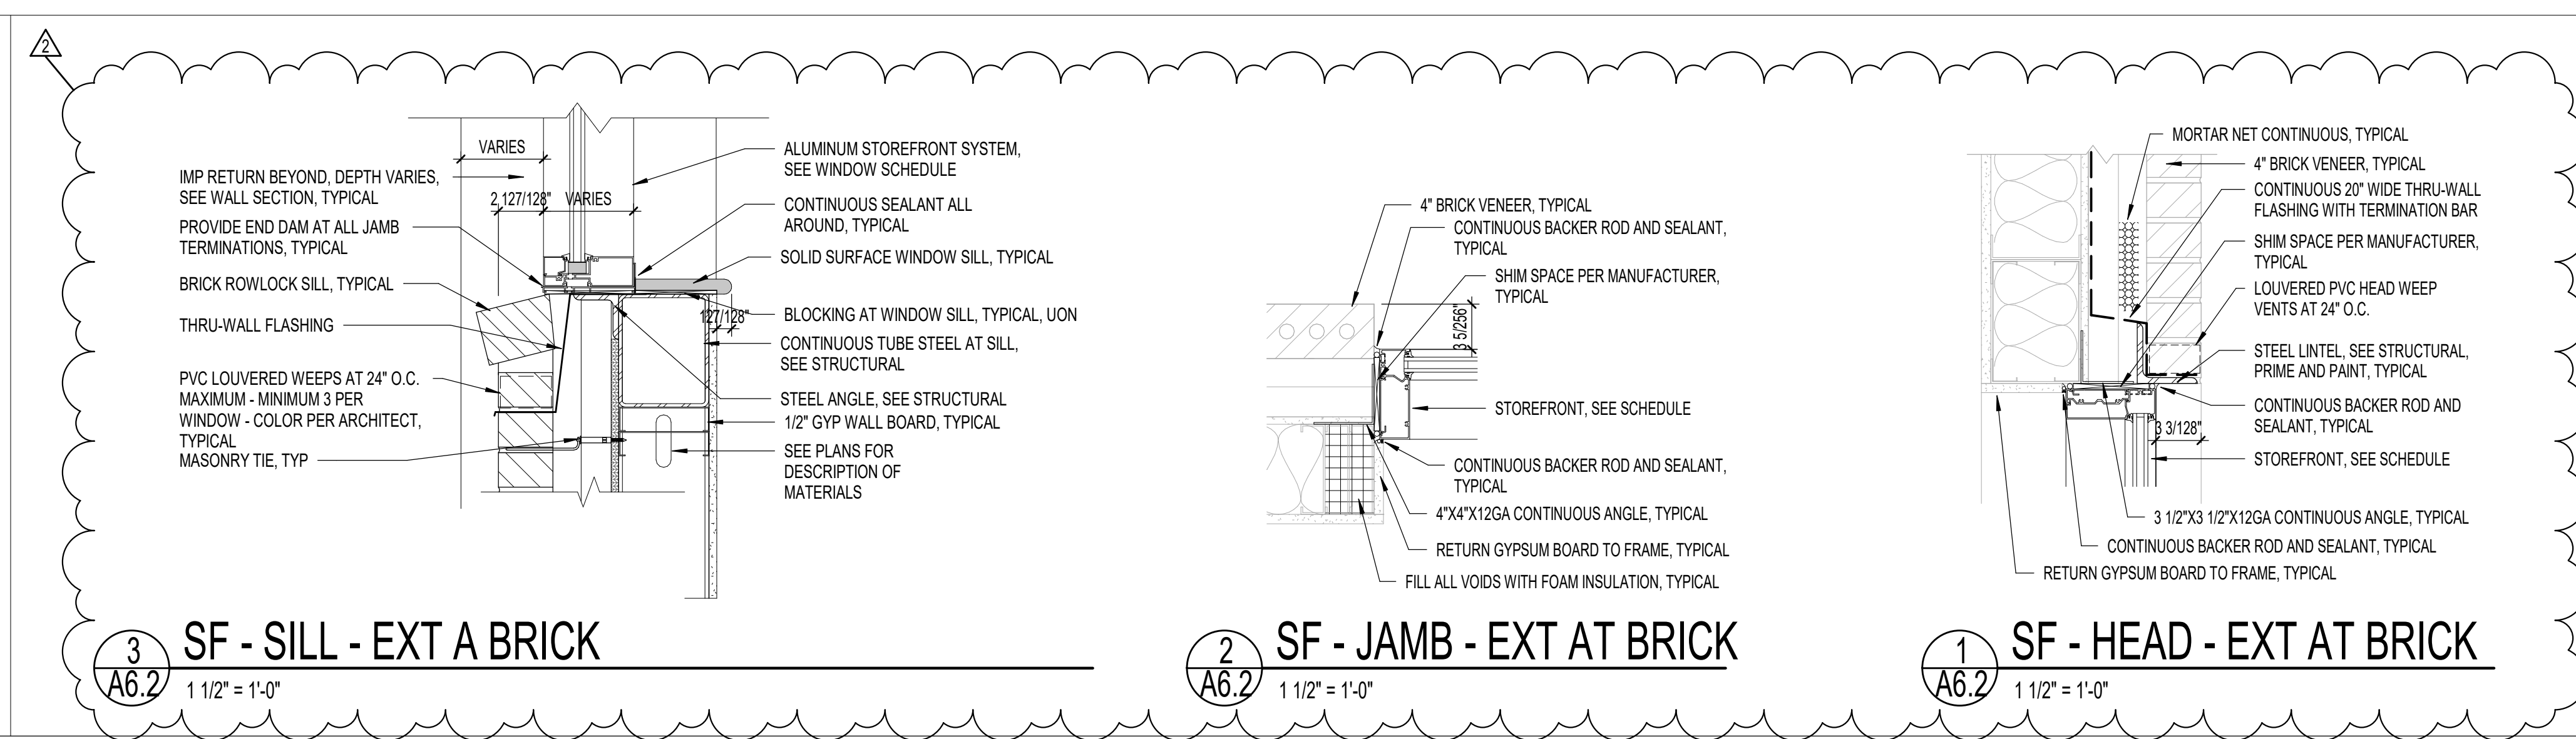

**GENERAL NOTE:**  
Prior to construction start, Contractor shall verify & be responsible for all Dimensions.

Revisions	Description	Date
2	BD ADD: 2	11/07/2024

Date	Project No.
10/30/2024	<b>24002</b>
Author	Sheet No.
Checked By	<b>A6.2</b>
Checker	Sheet Title
	<b>DOOR AND WINDOW DETAILS</b>